
# MOUNTING HEIGHTS

F/A PULL STA. MAIN PANEL BOX 5'-O" PIEE ALARM STROBE 80'

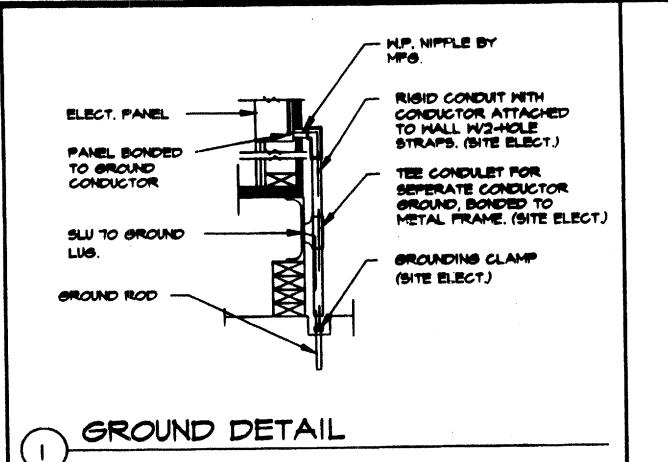

#### SCHOOL EQUIPMENT ANCHORAGE

THE POLLOHING IS FOR THE ARCHITECTS INFORMATION ONLY:

THE SEISMIC ANCHORAGE OF ELECTRICAL EQUIPMENT SHALL CONFORM TO C.C.R. TITLE 24, SECTION 2912 (g) AND TABLE 29-P. ANCHORAGE DETAILS FOR ROOF/PLOOR MOUNTED EQUIPMENT WEIGHING LESS THAN 400 LBS. AND HING EQUIPMENT MEIGHING LESS THAN 20 LBS. MAY BE OMITTED FROM THE PLANS.

FOR ELECTRICAL DRAWINGS:

ALL ELECTRICAL EQUIPMENT SHALL BE BRACED OR ANCHORED TO RESIST A HORZONTAL FORCE ACTING IN ANY DIRECTION USING THE FOLLOWING CRITERIA:

20% OF OPERATING HEIGHT

50% OF OPERATING WEIGHT

FOR PLEXIBLY MOUNTED EQUIPMENT USE 4 X THE ABOVE VALUES, AND FOR SIMULTANEOUS VERTICAL FORCE USE 1/5 X THE HORIZONTAL FORCE. THE ABOVE VALUES ARE FOR AN IMPORTANCE FACTOR, I=1.0 AND SEISMIC ZONE, Z=0.4.

where anchorage details are not shown on the dramings the field installation shall be subject to the approval of the architect and the field engineer of the office of the state architect.


## **KEY NOTES**

- ELECTRICAL PANEL
- (2) EXHAUST FAN
- (3) FIRE ALARM HORN
- 4 FIRE ALARM PULL STATION
- (5) INCANDESCENT BRACKET LIGHT FIXTURE
- (6) "k" SWITCH (KEYED) +48"

**GENERAL NOTES** 


ICU, PART B.

(7) STROBE LIGHTS MNT D +80"

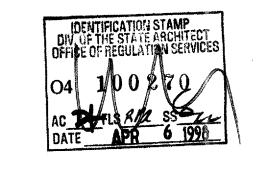


#### FEED: BOTTOM PANEL: VDLTS: 120/240 V MOUNTING: LOCATION: MAIN: 100 A # BREAKER WATTS Amps P Ag Bg LIGHTS INT/EXT & EX. FAN 2 20 1680 RECEPT 680 LIGHTS INT/EXT 4 EX. FAN 4 20 1 RECEPT 680 680 B = 860 WATTS/PHASE WATTS/PHASE A = 860 WATTS (8.5) 9 AMPS 120/240 VOLTS

NCL = 360

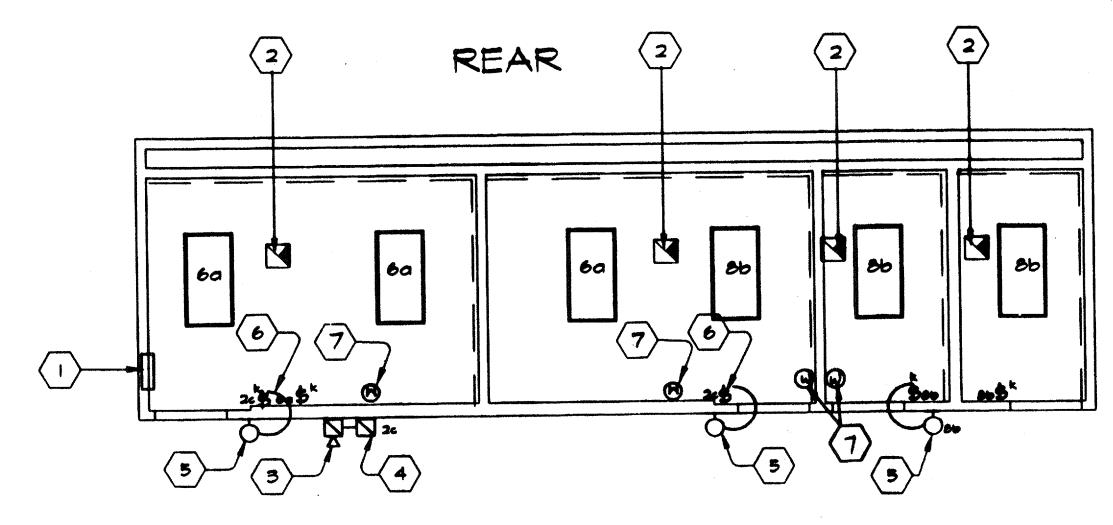

FRONT

### REAR

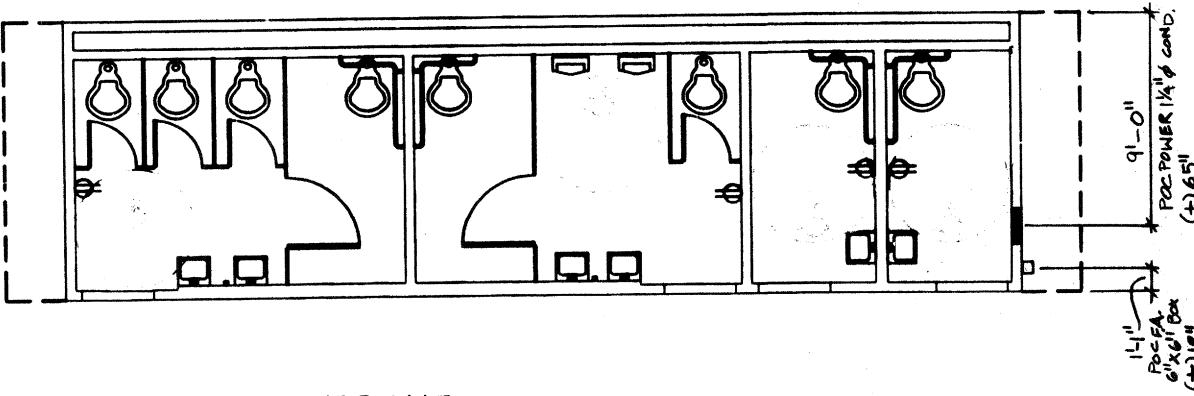

FRONT

LIGHTING/POWER/SIGNAL PLAN

SCALE 1/4" = 1'-0"

JOB# 2724 # 2818-C ANAHEM U.H.S.D.

JOB #

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CLLS.036

ELECTRICAL PLAN

i. Each building shall be separately grounded with a 3/4" RD.X6' COPPERCLAD STEEL GROUND ROD. WHERE ROCK BOTTOM IS INCOUNTERED, ROD SHALL BE DRIVEN AT AN ANGLE NOT TO EXCEED 45 DEGREE'S FROM THE VERTICAL OR SHALL BE BURIED IN A TRENCH THAT IS AT

2. TESTING: TEST FOR RESISTANCE TO GROUND, IF RESISTANCE EXCEEDS 25 OHMS, INSTALL ADDITIONAL GROUND RODS SEPERATED AT LEAST 6'-O" UNTIL RESISTANCE IS REDUCED TO 25 OHMS OR LESS. (BY SITE ELECTRICAL)

3. PROVIDE EQUIPMENT ANCHORAGE PER TITLE 24, TABLE

APPROVAL OF THIS FIRE ALARM FOR ALL SITES. THE FIRE ALARM SYSTEM AND/OR COMPONENTS MAYBE REGUIRED TO BE CHANGED DUE TO SITE LOCATION, EXISTING CONDITIONS OR INCOMPATABLE COMPONENTS.

PROJECT INSPECTOR GROUNDING SHALL BE IN AGO DEPANCE W/C.E.G. LITTIGLE 250

7. ALL HIRING SHALL BE 75° CENTIGRADE OR CALCULATE

DERATION FOR AMBIENT TEMPERATURE

GROUND MG TEST SHALL BE DONE IN THE PRESENCE OF THE

ELECTRICIAN SHALL PROVIDE 2-12 GA. SLACK WIRES TO TO HOUSING OF ALL LIGHT FIXTURES & DIAGONAL CORNERS WIRES SHALL BE ATTACHED TO STRUCTURE, SEE SHT.

4. APPROVAL OF THIS PLAN DOSE NOT CONSTITUTE


LEAST SO" DEEP. (BY SITE ELECTRICAL)

ELECTRICAL ARCHITECT

MECHANICAL STRUCTURAL

ACCESS COMPLIANCE FIRE MARSHAL

STRUCTURAL SAFETY

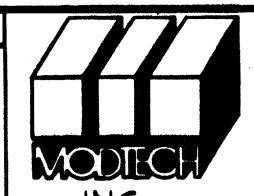

(CLASS LEASING)

drawn by dt.

CHECKED BY