NOTE: SOME CODES MAY NOT APPLY IF WORK REGULATED BY SUCH CODES IS NOT WITHIN THE SCOPE OF THIS PROJECT.

WHICH RELATES TO EACH KEYNOTE.


C 18079 License Number

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BAKERSFIELD CITY SCHOOL DISTRICT

93-117549

AC FLS SS TN

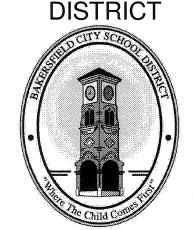

CHIPMAN JR. HIGH NEW RELOCATABLES (3)

> 2905 EISSLER ST BAKERSFIELD, CA 93306

OPSC or OSHPD PROJ. NO: PROJECT NO 16166.000 DRAWN BY: rRr RM CHK'D BY: ISSUE DATE: 10/05/2016 SHEET TITLE

TITLE SHEET

SHEET NUMBER

AUBURN AVE

GENERAL NOTES

- 1. ALL CONSTRUCTION SHALL CONFORM TO THIS PLAN, THE CALIFORNIA BUILDING CODE, AND STANDARDS PERTAINING THERETO. THESE DOCUMENTS SHALL BE MADE A PART HEREOF.
- 2. THE CONTRACTOR IS RESPONSIBLE FOR VERIFYING DIMENSIONS. DATA AND MEASUREMENTS AT THE BUILDING SITE PRIOR TO CONSTRUCTION. DO NOT SCALE DRAWINGS. WRITTEN DIMENSIONS ON THESE DRAWINGS SHALL HAVE PRECEDENCE OVER SCALED DIMENSIONS. PORTER & ASSOCIATES, INC. MUST BE NOTIFIED OF ANY VARIATIONS FROM THE DIMENSIONS AND CONDITIONS SHOWN BY THESE DRAWINGS.
- 3. EXISTING UTILITY AND UNDERGROUND LINES HAVE BEEN SHOWN ON THIS PLAN ACCORDING TO AVAILABLE RECORDS. THE ENGINEER IS NOT RESPONSIBLE FOR POSSIBLE ERRORS OR OMISSIONS. THE CONTRACTOR IS RESPONSIBLE FOR VERIFICATION OF THE LOCATION AND DEPTH OF ALL UTILITIES PRIOR TO BEGINNING OF ANY WORK. UNDERGROUND SERVICE ALERT (U.S.A.: 1-800-227-2600) SHALL BE CONTACTED AT LEAST TWO WORKING DAYS PRIOR TO ANY CONSTRUCTION OR EXCAVATION.
- 4. ANY EXISTING IMPROVEMENTS OR UTILITIES THAT ARE REMOVED, DAMAGED OR UNDERCUT BY CONTRACTOR'S OPERATIONS SHALL BE REPAIRED OR REPLACED AT THE CONTRACTOR'S EXPENSE, AS DIRECTED BY THE ENGINEER AND APPROVED BY THE GOVERNING AUTHORITY.
- 5. IF A PROBLEM OR CONFLICT SHOULD ARISE DURING THE COURSE OF THE PROJECT, IT IS THE RESPONSIBILITY OF THE OWNER OR THE CONTRACTOR TO NOTIFY THE ENGINEER IMMEDIATELY PRIOR TO ANY FURTHER WORK.
- 6. THE CONTRACTOR SHALL FURNISH ALL LABOR, MATERIALS, TOOLS, EQUIPMENT AND SUPERVISION NECESSARY FOR A COMPLETE AND FUNCTIONAL PRODUCT.
- 7. ALL WORK WHICH IS DEFECTIVE IN ITS CONSTRUCTION OR DEFICIENT IN ANY OF THE REQUIREMENTS OF THESE DRAWINGS AND SPECIFICATIONS SHALL BE REMEDIED, OR REMOVED AND REPLACED BY THE CONTRACTOR IN AN ACCEPTABLE MANNER, AND NO COMPENSATION WILL BE ALLOWED FOR SUCH CORRECTION.
- 8. IN THE EVENT CONSTRUCTION STAKING BASED ON THE CONSULTANT'S PLANS, DRAWINGS OR OTHER DOCUMENTS IS ACCOMPLISHED BY ANYONE OTHER THAN THE CONSULTANT, THE OWNER OR CONTRACTOR SHALL NOTIFY THE BUILDING OFFICIAL IN WRITING AS TO THE CHANGE OF ENGINEER IN RESPONSIBLE CHARGE.
- 9. THE CONTRACTOR AGREES THAT HE SHALL ASSUME SOLE AND COMPLETE RESPONSIBILITY FOR JOB SITE CONDITIONS DURING THE COURSE OF CONSTRUCTION OF THIS PROJECT; INCLUDING EROSION, SEDIMENTATION & DUST CONTROL PLAN AND STORM WATER POLLUTION PREVENTION PLAN IMPLEMENTATION AND THE SAFETY OF ALL PERSONS AND PROPERTY; THAT THIS REQUIREMENT SHALL APPLY CONTINUOUSLY AND NOT BE LIMITED TO NORMAL WORKING HOURS; AND THAT THE CONTRACTOR SHALL DEFEND, INDEMNIFY AND HOLD THE OWNER AND THE ENGINEER HARMLESS FROM ANY AND ALL LIABILITY, REAL OR ALLEGED, IN CONNECTION WITH THE PERFORMANCE OF WORK ON THIS PROJECT, EXCEPTING FOR LIABILITY ARISING FROM THE SOLE NEGLIGENCE OF THE OWNER OR THE ENGINEER.

GENERAL NOTES CONTINUED

- 10. IF THE CONTRACTOR IS IN DOUBT AS TO THE MEANING OF ANY PART OF THE DRAWINGS AND SPECIFICATIONS OR FINDS DISCREPANCIES IN OR OMISSIONS FROM THE DRAWINGS, HE SHALL SUBMIT A WRITTEN REQUEST FOR AN INTERPRETATION OR A CORRECTION THEREOF, PRIOR TO FILING HIS BID PRICE FOR THE PROJECT.
- 11. PORTER & ASSOCIATES, INC. WILL NOT BE RESPONSIBLE OR LIABLE FOR UNAUTHORIZED CHANGES TO OR USES OF THESE PLANS. ANY AND ALL CHANGES TO THESE PLANS MUST BE APPROVED IN WRITING BY PORTER

ACCESSIBILITY NOTES

GRADIENT.

- 1. ACCESSIBILITY NOTES ARE PROVIDED FOR REFERENCE ONLY. ALL WORK SHALL BE PERFORMED IN ACCORDANCE WITH APPLICABLE SECTIONS OF THE CALIFORNIA BUILDING CODE AND ADA STANDARDS. THE CONTRACTOR SHALL OBTAIN THE LATEST EDITION THEREOF.
- 2. CURB RAMPS SHALL BE 8.33% MAXIMUM GRADE. 3. PERPENDICULAR CURB RAMP SIDE SLOPES SHALL NOT EXCEED 10%
- 4. SURFACE SLOPE OF RAMPS SHALL NOT EXCEED 8.33%.
- 5. ACCESSIBLE ROUTE SLOPES SHALL NOT EXCEED 5%, UNLESS CONSTRUCTED AS A RAMP AND HANDRAILS ARE PROVIDED.
- 6. ACCESSIBLE ROUTE CROSS SLOPES SHALL NOT EXCEED 2%. 7. RAMP LANDINGS SHALL NOT EXCEED 2% MAXIMUM GRADE IN ANY DIRECTIONS.
- 8. GRATINGS LOCATED WITHIN ACCESSIBLE ROUTES SHALL HAVE MAXIMUM 1/2" OPENINGS IN THE DIRECTION OF PEDESTRIAN TRAVEL.
- 9. TRANSITIONS ALONG ACCESSIBLE ROUTES SHALL BE FLUSH WITH CHANGES IN LEVEL NO GREATER THAN 1/2". CHANGES IN LEVEL BETWEEN $\frac{1}{4}$ " and $\frac{1}{2}$ " shall be beveled with a minimum gradient of 1:2. CHANGES IN LEVEL BETWEEN O" AND 1/4" MAY BE VERTICAL.
- 10. EXCEPT BETWEEN SIDEWALKS AND ADJACENT STREETS OR DRIVEWAYS, ABRUPT CHANGES IN LEVEL EXCEEDING 4" ALONG A PATH OF TRAVEL SHALL BE PROTECTED BY A WARNING CURB A MINIMUM OF 6" IN HEIGHT ABOVE THE WALKWAY SURFACE. A WARNING CURB IS NOT REQUIRED WHEN A GUARD OR HANDRAIL IS PROVIDED WITH A GUIDE RAIL CENTERED 2" MINIMUM AND 4" MAXIMUM ABOVE THE WALKWAY SURFACE.
- 11. ALL ACCESSIBLE DOORS SHALL HAVE LEVEL LANDINGS IN ACCORDANCE WITH CALIFORNIA BUILDING CODE, CURRENT EDITION.
- 12. ACCESSIBLE PARKING STALLS AND LOADING AISLES SHALL NOT EXCEED 2% MAXIMUM GRADE IN ANY DIRECTION.

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ARCHITECTURE PLANNING

San Luis Obispo 4119 Broad Street, Suite 210 San Luis Obispo, CA 93401 805.546.0433 fax: 805.546.0504



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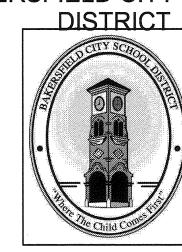
1200 21st Street, Bakersfield, California 93301

661.327.0362 FAX 661.327.1065

AGENCY INFORMATION:

AGENCY TRACKING NO. 63321-243 FILE NO. 15-6 IDENTIFICATION STAMP DIV. OF THE STATE ARCHITECT OFFICE OF REGULATION SERVICES 12-117549

BAKERSFIELD CITY SCHOOL



CHIPMAN JR. HIGH NEW RELOCATABLES (3)

> 2905 EISSLER ST BAKERSFIELD, CA 93306


> > 8/26/2016

OPSC or OSHPD PROJ. NO: 16166.000

ISSUE DATE: SHEET TITLE

> **GRADING PLAN** NOTES


SHEET NUMBER

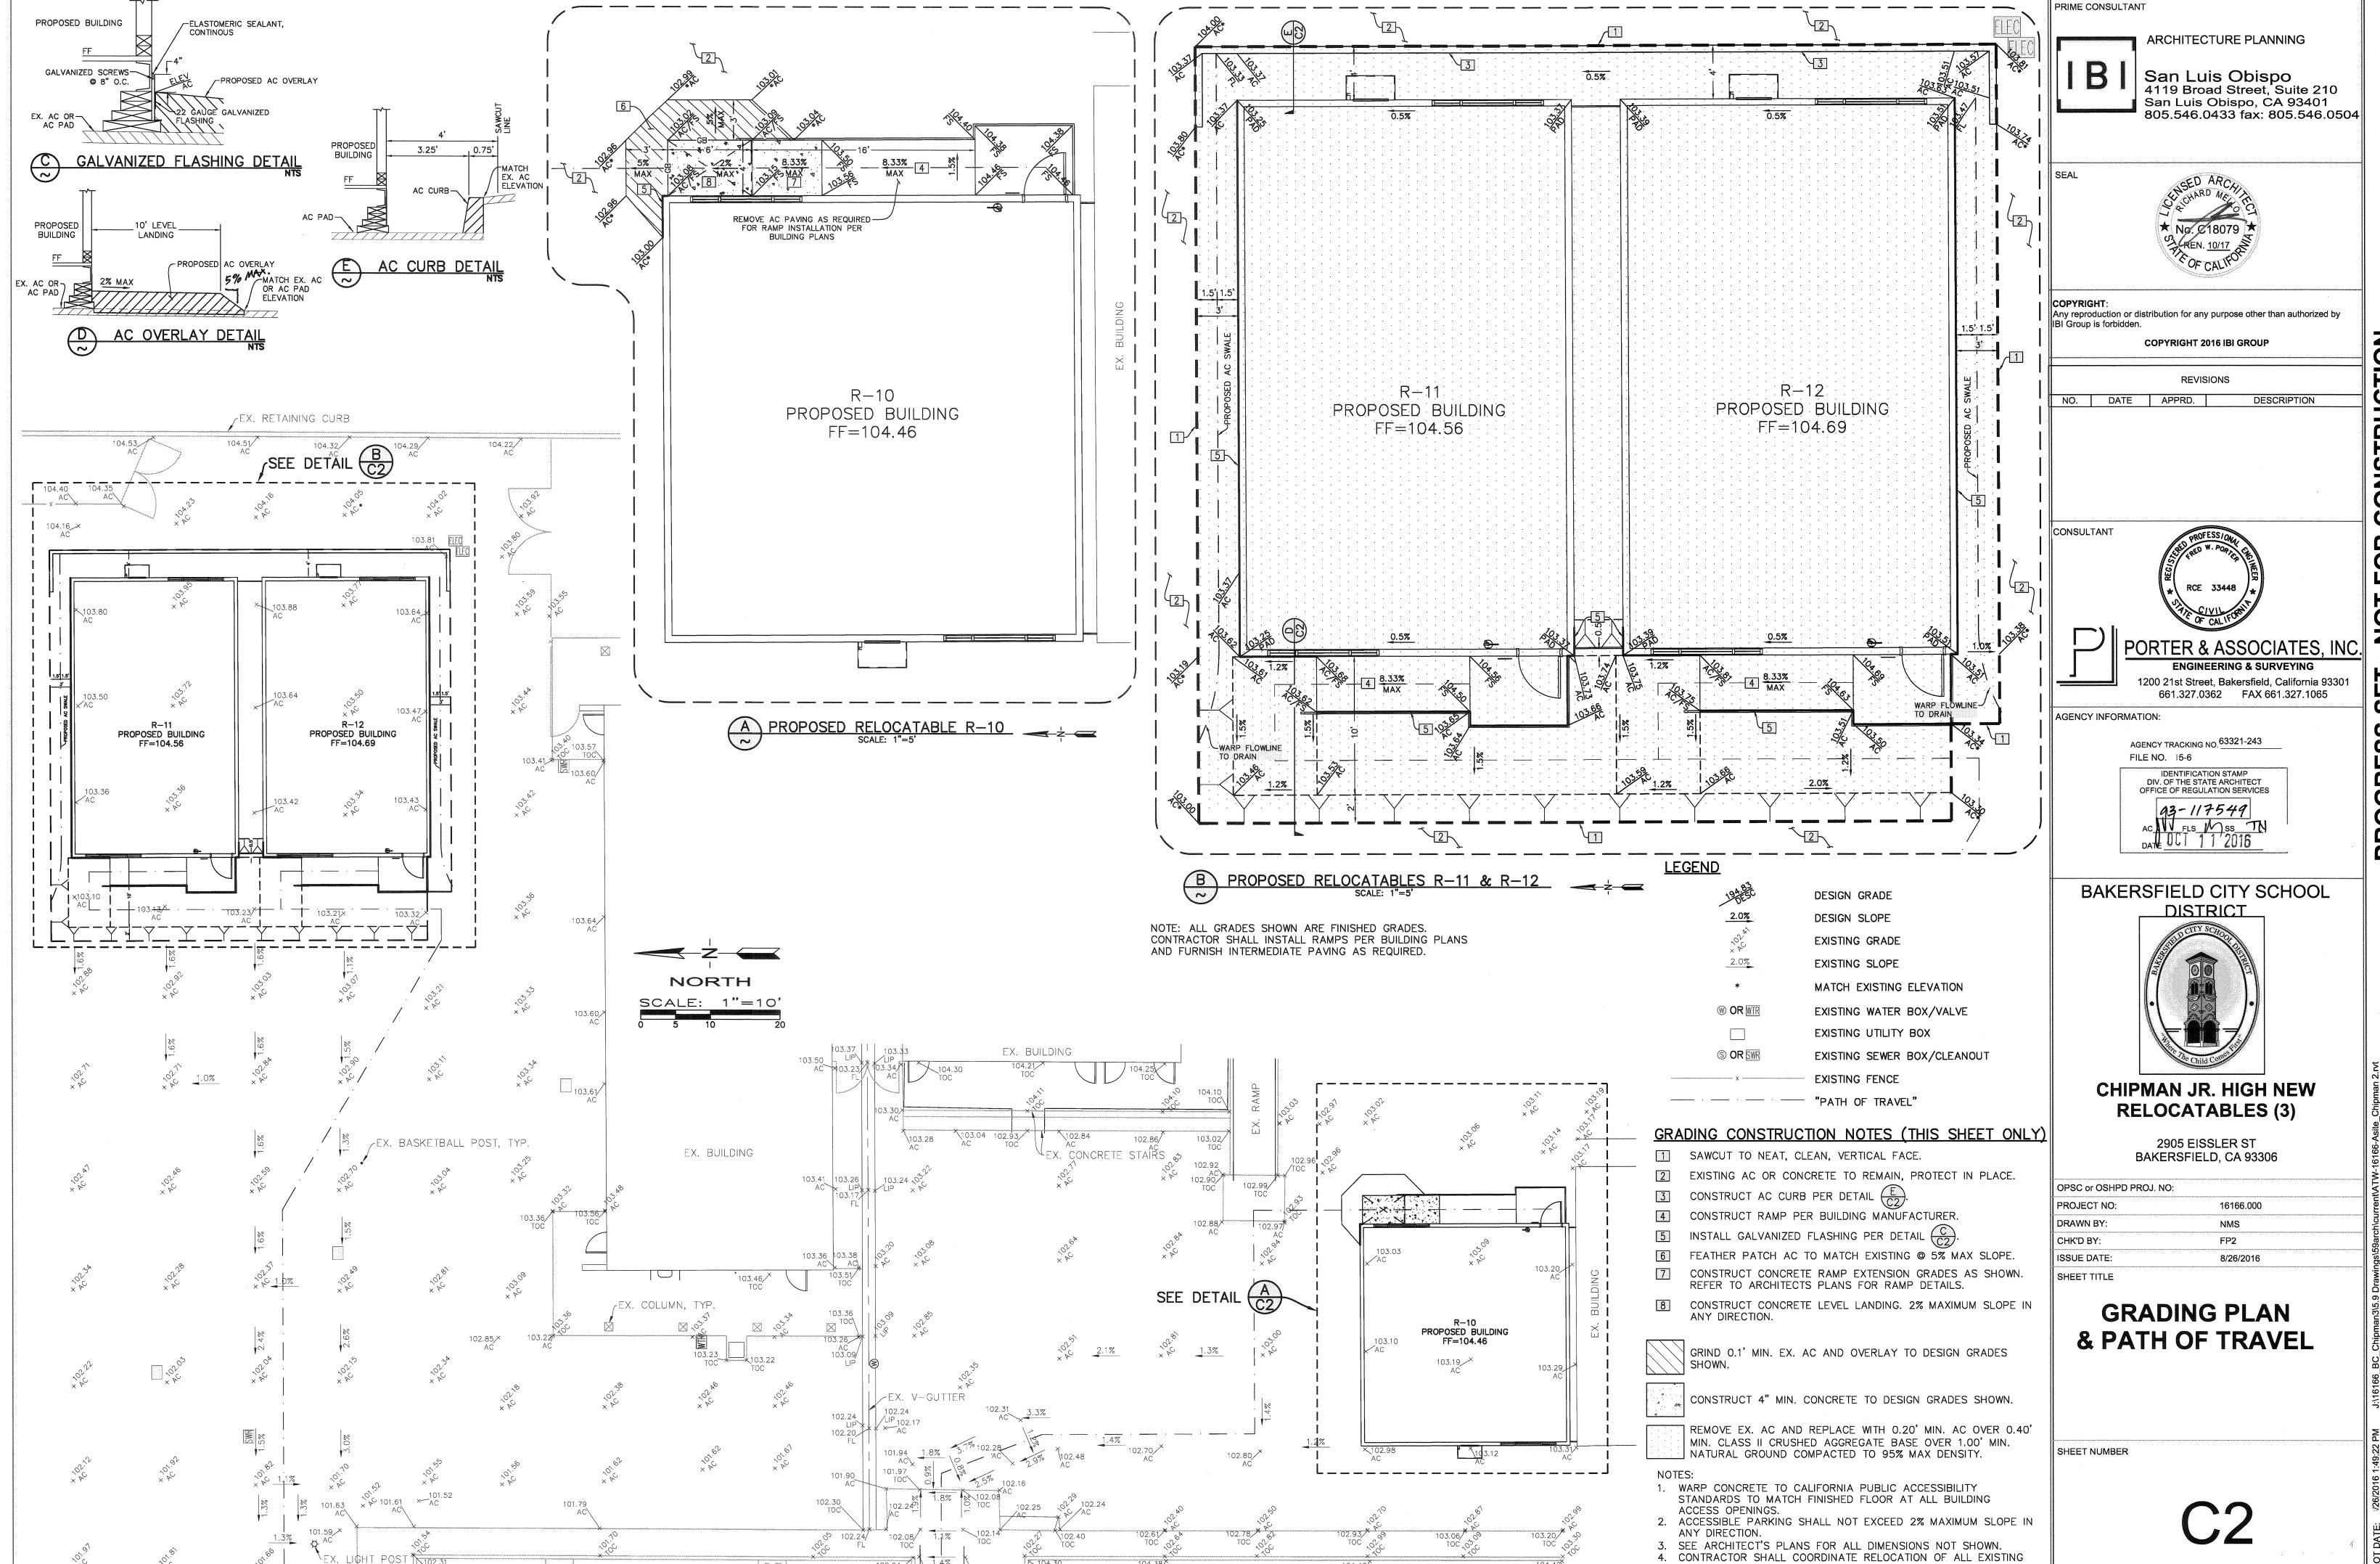

EX. PLANTER

EX. PLANTER

ROGRESS SET - NOT FOR CONSTRUCTION

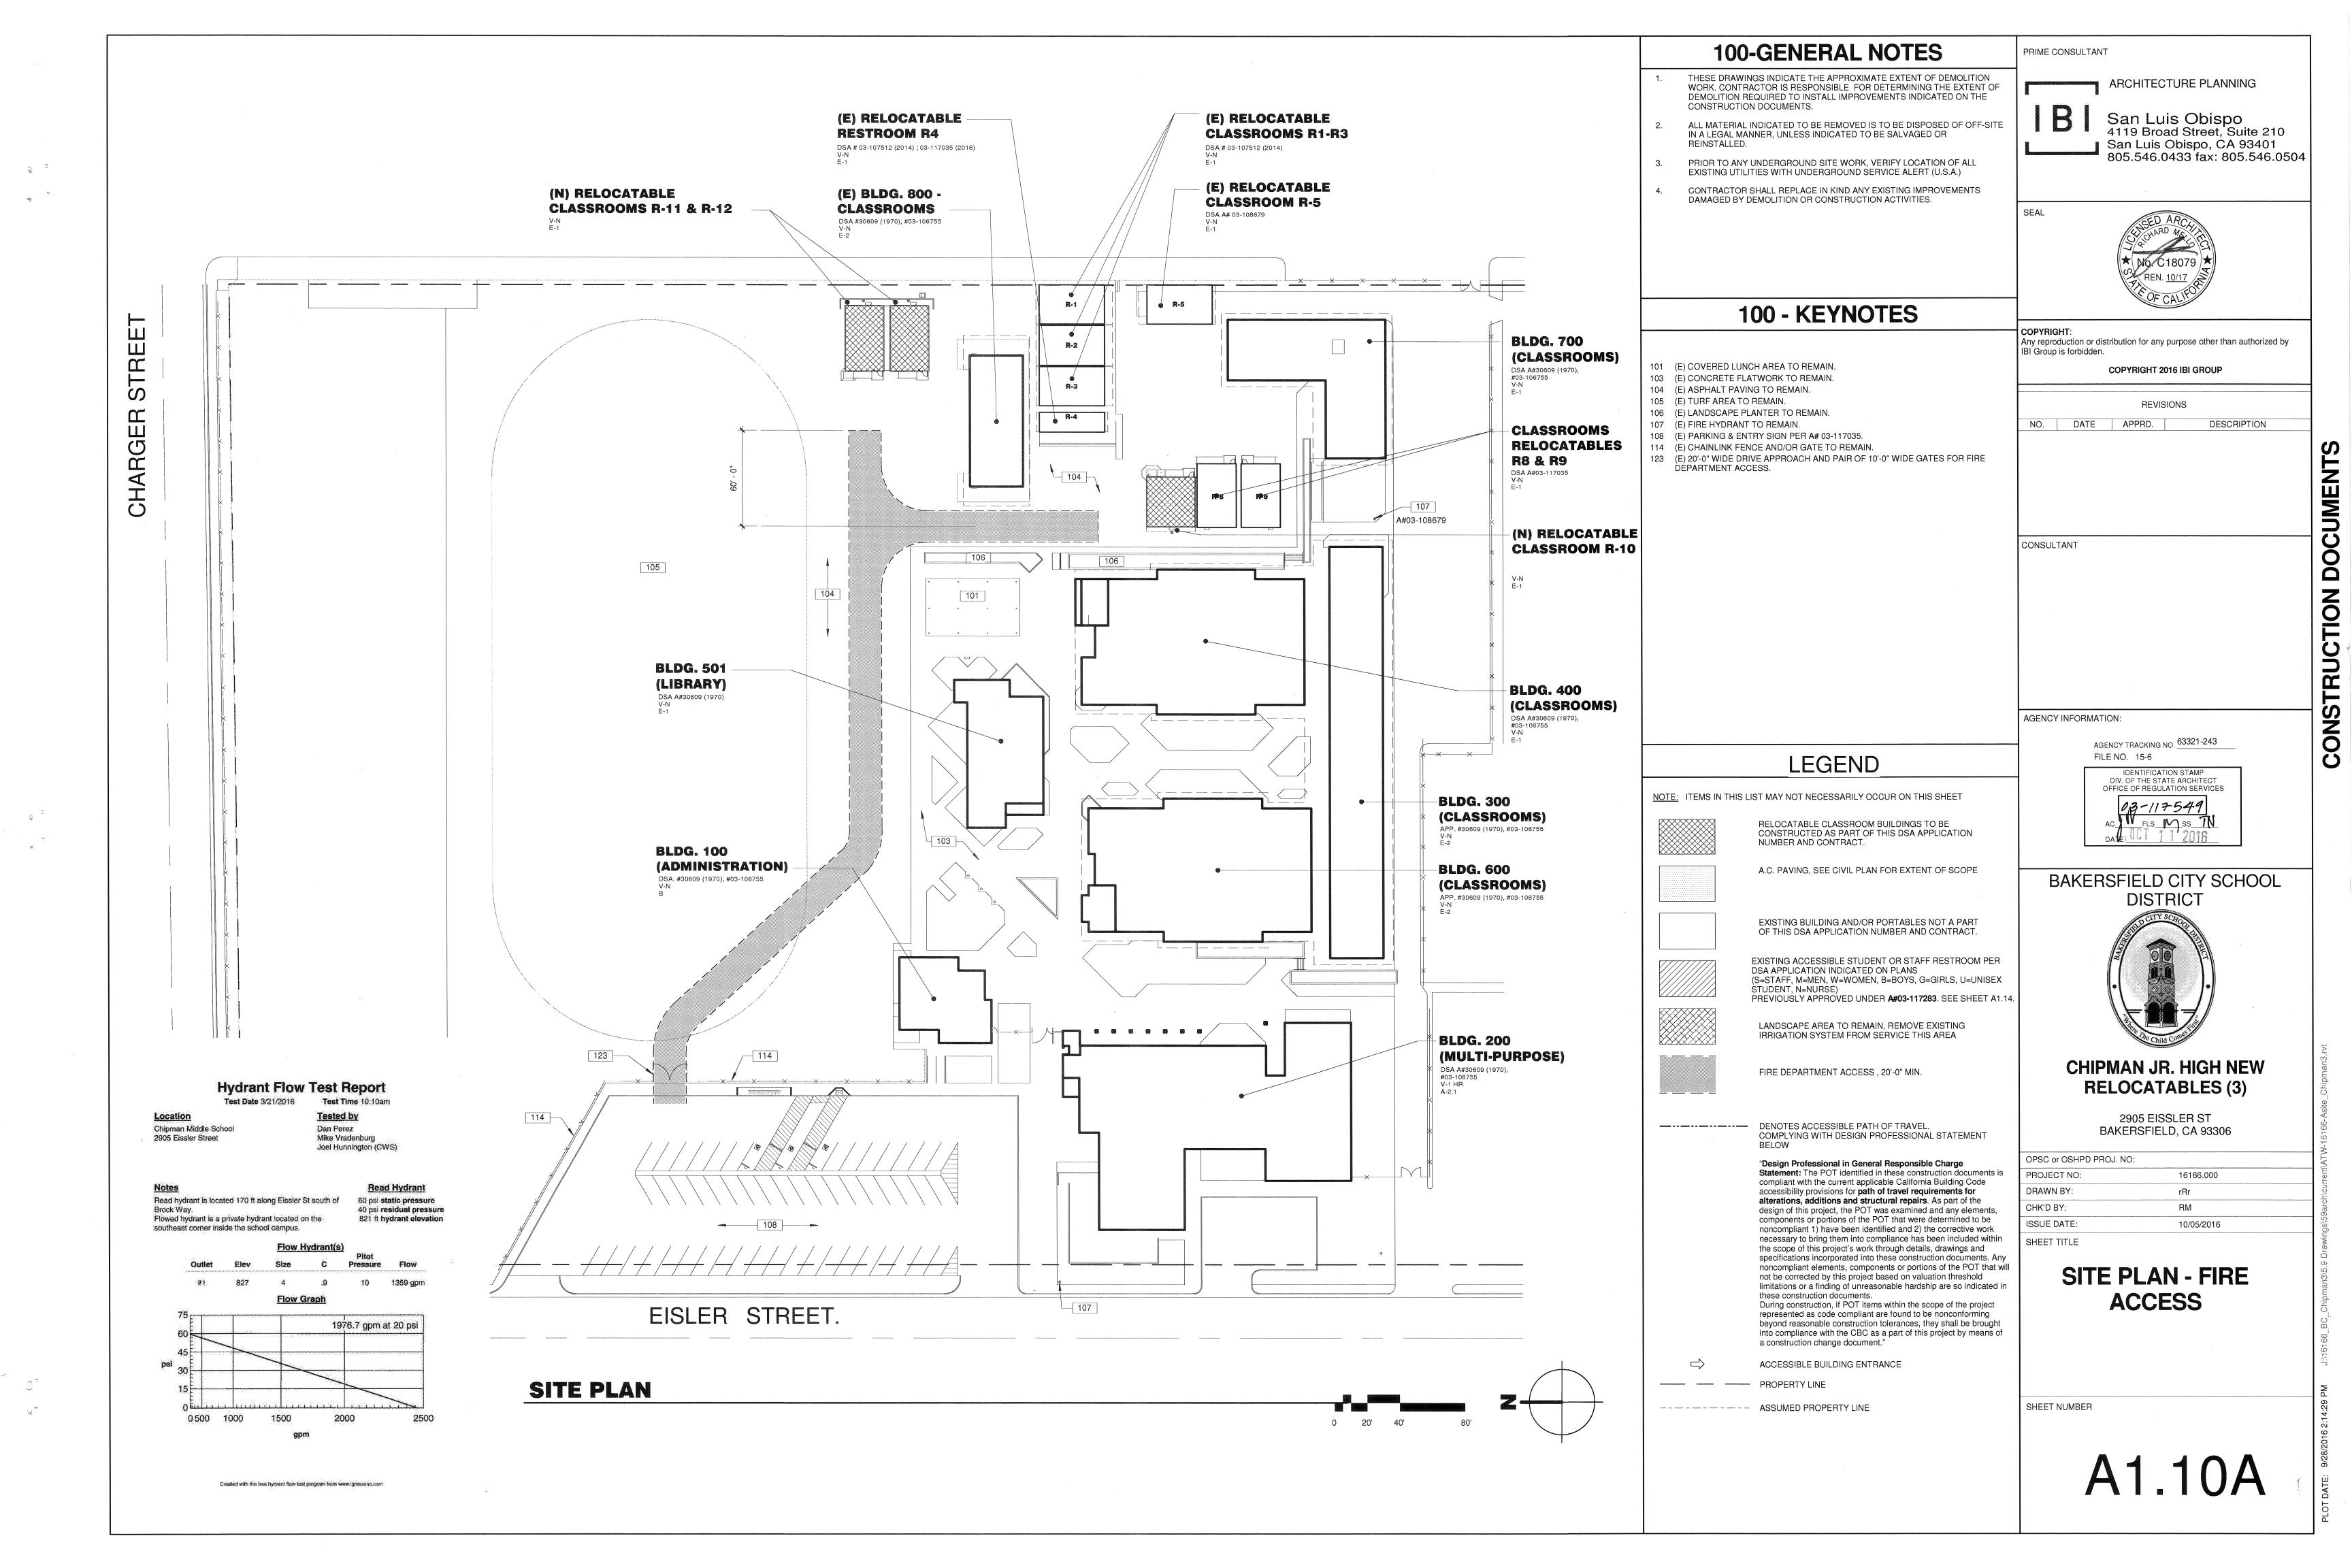

AGENCY TRACKING NO. 63321-243


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DIV. OF THE STATE ARCHITECT

OFFICE OF REGULATION SERVICES

03-117549

FILE NO. 15-6

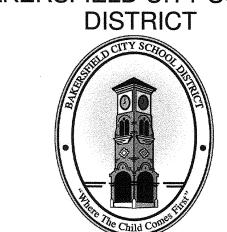

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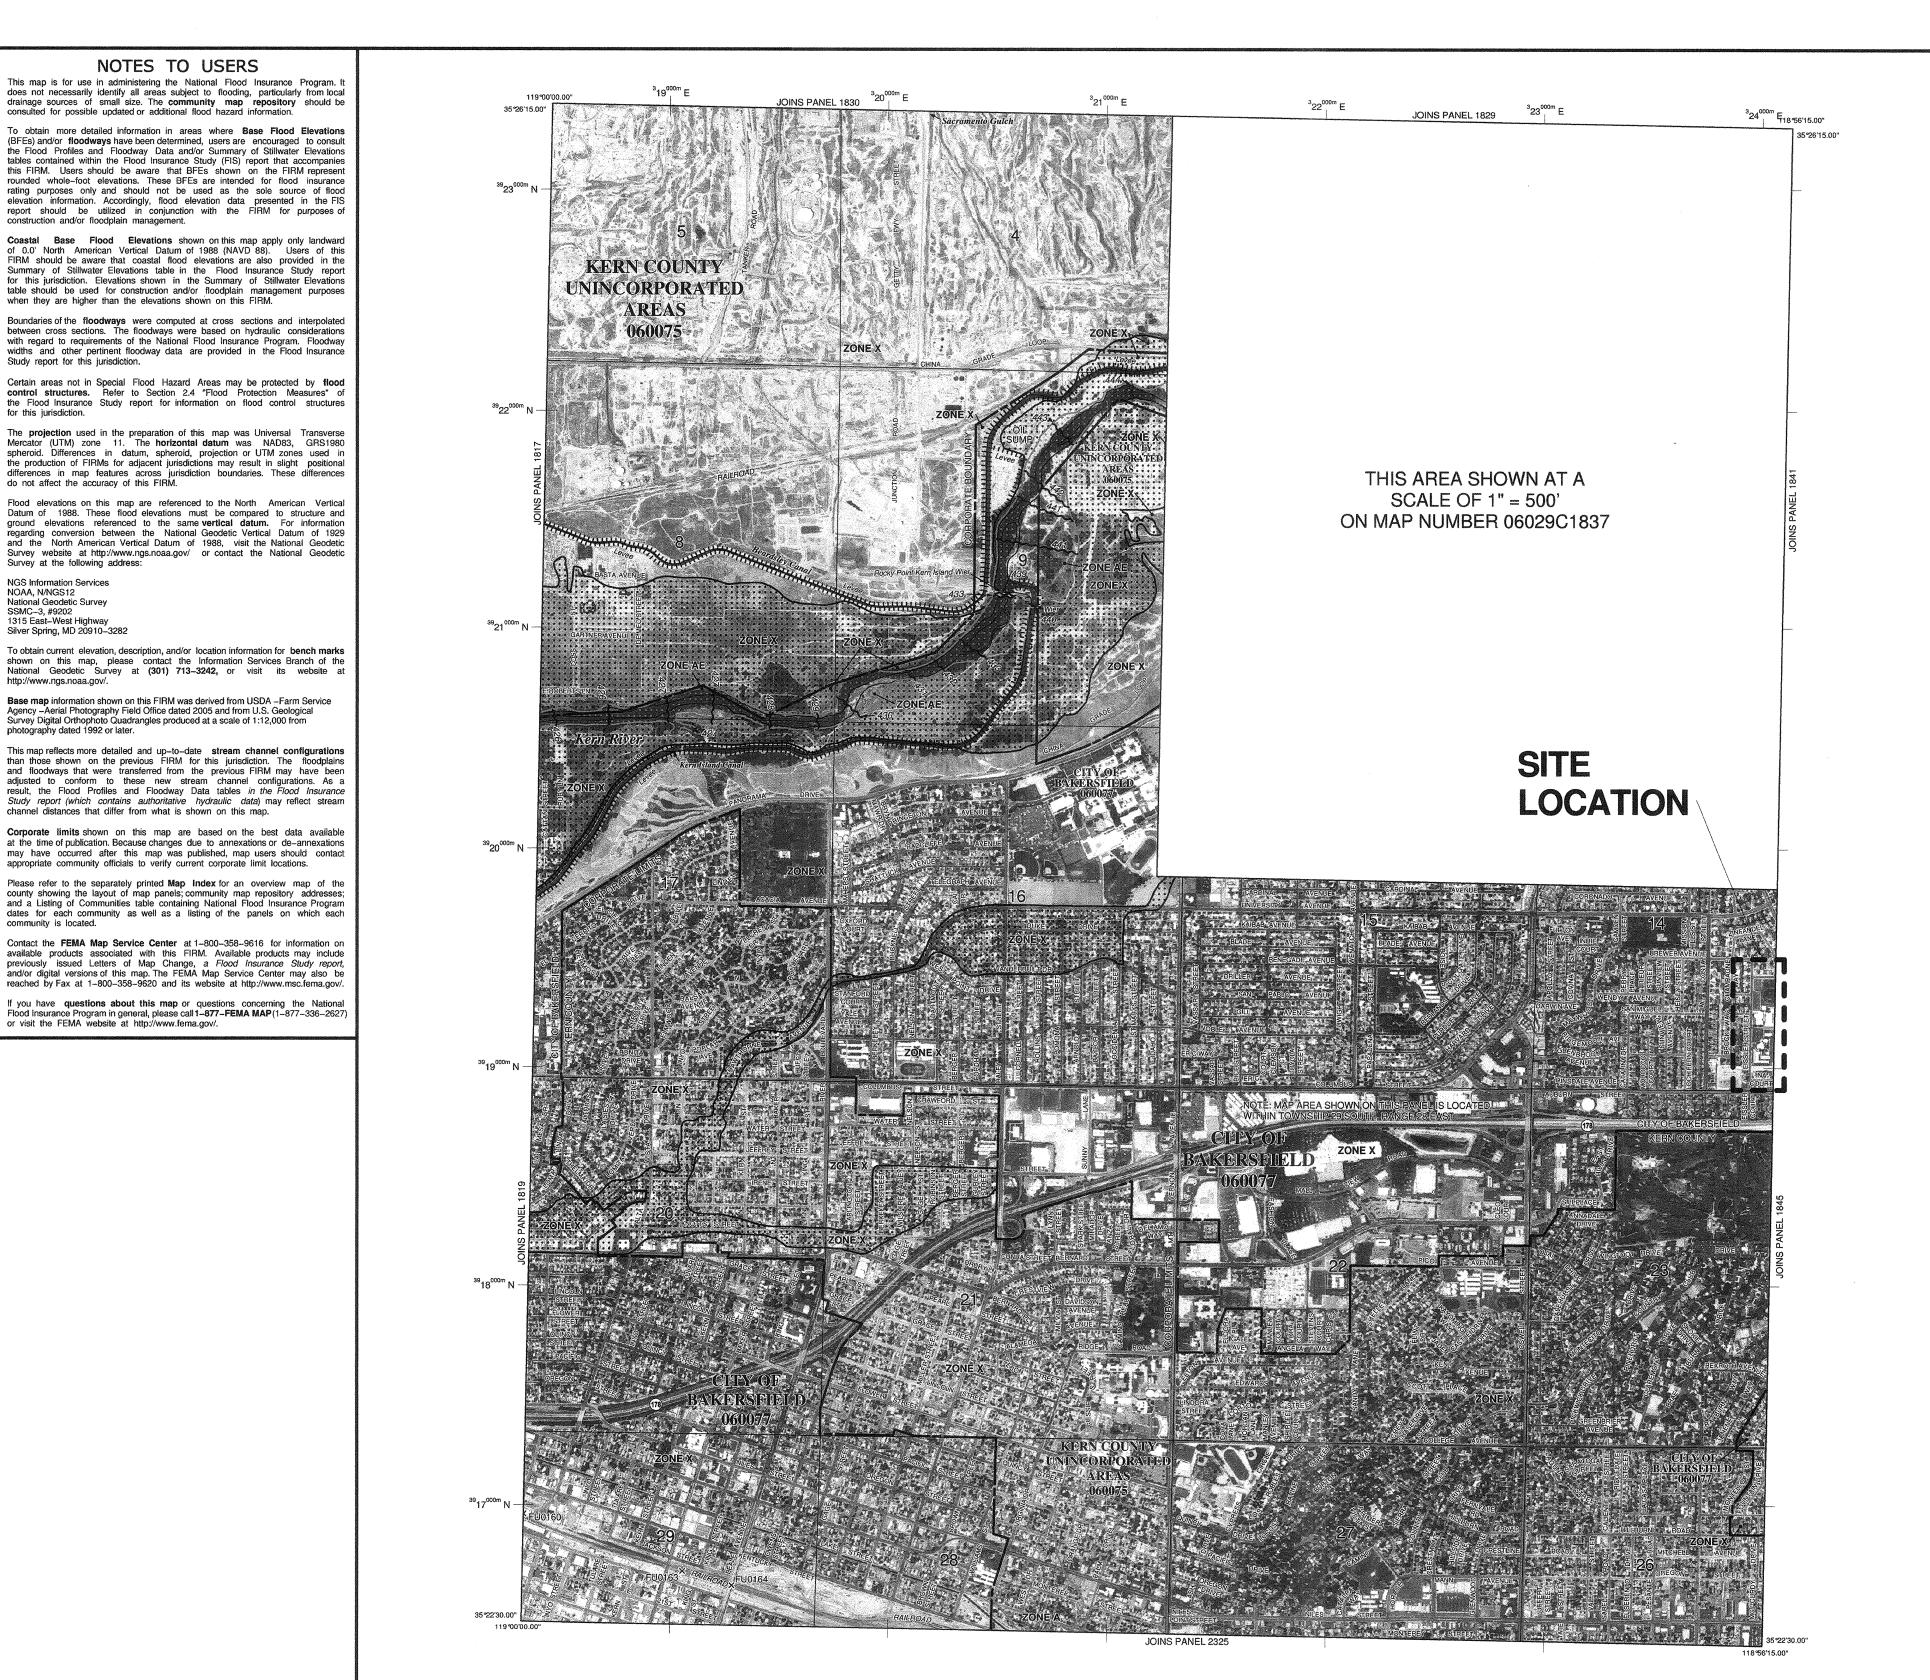
2905 EISSLER ST BAKERSFIELD, CA 93306

OPSC or OSHPD PROJ. NO: PROJECT NO: 16166.000 DRAWN BY: CC. CHK'D BY: RM. ISSUE DATE: 10/05/2016 SHEET TITLE

FLOOD MAP

SHEET NUMBER

A1.10B



LEGEND SPECIAL FLOOD HAZARD AREAS (SFHAS) SUBJECT TO INUNDATION BY THE 1% ANNUAL CHANCE FLOOD The 1% annual chance flood (100-year flood), also known as the base flood, is the flood that has a 1% chance of being equaled or exceeded in any given year. The Special Flood Hazard Area is the area subject to flooding by the 1% annual chance flood. Areas of Special Flood Hazard include Zones A, AE, AH, AO, AR, A99, V and VE. The Base Flood Elevation is the water-surface elevation of the 1% annual chance flood. ZONE A No Base Flood Elevations determined. ZONE AE Base Flood Elevations determined. ZONE AH Flood depths of 1 to 3 feet (usually areas of ponding); Base Flood Elevations determined. ZONE AO Flood depths of 1 to 3 feet (usually sheet flow on sloping terrain); average depths determined. For areas of alluvial fan flooding, velocities also determined. Special Flood Hazard Area formerly protected from the 1% annual chance flood by a flood control system that was subsequently decertified. Zone AR indicates that the former flood control system is being restored to provide protection from the 1% annual chance or greater flood. ZONE A99 Area to be protected from 1% annual chance flood by a Federal FLOODWAY AREAS IN ZONE AE The floodway is the channel of a stream plus any adjacent floodplain areas that must be kept free of encroachment so that the 1% annual chance flood can be carried without OTHER FLOOD AREAS Areas of 0.2% annual chance flood; areas of 1% annual chance flood with average depths of less than 1 foot or with drainage areas less than 1 square mile; and areas protected by levees from 1% annual chance Areas determined to be outside the 0.2% annual chance floodplain. Areas in which flood hazards are undetermined, but possible. COASTAL BARRIER RESOURCES SYSTEM (CBRS) AREAS OTHERWISE PROTECTED AREAS (OPAs) CBRS areas and OPAs are normally located within or adjacent to Special Flood Hazard Areas. 1% annual chance floodplain boundary 0.2% annual chance floodplain boundary Floodway boundary - Zone D boundary CBRS and OPA boundary Boundary dividing Special Flood Hazard Areas of different Base Flood Elevations, flood depths or flood velocities. >>> 513 >>> Base Flood Elevation line and value; elevation in feet* Base Flood Elevation value where uniform within zone; * Referenced to the North American Vertical Datum of 1988 (NAVD 88) Cross section line Geographic coordinates referenced to the North American Datum of 1983 (NAD 83) 1000-meter Universal Transverse Mercator grid ticks, zone 11 5000-foot grid ticks: California system, V zone (FIPSZONE 0405), State Plane coordinate Lambert Conformal Conic Bench mark (see explanation in Notes to Users section of Refer to Map Repositories list on Map Index September 26, 2008 EFFECTIVE DATE(S) OF REVISION(S) TO THIS PANEL For community map revision history prior to countywide mapping, refer to the Community Map History table located in the Flood Insurance Study report for this jurisdiction. To determine if flood insurance is available in this community, contact your insurance agent or call the National Flood Insurance Program at 1-800-638-6620. PANEL 1840E

FLOOD INSURANCE RATE MAP KERN COUNTY, CALIFORNIA AND INCORPORATED AREAS PANEL 1840 OF 4125 Federal Emergency Management Agency

06029C1840E **EFFECTIVE DATE SEPTEMBER 26, 2008**

1 A.110B FLOOD MAP AS NOTED


Survey at the following address:

NGS Information Services

NOAA, N/NGS12 National Geodetic Survey SSMC-3, #9202

community is located.

1315 East–West Highway Silver Spring, MD 20910–3282

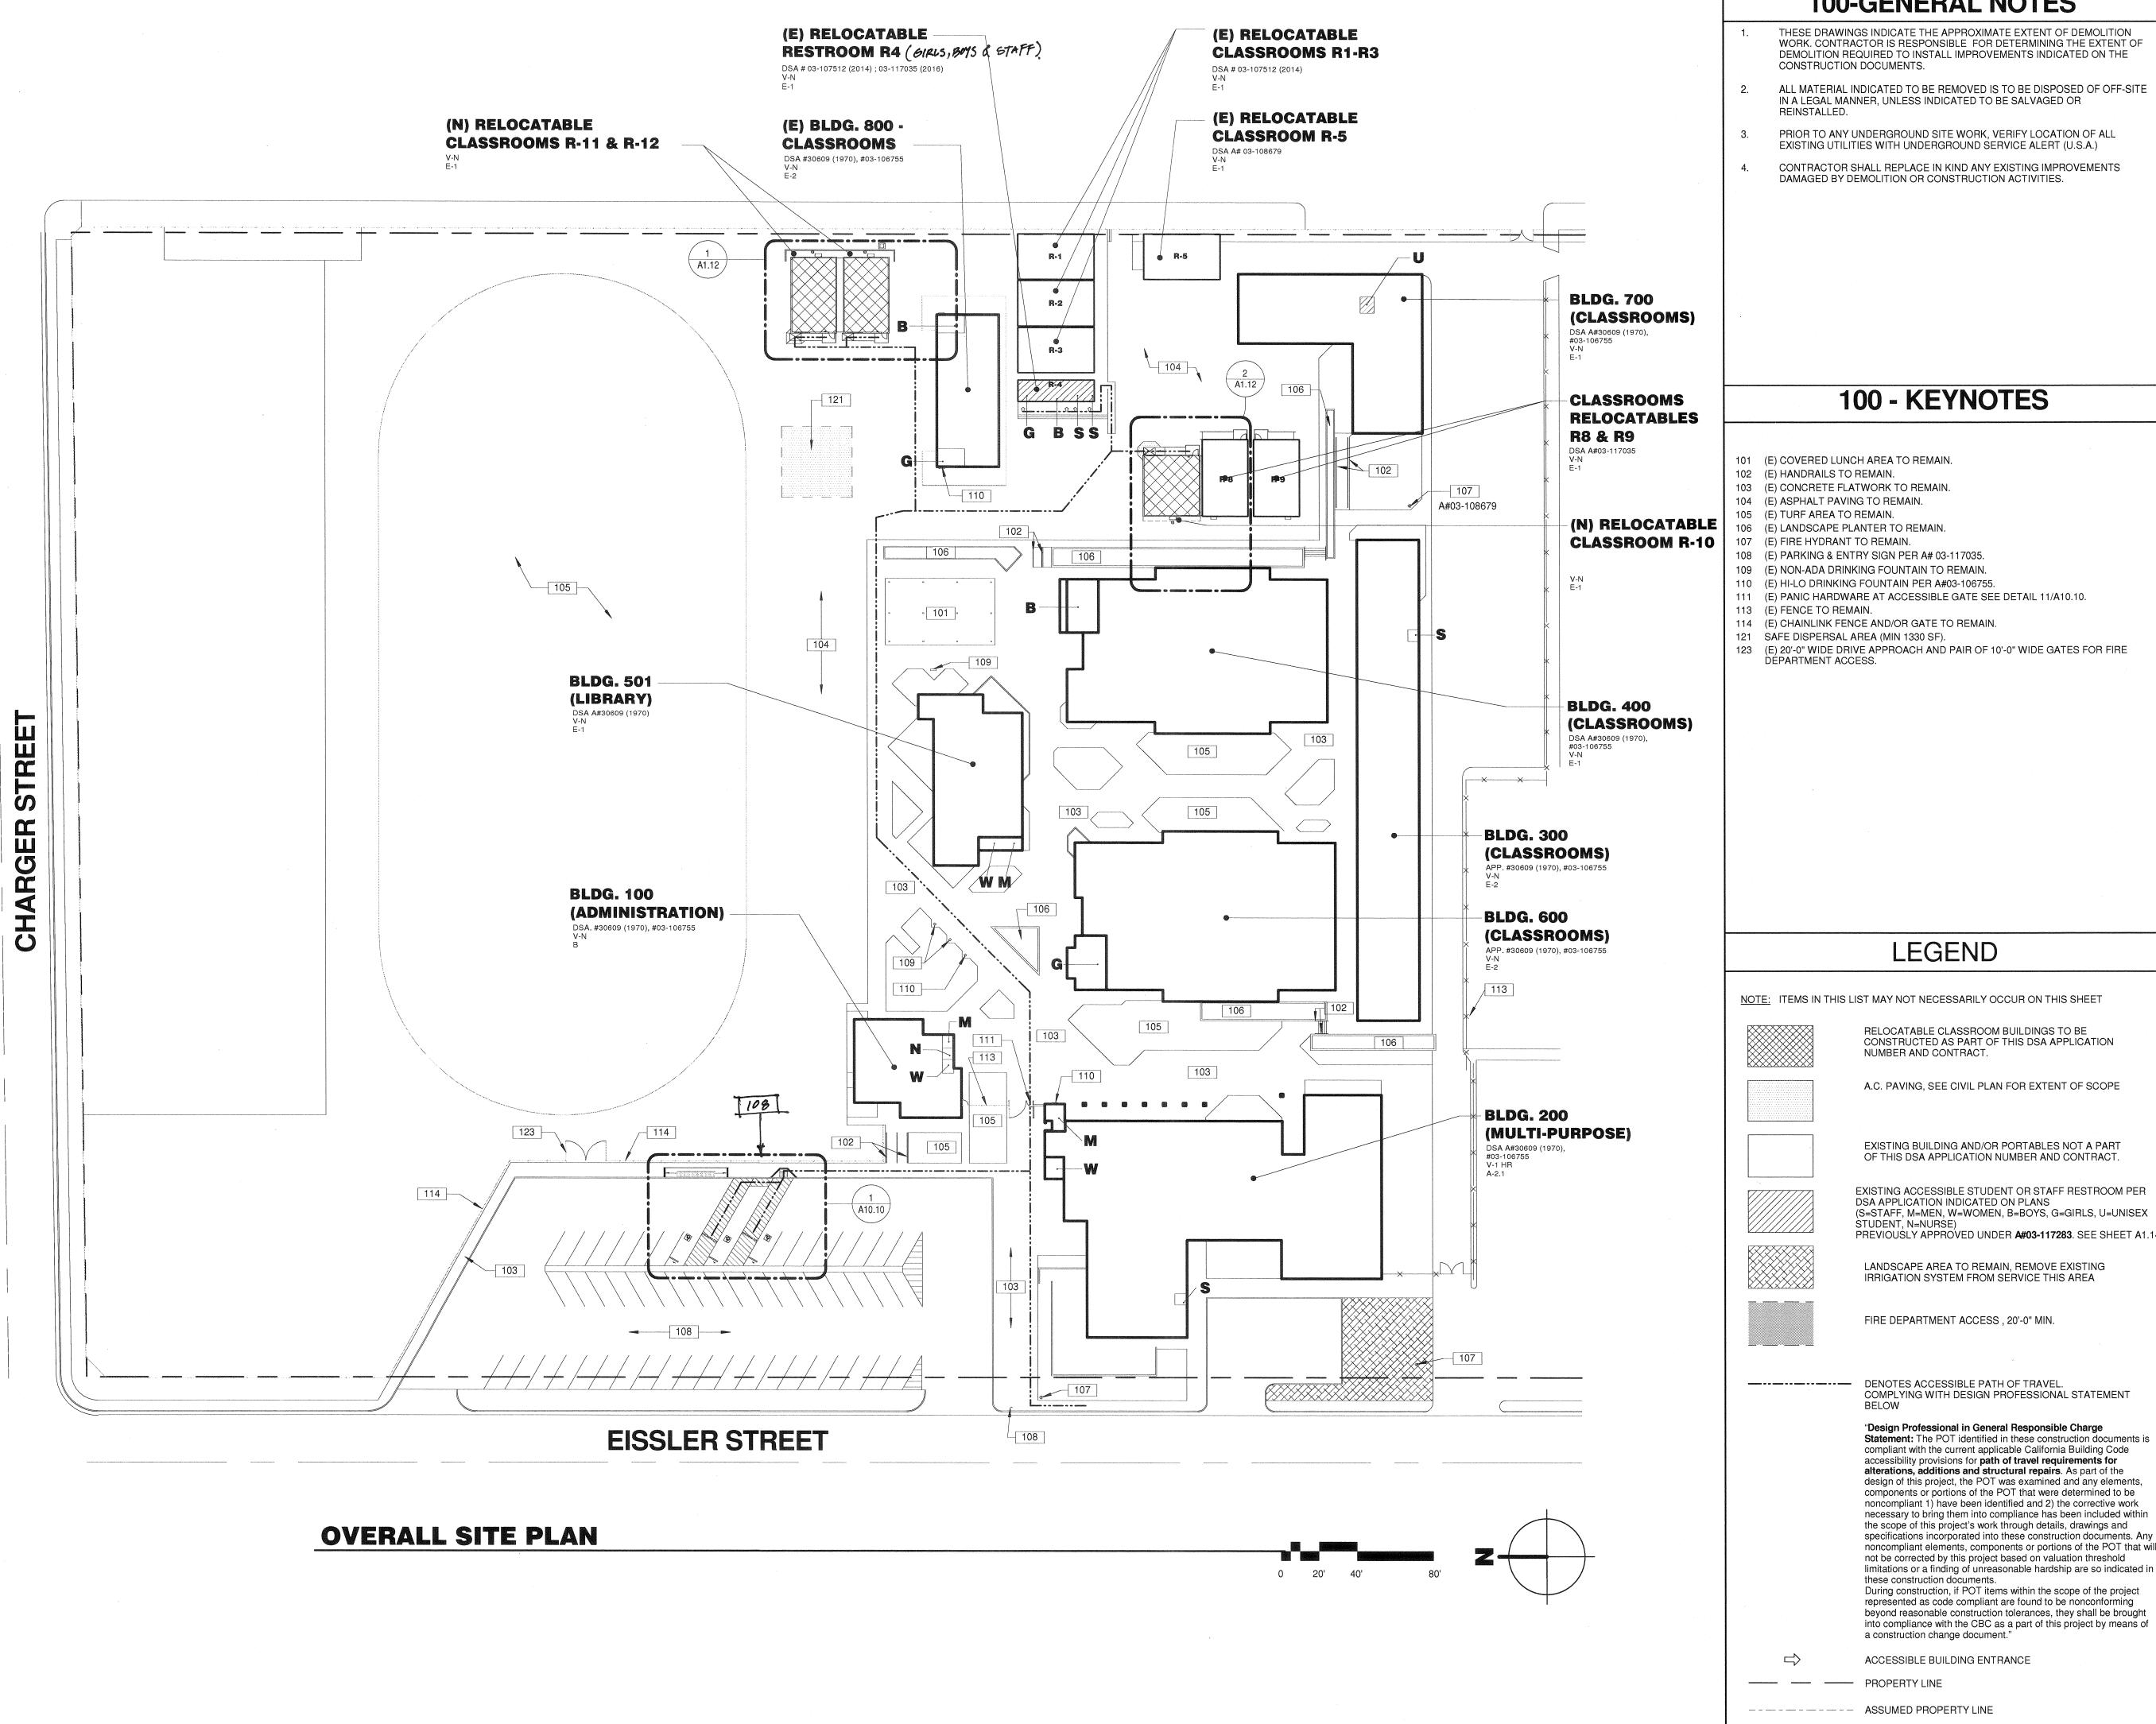

100-GENERAL NOTES

THESE DRAWINGS INDICATE THE APPROXIMATE EXTENT OF DEMOLITION WORK. CONTRACTOR IS RESPONSIBLE FOR DETERMINING THE EXTENT OF DEMOLITION REQUIRED TO INSTALL IMPROVEMENTS INDICATED ON THE

- ALL MATERIAL INDICATED TO BE REMOVED IS TO BE DISPOSED OF OFF-SITE IN A LEGAL MANNER, UNLESS INDICATED TO BE SALVAGED OR
- PRIOR TO ANY UNDERGROUND SITE WORK, VERIFY LOCATION OF ALL
- CONTRACTOR SHALL REPLACE IN KIND ANY EXISTING IMPROVEMENTS

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San Luis Obispo, CA 93401

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San Luis Obispo

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AGENCY TRACKING NO. 63321-243 FILE NO. 15-6

IDENTIFICATION STAMP DIV. OF THE STATE ARCHITECT OFFICE OF REGULATION SERVICES 03-117549 ACTIV FLS M SS TN
DAVE OCT 11 2016

BAKERSFIELD CITY SCHOOL

DISTRICT

CHIPMAN JR. HIGH NEW RELOCATABLES (3)

2905 EISSLER ST BAKERSFIELD, CA 93306

OPSC or OSHPD PROJ. NO: PROJECT NO: 16166.000 DRAWN BY: rRr CHK'D BY: RM ISSUE DATE: 10/05/2016 SHEET TITLE

OVERALL SITE PLAN

SHEET NUMBER



ARCHITECTURE PLANNING

4119 Broad Street, Suite 210

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AGENCY TRACKING NO. 63321-243

DIV. OF THE STATE ARCHITECT OFFICE OF REGULATION SERVICES

93-117549

DISTRICT

RELOCATABLES (3)

2905 EISSLER ST


BAKERSFIELD, CA 93306


16166.000


10/05/2016

FILE NO. 15-6

DESCRIPTION

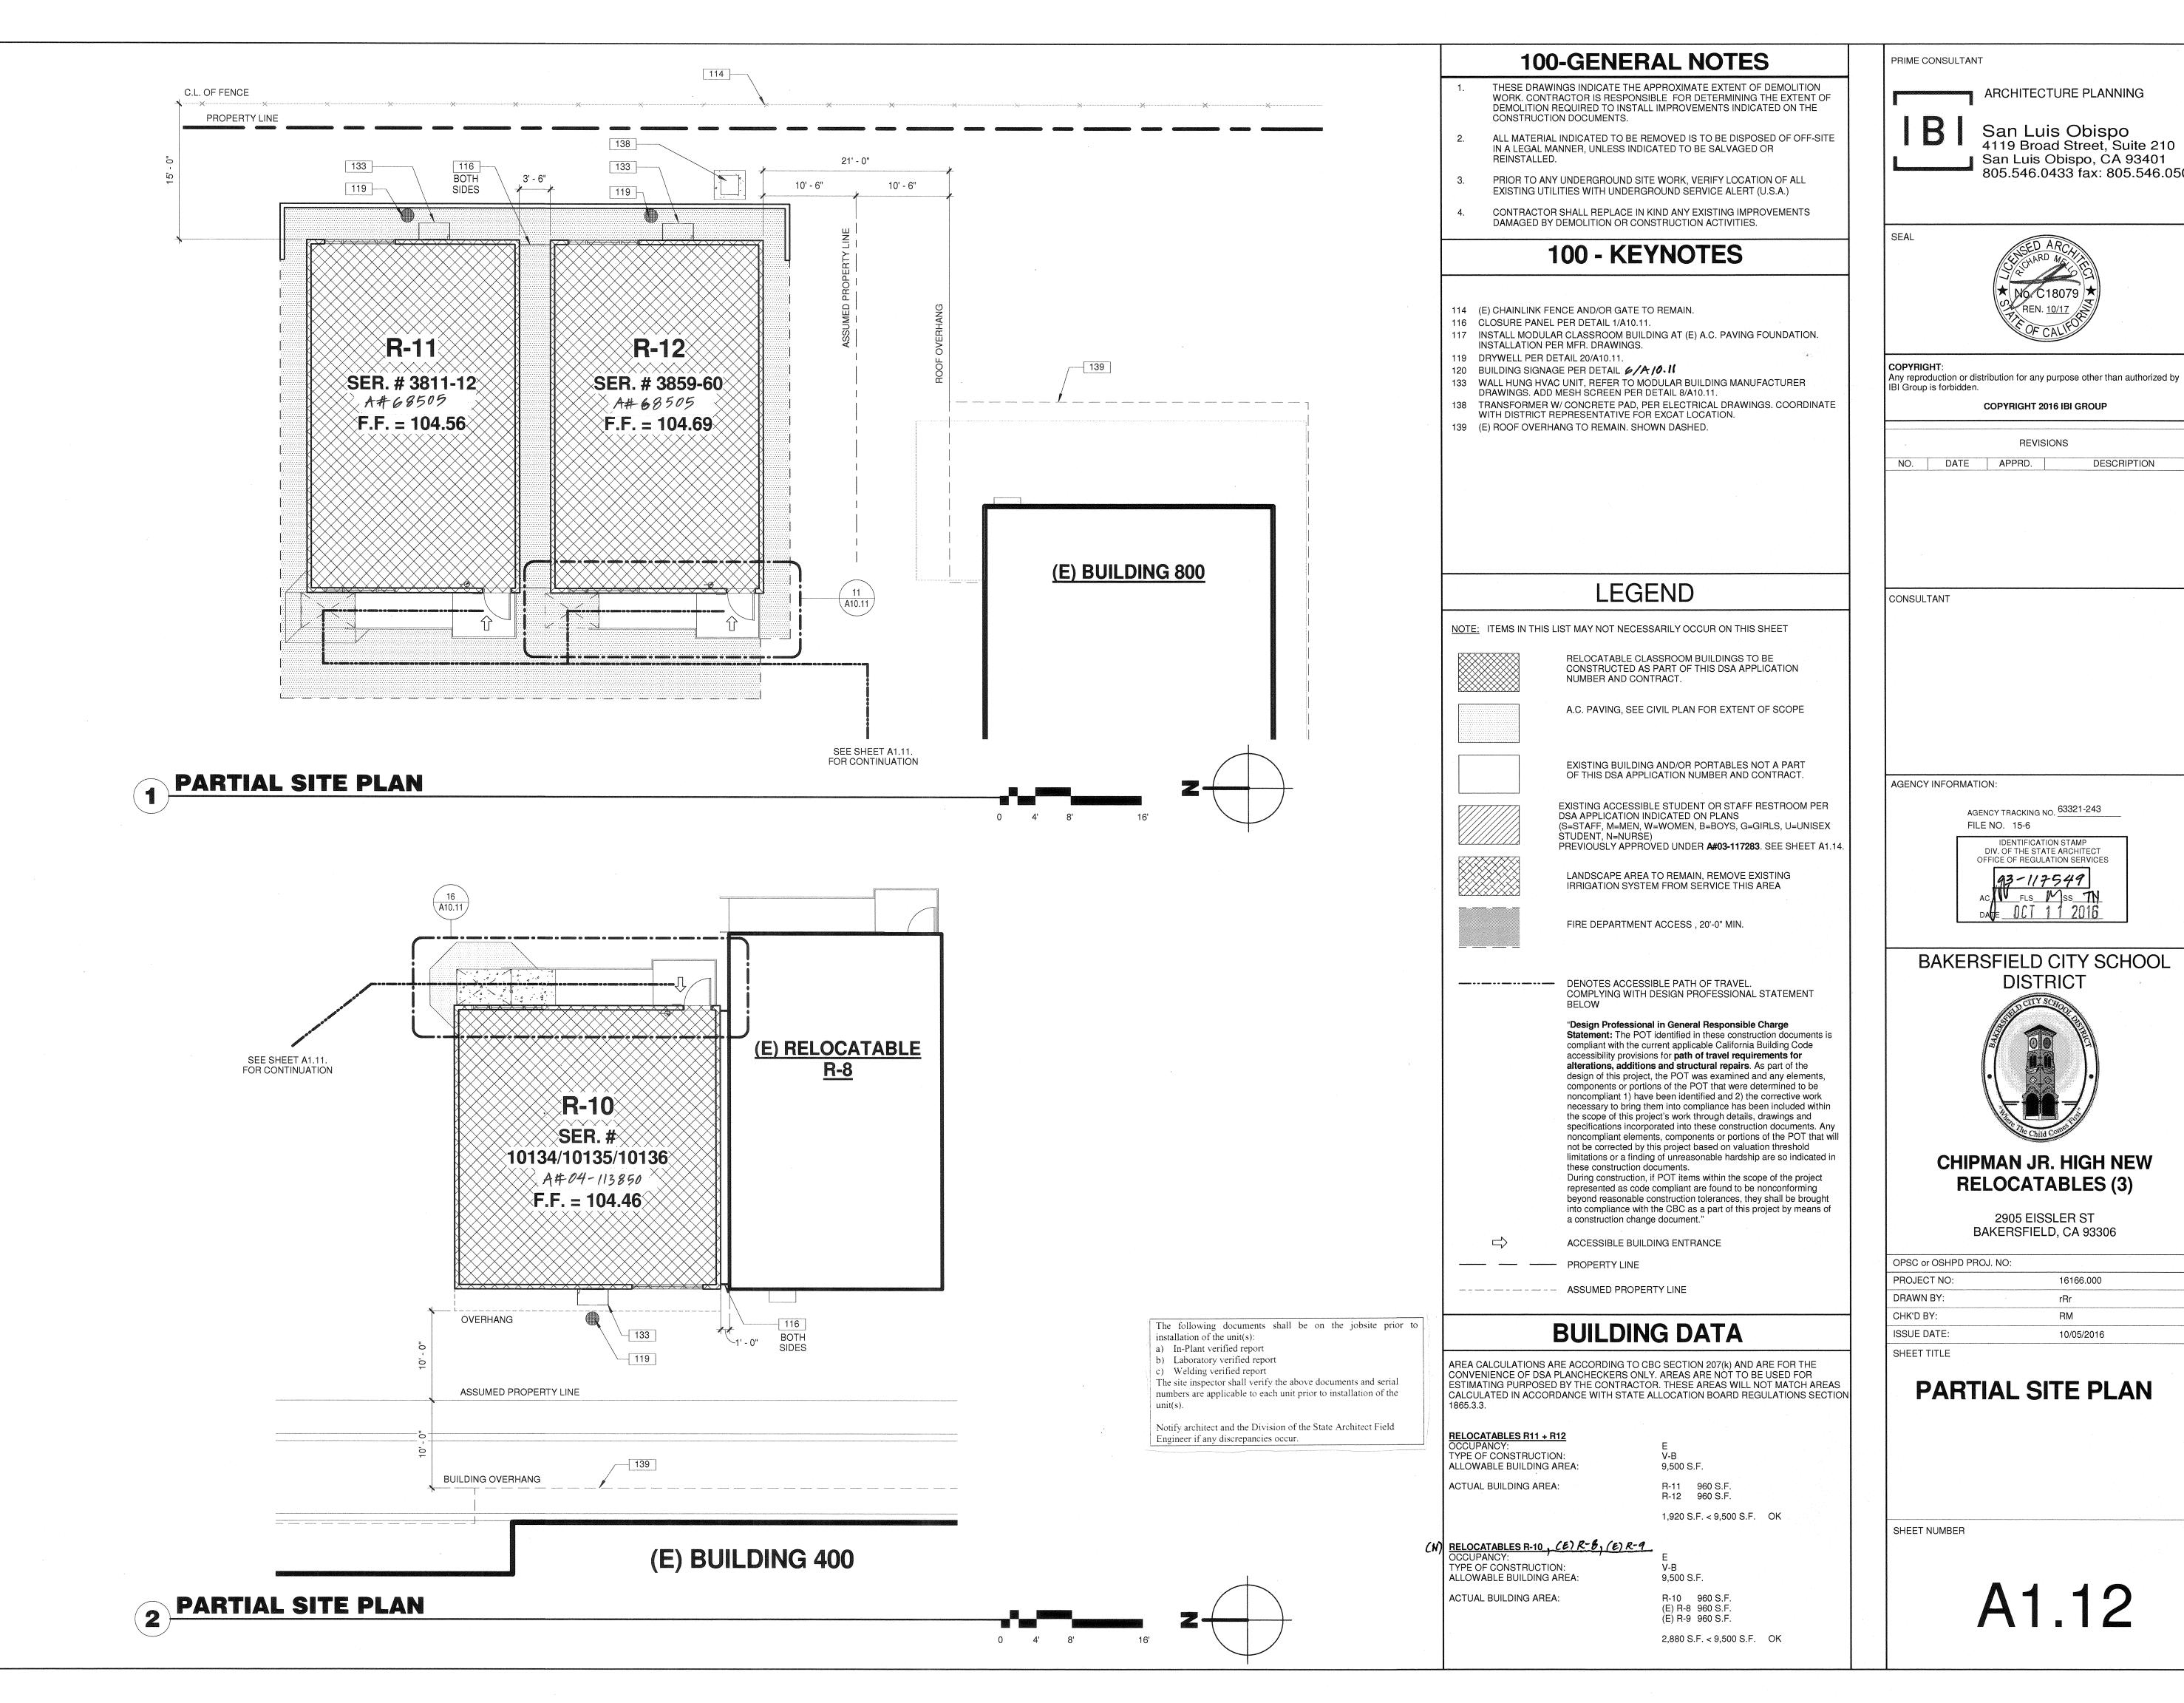


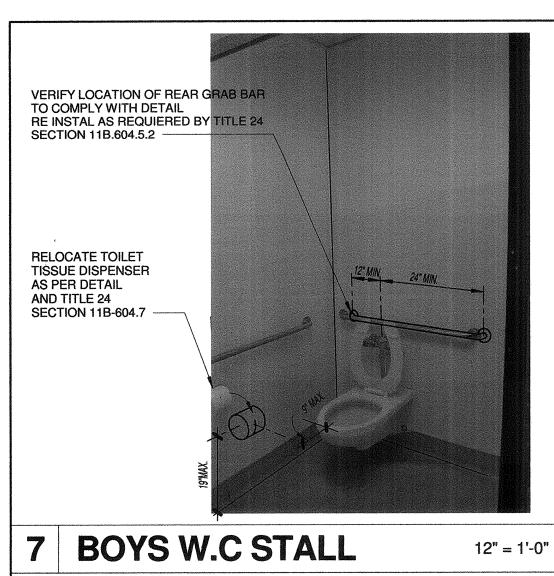


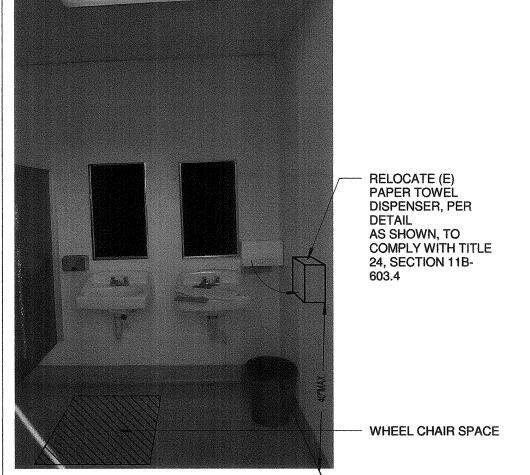


6 BOYS LAVATORY

12" = 1'-0"

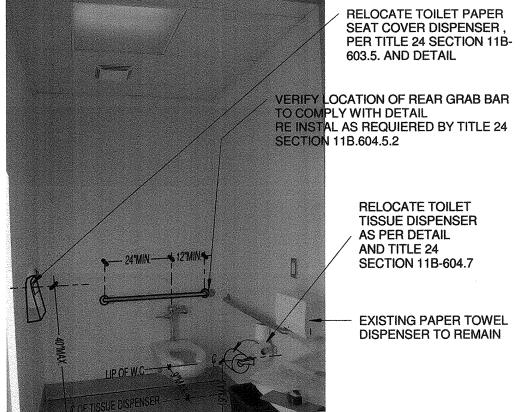

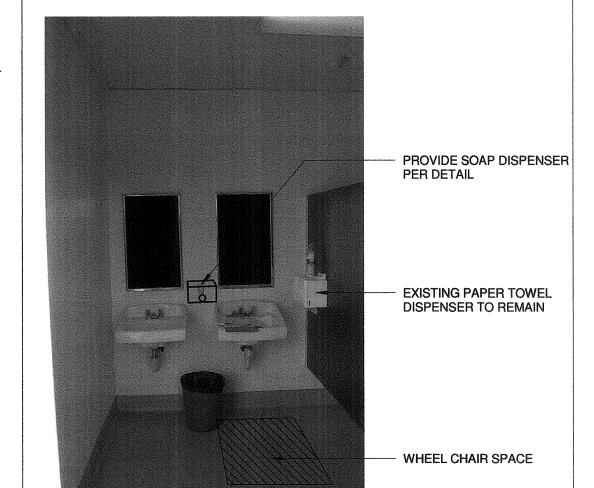

8 MENS ACCESSIBLE T.R 12" = 1'-0" 5 GIRLS LAVATORY

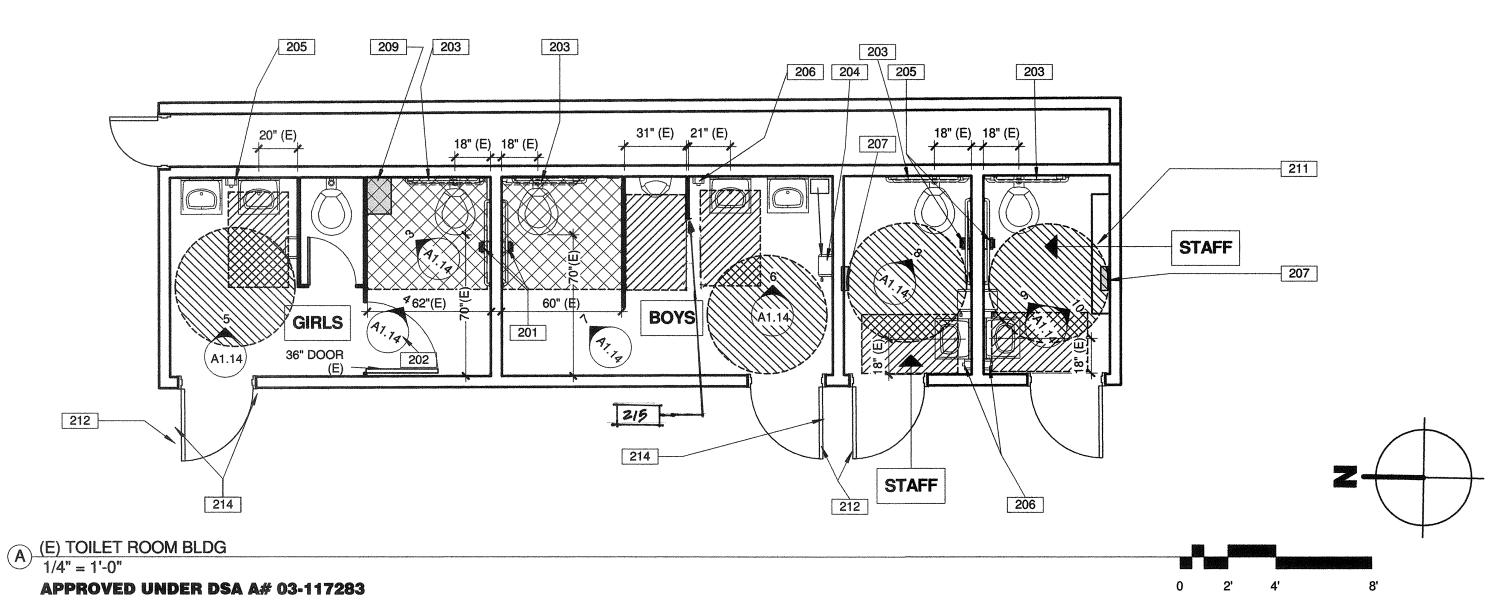

NOTES TO EXISTING RESTROOMS FLOOR PLAN:

42" MIN

TOILET TISSUE DISPENSER

TOILET SEAT COVER -

DISPENSER

12 MIN 24" MIN

EXTINGUISHER

EXISTING BOY'S AND GIRL'S TOILET FIXTURES LAYOUT AND ACCESSORIES, WHERE ALTERED IN COMPLIANCE WITH THE REQUIREMENTS OF THE PRECEEDING 2010 C.B.C, TABLE 1115B-1 CHILDREN DIMENSIONS, AND OR ARE IN COMPLIANCE WITH THE 2013 C.B.C TABLE 11B-604.9, SUGGESTED CHILDREN DIMENSIONS, UNLESS OTHERWISE NOTED. REFER TO 2013 CBC CAPTER 11B-202.4 FOR EXISTING TOILET RETROFIT REQUIREMENT, EXCEPTION 2.

DIMENSIONS SHOWN ARE FOR TWO PIECE GRAB BAR.

REQUIREMENTS. SAME DIMENSIONS SHALL APPLY TO

FOUNTAIN

ONE PIECE GRAB BAR SHALL MEET THE SAME BASIC

- EXISTING CONDITIONS AT STAFF WOMEN RESTROOM, ARE SIMILAR TO EXISTING CONDITIONS AT STAFF MEN RESTROOM. THE SCOPE OF WORK ON STAFF WOMEN RESTROOM, IS EQUAL TO THE SCOPE OF WORK ON STAFF MEN RESTROOM, UNLESS OTHERWISE NOTED.
- ALL EXISTING TOILET FIXTURES, DOORS, PARTITIONS, SIGNS, ACCESSORIES ETC. ARE TO REMAIN UNLESS OTHERWISE NOTED.


SEMI-AMBULATORY STALL

VISUAL DISPLAY BOARD

2" TOILET SEAT MAX.

REFER TO DETAIL 2/A1.14 FOR ACCESSIBLE MOUNTING HEIGHTS AND DIMENSIONS

- SANITARY NAPKIN

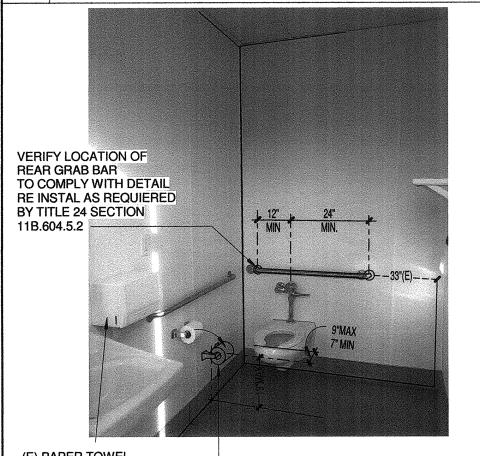

(E) PAPER TOWEL RELOCATE TOILET TISSUE DISPENSER DISPENSER TO REMAIN AS PER DETAIL AND TITLE 24 SECTION 11B-604.7

VERIFY LOCATION OF REAR GRAB BAR TO COMPLY WITH DETAIL RE INSTAL AS REQUIERED BY TITLE 24 **SECTION 11B.604.5.2 PROVIDE TOILET TISSUE** DISPENSER AS PER AND TITLE 24 SECTION

ACCESSIBLE MOUNTING HEIGHTS 12" = 1'-0"

MAX. PROJECTION

FIRE EXTINGUISHER CABINET, 4"

FIRE EXTINGUISHER WITH

QUICK RELEASE BRACKET

ADULTS AGES 13 CHILDREN & OLDER AGES 9-12 WHEELCHAIR ACCESSIBLE WATER CLOSET AMBULATORY ACCESSIBLE WATER CLOSET 17" - 19" 15" - 18" CENTERLINE 17" MIN -19" MAX TOILET SEAT HEIGHT (TO TOP OF SEAT) GRAB BAR HEIGHT (TOP OF GRIPPING SURFACE) 25" - 27" TOILET TISSUE DISPENSER TO TOILET ACCESSIBLE LOCATION SHOWN. AS PER DETAIL 2/A1.14 TOILET TISSUE DISPENSER (OUTLET OF 19" MIN 17" - 19" TOILET TISSUE DISPENSER (FROM BOTTOM OF 1 1/2" MIN CLR 1 1/2" MIN CLR

REQUIRED CLEAR MANEUVERING SPACE 3 GIRLS W.C STALL

SANITARY NAPKIN DISPOSAL TO TOILET SANITARY NAPKIN DISPOSAL FROM FLOOR 15" - 18" 40" MAX 40" MAX SURFACE G LAVATORY/ SINK HEIGHT 34" MAX 34" MAX G1 LAVATORY APRON CLEARANCE 29" MIN 27" MIN 27" MIN KNEE CLEARANCE 17" MAX 17" MAX URINAL RIM HEIGHT 44" MAX URINAL FLUSH CONTROL HEIGHT 44" MAX 30" MAX, SIDE APPROACH 27" MIN

200 - KEYNOTES

TV/VCR MOUNTING

RELOCATE EXISTING TOILET TISSUE DISPENSER TO COMPLY WITH DETAIL

LAVATORY

PAPER TOWEL

RECEPTACLE

DISPENSER WITH TRASH

PROVIDE "U" SHAPE HANDLE EACH SIDE OF EXISTING STALL DOOR RELOCATE EXISTING 36" REAR GRAB BAR TO COMPLY WITH TITLE 24 SECTION REMOVE AND RELOCATE EXISTING PAPER TOWEL DISPENSER TO

PROVIDE SOAP DISPENSER. MOUNT PER DETAIL 2/A1.14 (E) SOAP DISPENSER TO REMAIN RELOCATE SEAT COVER DISPENSER SLOT HEIGHT TO MAX 40"AFF, PER

DETAIL 2/A1.14 REMOVE EXISTING LOCKER, PROVIDE CLEAR MANEUVERING SPACE AS PER TITLE 24, SECTION 11B-604.3.2 REMOVE EXISTING 5'-0" SHELVE AND RELOCATE, TOP OF SHELVE SHALL BE

48" A.F.F AS PER DETAIL 2/A1.14 REVISE CLOSER AT RELOCATABLE DOORS OPERATING PRESSURE TO 5 LBS

VERIFY (E) DOOR SIGNAGE COMPLIES WITH 2013 CBC CODE. RELOCATE OR PROVIDE SIGNAGE PER DETAIL 4/A10.10 (BUILDING R-4).

215 PROVIDE 18" UPINAL PARTITION.

SANITARY NAPKIN

DISPENSER

4" MAXIMUM -

PROJECTION

DISPENSER

COAT HOOK

INDICATES CLEAR 60" Ø MANEUVERING SPACE

200 LEGEND

SOME FIXTURES/ACCESSORIES SHOWN

ELEVATIONS TAKE PRECEDENCE OVER

FIXTURES/ACCESSORIES SHOWN ARE AT HEIGHTS ACCESSIBLE TO PERSONS

DETERMINED BY RECOMMENDATIONS

FROM THE MANUFACTURER, UNLESS

WATER CLOSET FLUSH VALVE SHALL BE

ORIENTED ON THE APPROACH SIDE OF

MOUNT GRAB BARS 36" ABOVE FINISHED FLOOR AT TANK TYPE TOILETS. ALLOW

A1.14

1/4" = 1'-0"

FOR DIMENSIONS INDICATED BY A LETTER REFER TO DETAIL 2

MAY NOT APPLY TO THIS PROJECT.

HEIGHTS INDICATED ON INTERIOR

HEIGHTS SHOWN HERE.


WITH DISABILITIES.

ACCESSIBLE TOILET.


6" CLR TO GRAB BAR.

MOUNTING HEIGHTS FOR ABLE

BODIED PERSONS SHALL BE

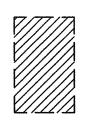

INDICATES CLEAR 30"X48" WHEELCHAIR SPACE

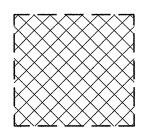

INDICATES CLEAR 60"X56" MANEUVERING SPACE AT WALL HUNG WATER CLOSETS.

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IDENTIFICATION STAMP DIV. OF THE STATE ARCHITECT OFFICE OF REGULATION SERVICES 03-117549 AC W FLS SS TN DATE DET 1 1 2016

BAKERSFIELD CITY SCHOOL DISTRICT




CHIPMAN JR. HIGH NEW RELOCATABLES (3)

> 2905 EISSLER ST BAKERSFIELD, CA 93306

OPSC or OSHPD PROJ. NO: PROJECT NO: 16132.000 CC CHK'D BY: 10/05/2016 SHEET TITLE


> **EXISTING RESTROOM - DSA** A#03-117283

SHEET NUMBER

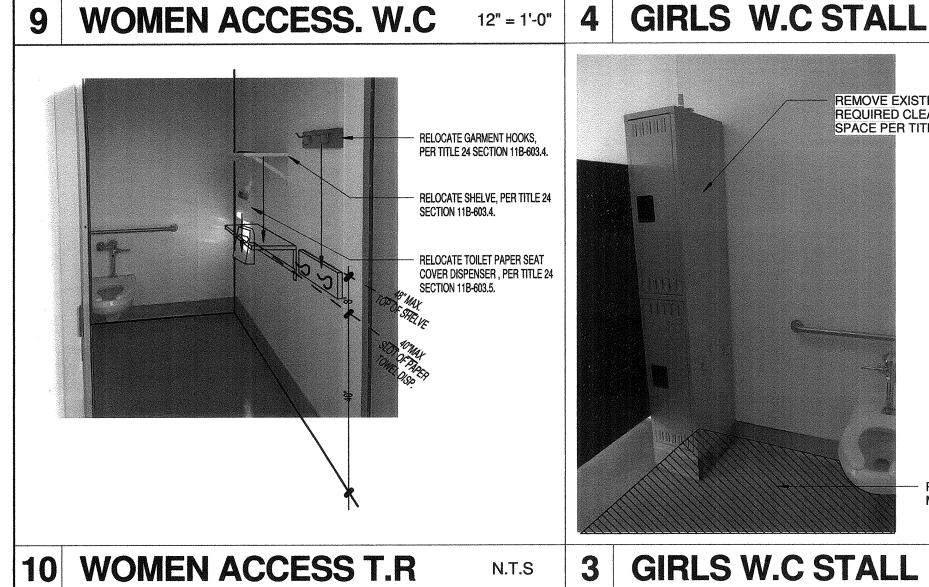


REMOVE EXISTING LOCKER FROM REQUIRED CLEAR MANEUVERING SPACE PER TITLE 24 SECTION 11B-604.3

2 MOUNTING HEIGHTS

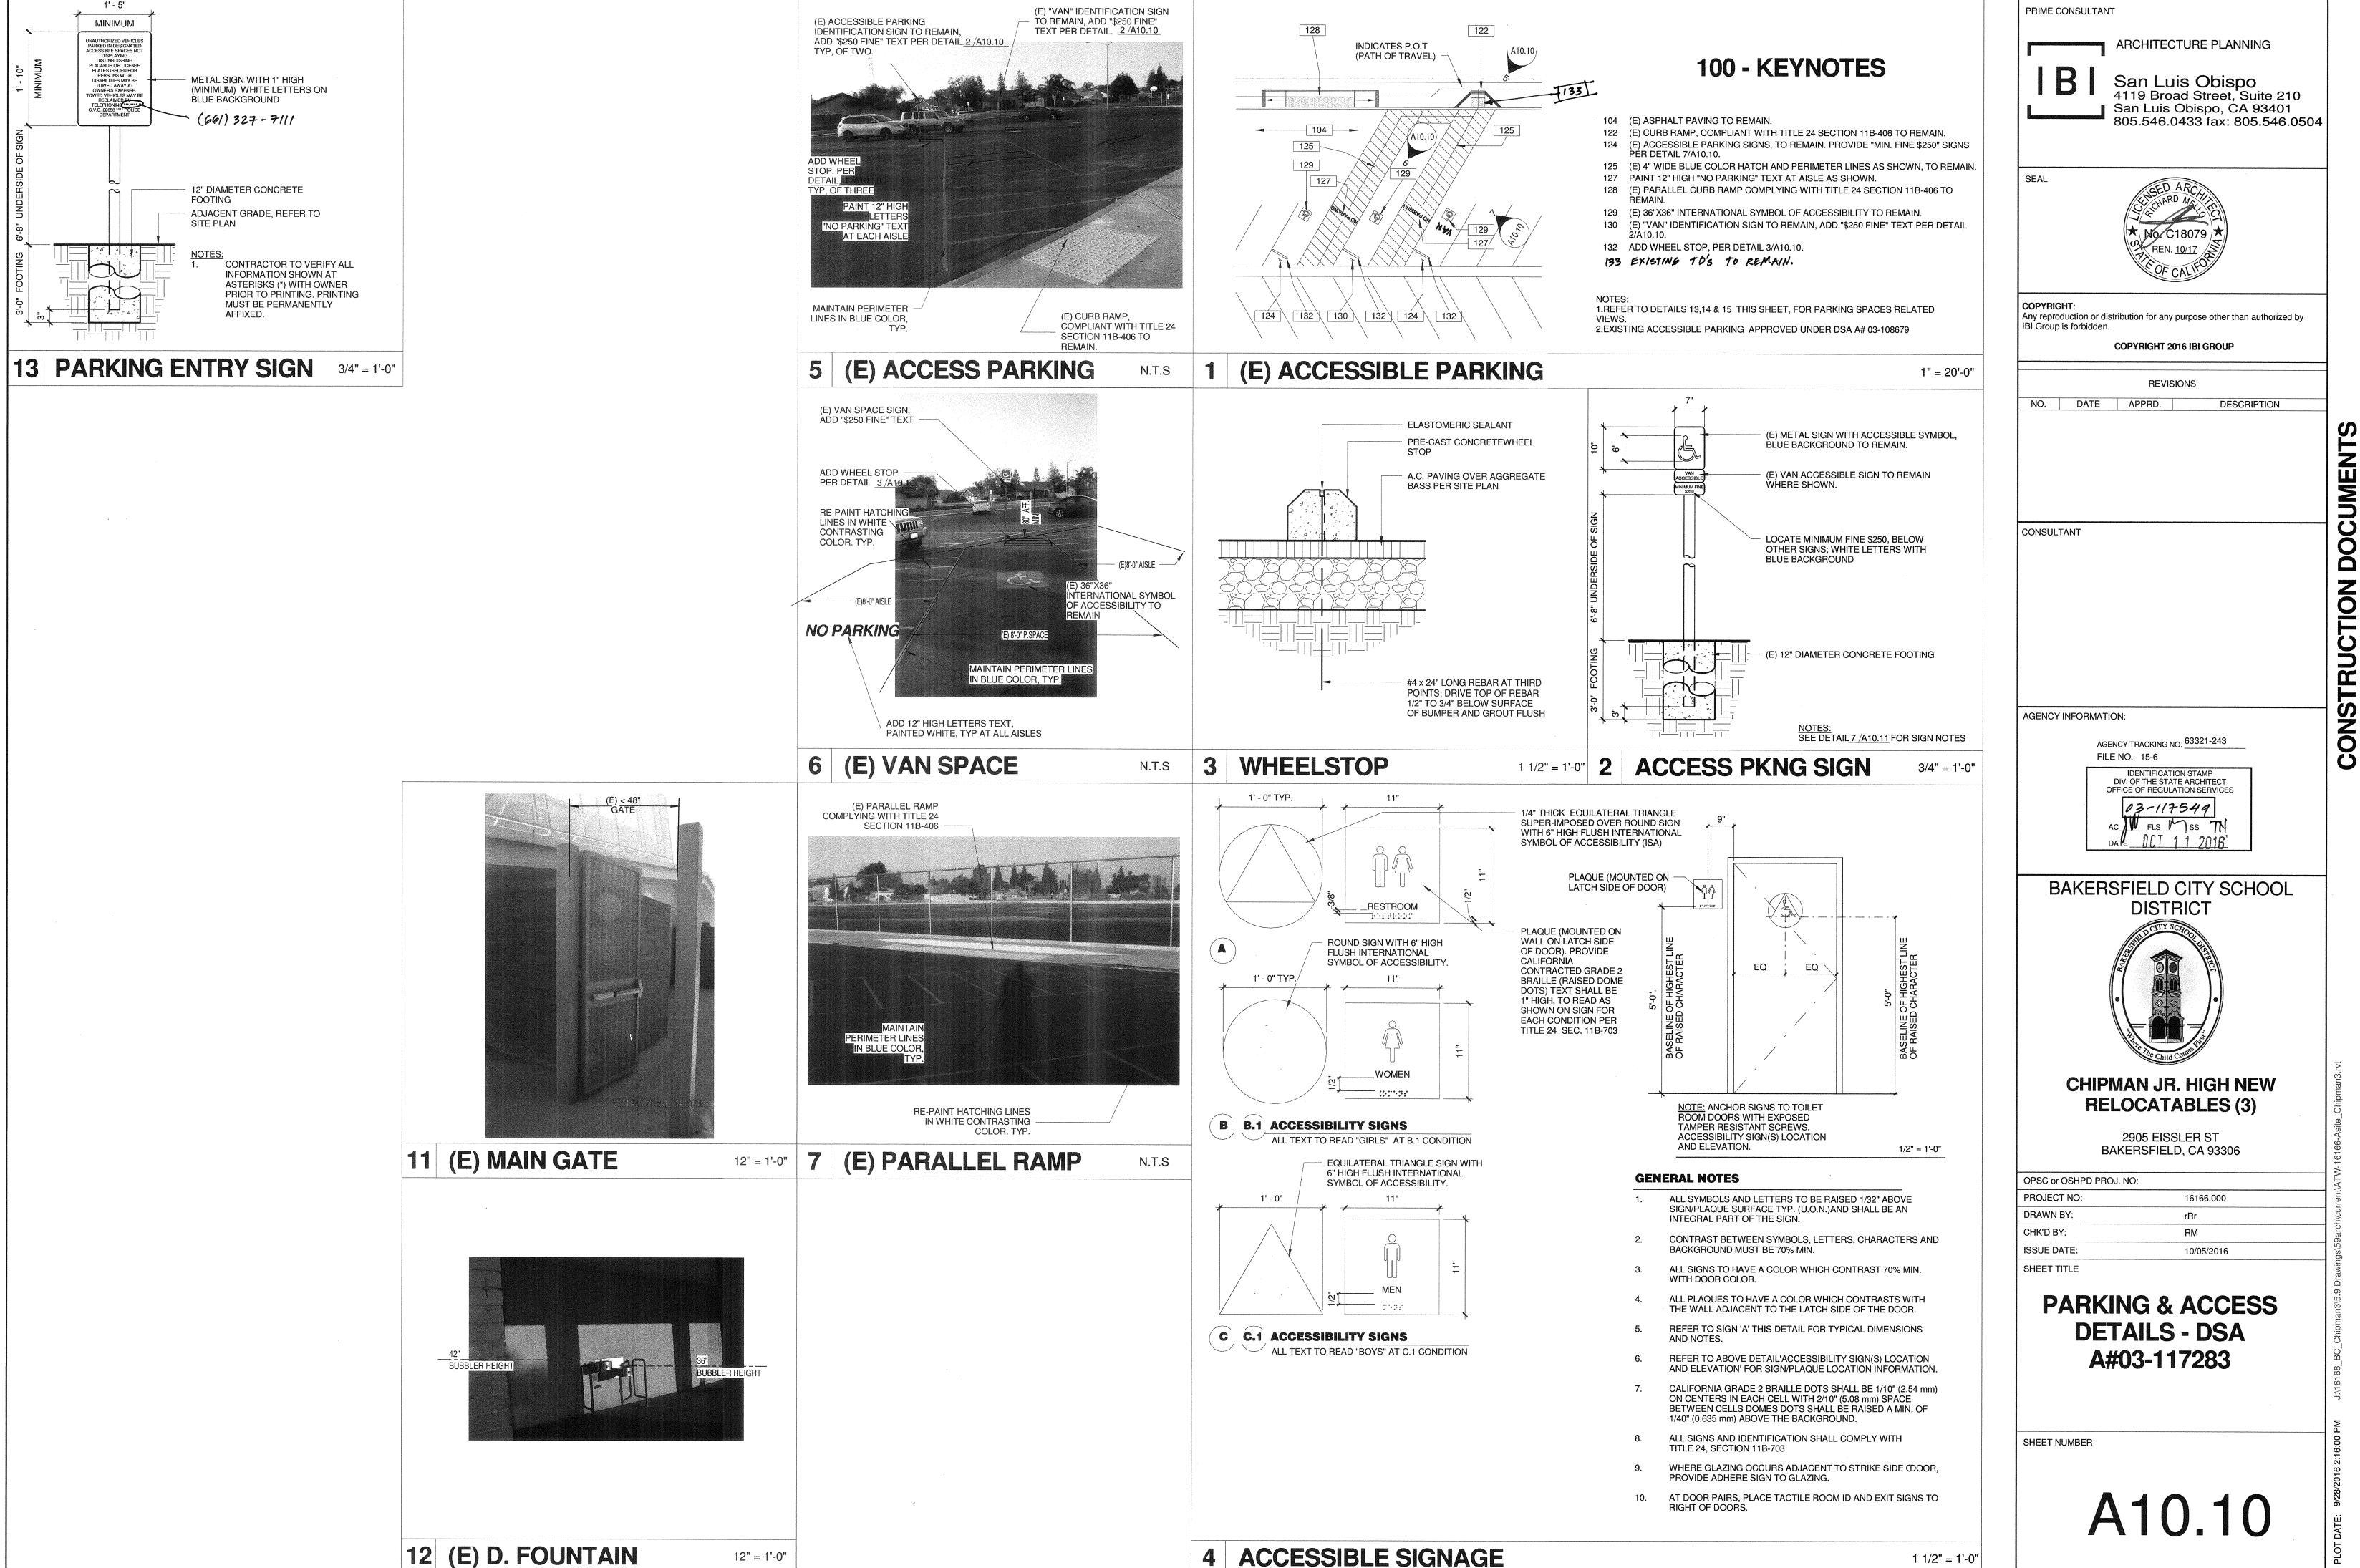


DOCUMENTS

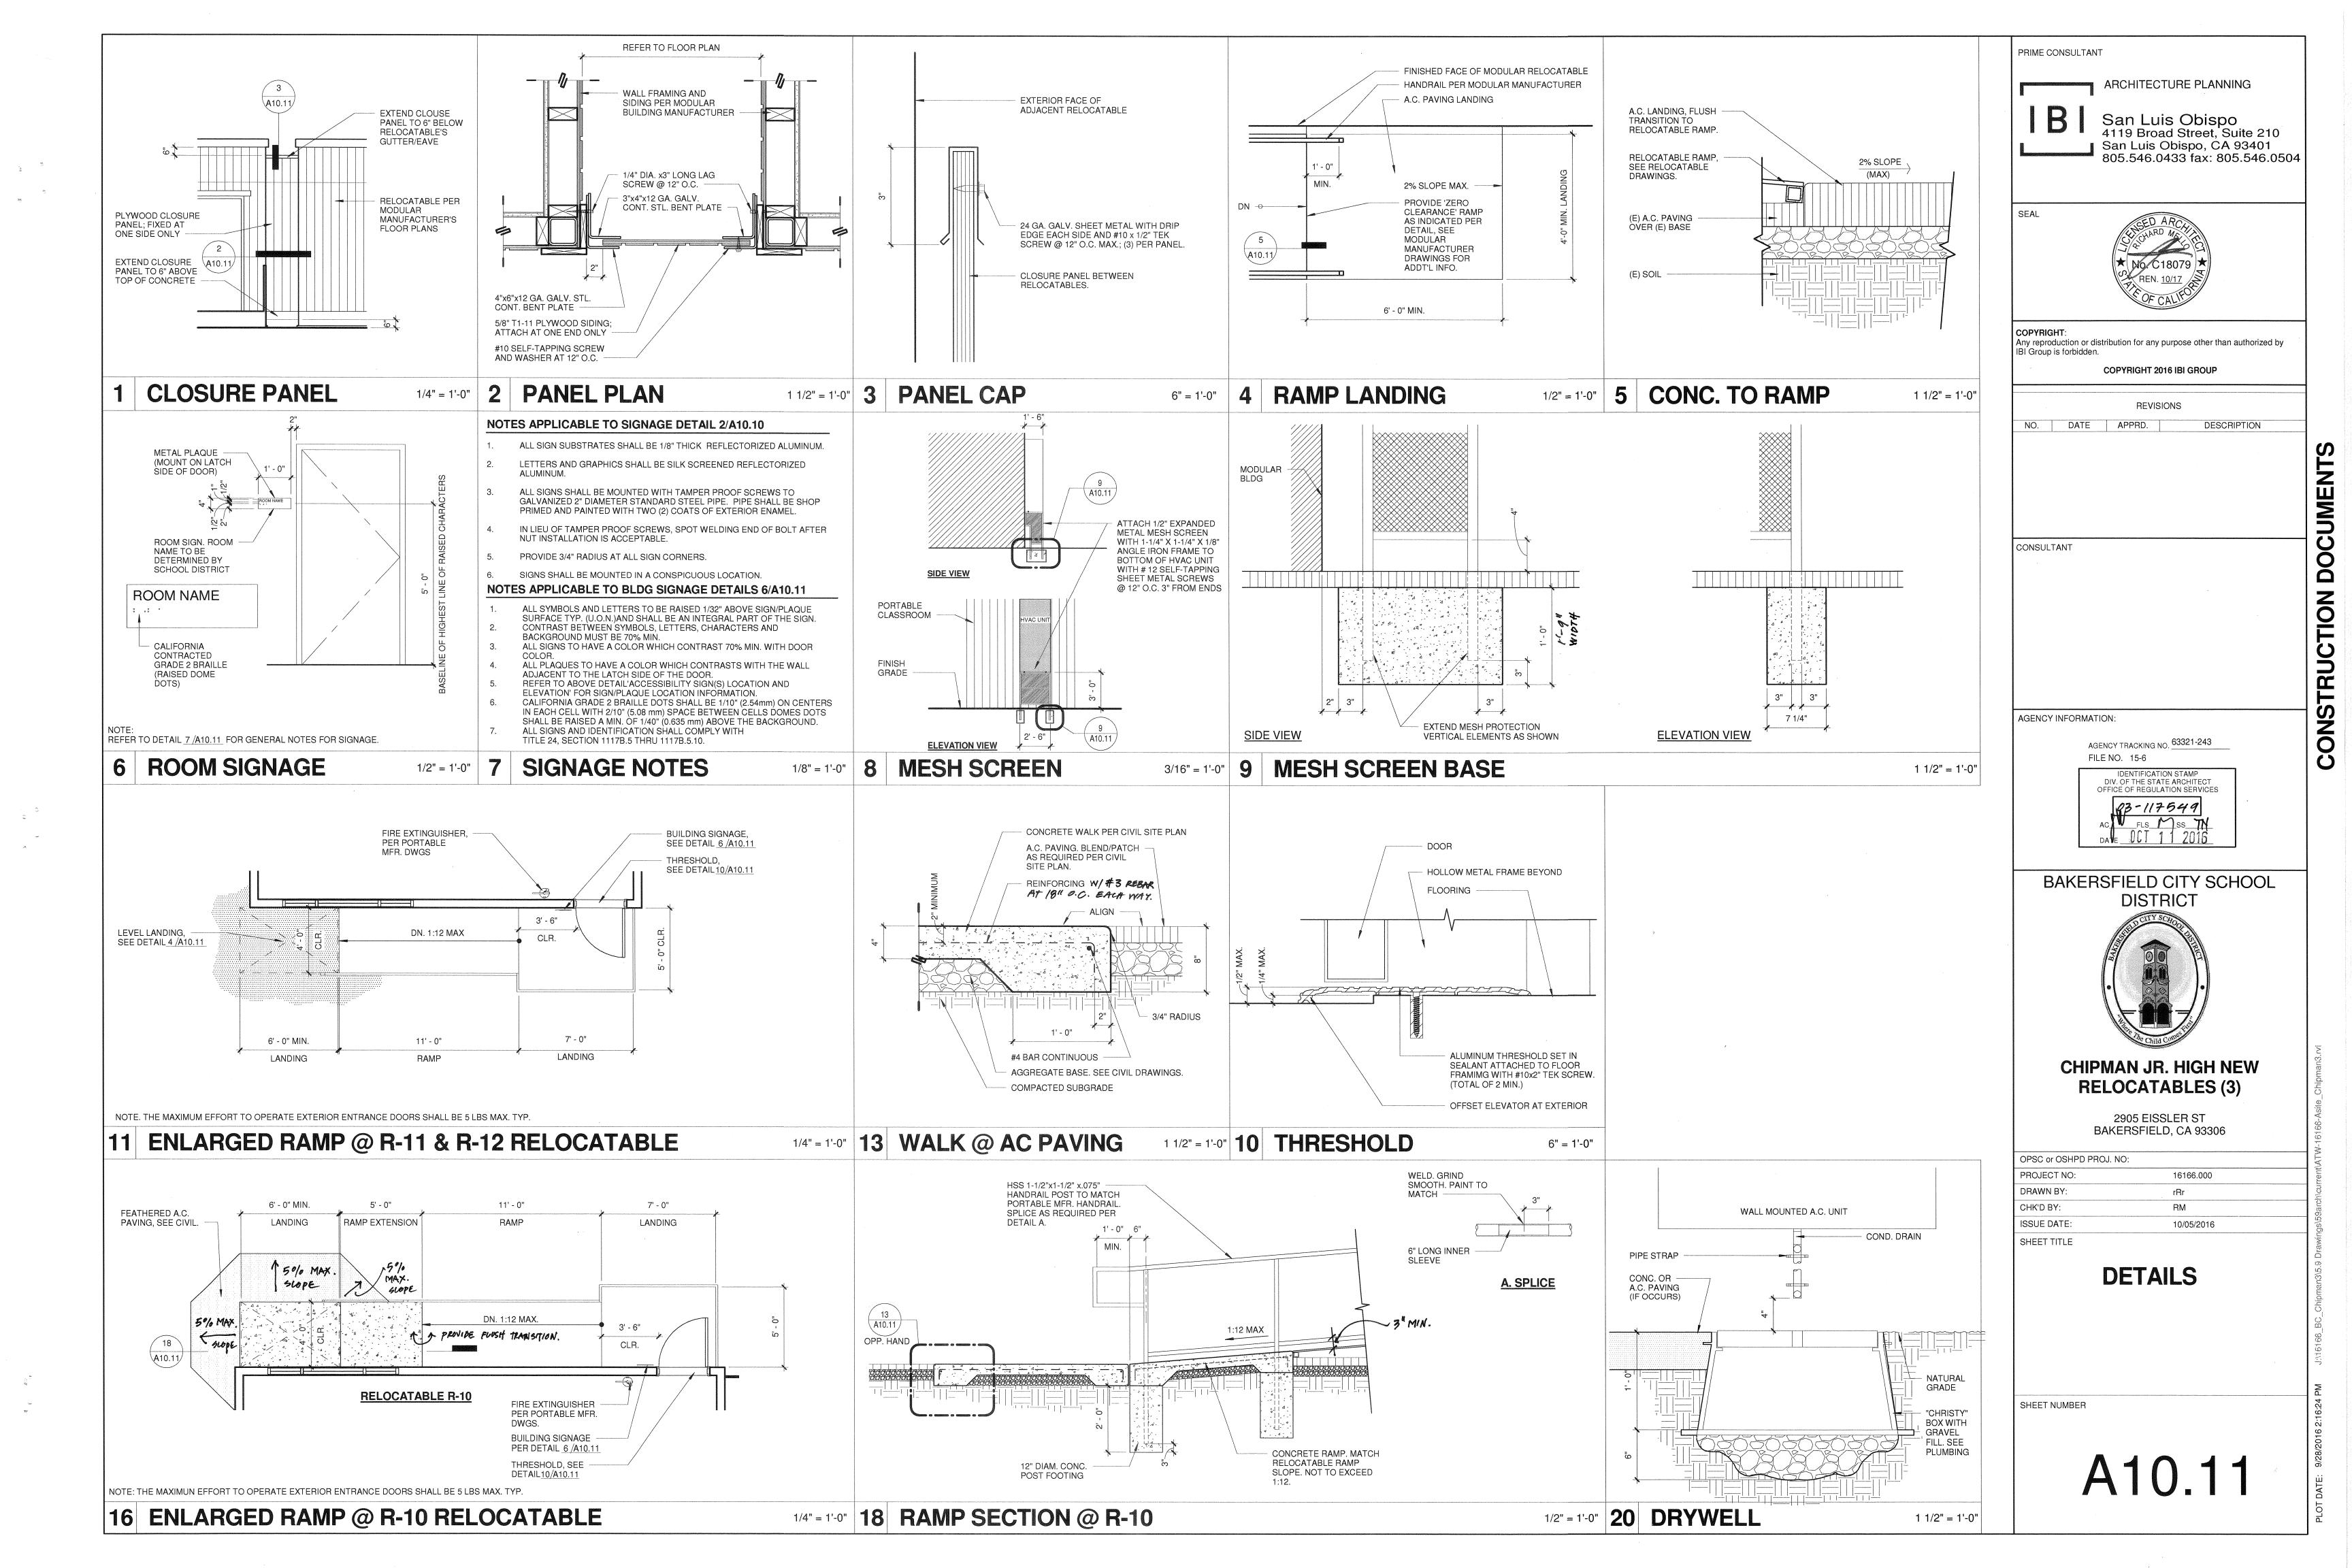

SINGLE LINE DIAGRAM

GENERAL NOTES

- VISIT JOB SITE AND VERIFY EXISTING CONDITIONS PRIOR TO BID.
- THE ELECTRICAL WORK SHALL BE INSTALLED IN ACCORDANCE WITH THE CALIFORNIA ELECTRICAL CODE AND ALL APPLICABLE LOCAL ORDINANCES. WHERE PLANS CALL FOR A HIGHER STANDARD THAN APPLICABLE CODES, THE PLANS SHALL GOVERN.
- CONDUIT RUNS ARE SHOWN DIAGRAMMATICALLY. EXACT LOCATIONS SHALL BE DETERMINED IN THE FIELD TO SUIT FIELD CONDITIONS.
- ALL ELECTRICAL EQUIPMENT, APPLIANCES AND LIGHTING FIXTURES SHALL BE LISTED BY A RECOGNIZED TEST LAB AND BEAR THAT LABEL OF APPROVAL.
- CONTRACTOR SHALL FURNISH, INSTALL AND CONNECT ALL MATERIAL AND EQUIPMENT FOR THIS WORK UNLESS OTHERWISE NOTED.
- FURNISH DISCONNECT SWITCHES AT REMOTE MOTORS.
- ALL SPACES AS INDICATED ON PANELS OR SWITCHBOARD SHALL BE COMPLETE WITH HARDWARE AND BUSSING FOR FUTURE BREAKER OR SWITCH.
- CHECK ARCHITECTURAL PLANS FOR DOOR SWINGS BEFORE INSTALLING SWITCH OUTLETS.
- GROUNDING AND BONDING SHALL BE PER CODE PLUS ANY ADDITIONAL PROVISIONS SPECIFIED OR SHOWN ON DRAWINGS.
- 10. ALL CONDUIT RUNS SHALL CONTAIN A CODE SIZED GROUND CONDUCTOR.
- 11. THESE PLANS ARE NOT COMPLETE UNTIL APPROVED BY THE AUTHORITY HAVING JURISDICTION.
- 12. ALL CONDUCTORS SHALL BE IN CONDUIT.
- 13. ALL CONDUCTORS SHALL BE COPPER WITH TYPE THHN/THWN INSULATION.
- 14. CURRENT CALIFORNIA BUILDING CODE ACCESS COMPLIANT MOUNTING HEIGHTS APPLY ONLY TO NEW OR RELOCATED ELECTRICAL SWITCHES, OUTLETS, PUSH BUTTONS ETC.. THEY SHALL COMPLY WITH CALIFORNIA BUILDING CODE 1117B.6.
- 15. COORDINATE WITH SERVING ELECTRICAL UTILITY COMPANY AND MAKE PROVISIONS FOR ELECTRICAL SERVICE ACCORDINGLY. INCLUDE ALL SERVICE COSTS AND UTILITY COMPANY CHARGES IN BID.
- COORDINATE WITH SERVING TELEPHONE UTILITY COMPANY AND MAKE PROVISIONS FOR TELEPHONE SERVICE

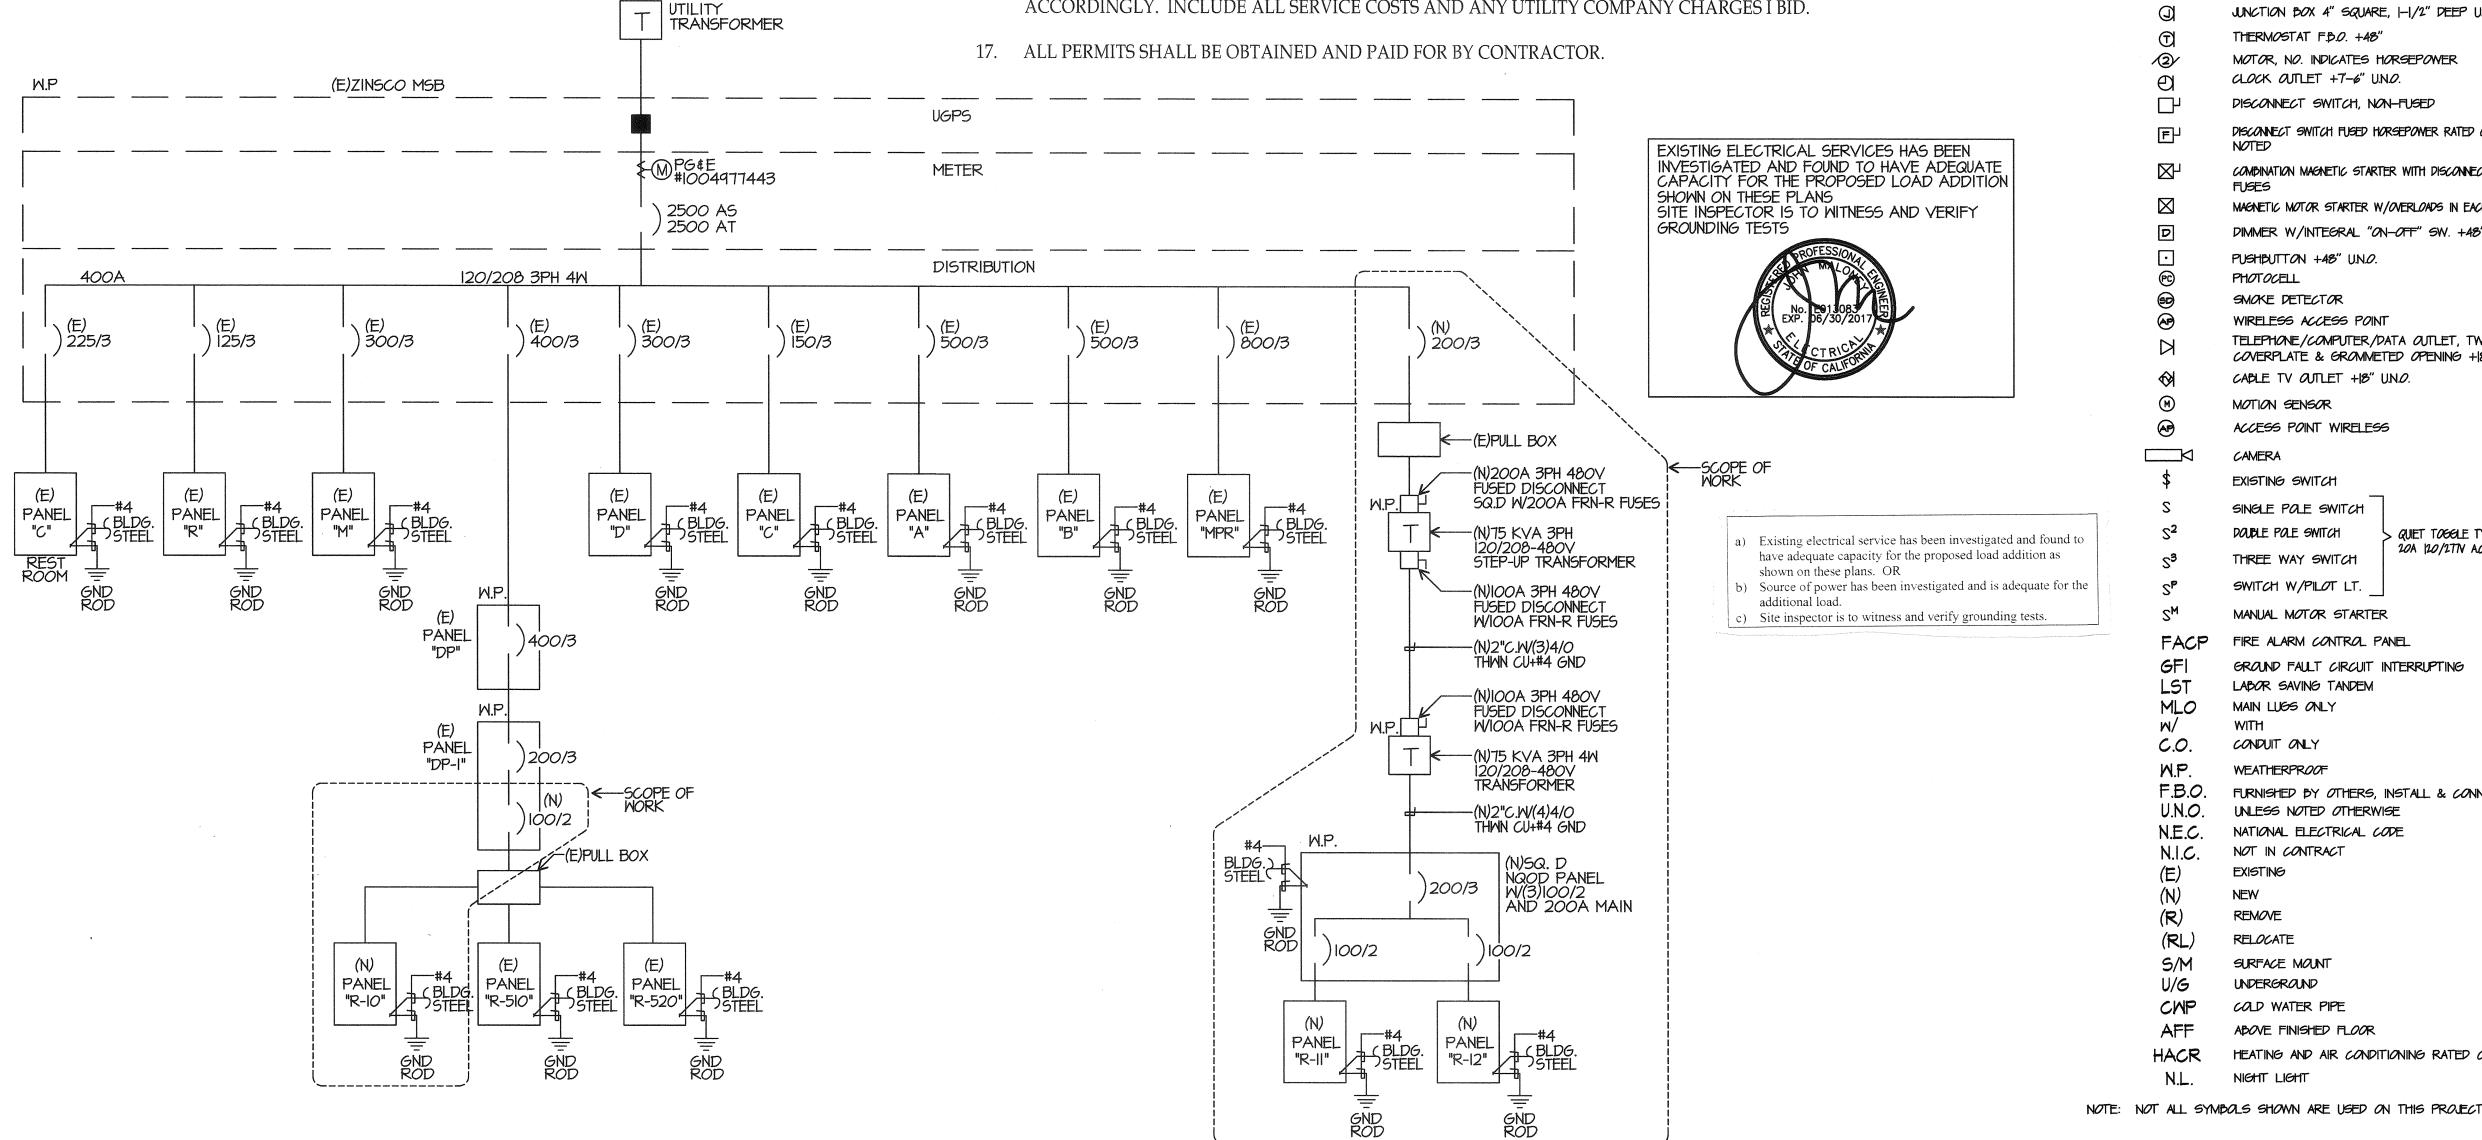

CONDUIT EXISTING CONDUIT CONCEALED IN WALL OR CEILING CONDUIT STUBBED OUT AND CAPPED CONDUIT TURNED UP CONDUIT TURNED DOWN CONDUIT IN 3/4" C., (3) MAX. IN 1"C., NO MARKS = 2 # 12

MECHANICAL EQUIPMENT DESIGNATION. SEE MECHANICAL DRAWINGS. SPECIAL RECEPTACLE - SEE PLAN

CEILING RECEPTACLE

THERMOSTAT F.B.O. +48"

CLOCK OUTLET +7-6" U.N.O.

PUSHBUTTON +48" U.N.O.

WIRELESS ACCESS POINT

CAPLE TV OUTLET +18" U.N.O.

ACCESS POINT WIRELESS

SMOKE DETECTOR

MOTION SENSOR

EXISTING SWITCH

DOUBLE POLE SWITCH

THREE WAY SWITCH

SWITCH W/PILOT LT.

MANUAL MOTOR STARTER

LABOR SAVING TANDEM

MAIN LUGS ONLY

CONDUIT ONLY

WEATHERPROOF

NOT IN CONTRACT

NEW

RELOCATE

SURFACE MOUNT

UNDERGROUND COLD WATER PIPE

NIGHT LIGHT

ABOVE FINISHED FLOOR

FIRE ALARM CONTROL PANEL

UNLESS NOTED OTHERWISE

NATIONAL ELECTRICAL CODE

GROUND FAULT CIRCUIT INTERRUPTING

FURNISHED BY OTHERS, INSTALL & CONNECT

HEATING AND AIR CONDITIONING RATED CIRCUIT BREAKER

SINGLE PALE SWITCH

CAMERA

PHOTOCELL

FLUGH FLOOR RECEPTACLE RECEPTACLE, DUPLEX, 15A, 125V, NEMA 5-15R +16" UNO. DUPLEX RECEPTACLE MTD. ABOVE BACKSPLASH+42" U.N.O.

RECEPTACLE, DUPLEX, 20A, 125V, NEMA 5-20R +18" U.N.O.

JUNCTION BOX 4" SQUARE, 1-1/2" DEEP U.N.O.

DISCONNECT SWITCH FUSED HORSEPOWER RATED OR SIZED AS

COMBINATION MAGNETIC STARTER WITH DISCONNECT SWITCH AN

TELEPHONE/COMPUTER/DATA OUTLET, TWO GANG BOX W/I GANG

QUIET TOGGLE TYPE RATED AT

20A 120/2TTV AC. +42" UNO.

MAGNETIC MOTOR STARTER W/OVERLOADS IN EACH PHASE DIMMER W/INTEGRAL "ON-OFF" SW. +48" UNO.


COVERPLATE & GROMMETED OPENING +18" U.N.O.

MOTOR, NO. INDICATES HORSEPOWER

DISCONNECT SWITCH, NON-FUSED

DUPLEX RECEPTACLE W/LOWER HALF SWITCHED +18" U.N.O. GROUND FAULT CIRCUIT INTERRUPTING RECEPTACLE 18" U.N.O. DOUBLE DUPLEX RECEPTAGLE +18" UN.O.

ACCORDINGLY. INCLUDE ALL SERVICE COSTS AND ANY UTILITY COMPANY CHARGES I BID.

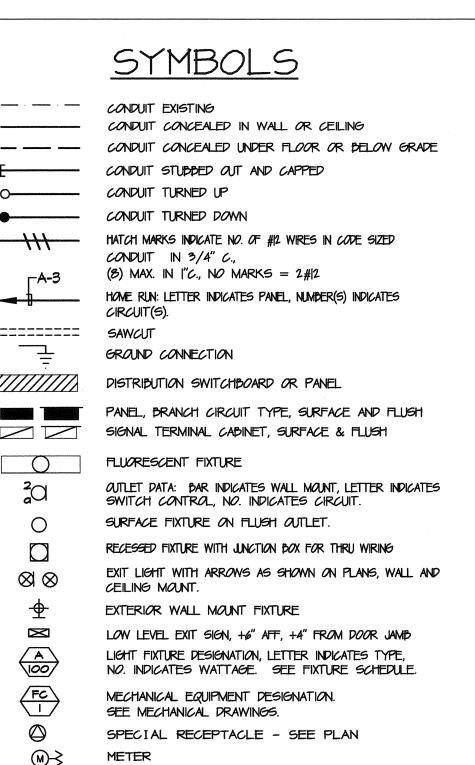

CONSULTANT LIGHT NG DESIGN SUITE 251 BAKERSFIELD, CA 9330 (661) 831-7851 FAX (661) 831-7813

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4115 Broad Street, Suite B-6

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San Luis Obispo, CA 93401

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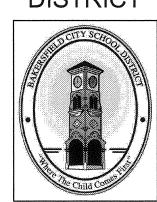
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DESCRIPTION

AGENCY TRACKING NO. __63321-243 FILE NO. 15-6

IDENTIFICATION STAMP DIV. OF THE STATE ARCHITECT OFFICE OF REGULATION SERVICES AC FLS MSS TH DATE OCT 1 1 2016

BAKERSFIELD CITY SCHOOL DISTRICT



CHIPMAN JR. HIGH NEW RELOCATABLES (3)


2905 EISSLER ST BAKERSFIELD, CA 93306

OPSC or OSHPD PROJ. NO: PROJECT NO: 16166.000 DRAWN BY: AC KT CHK'D BY: ISSUE DATE: 10/05/2016 SHEET TITLE

> SYMBOL LIST **GENERAL NOTES** SINGLE LINE DIAGRAM


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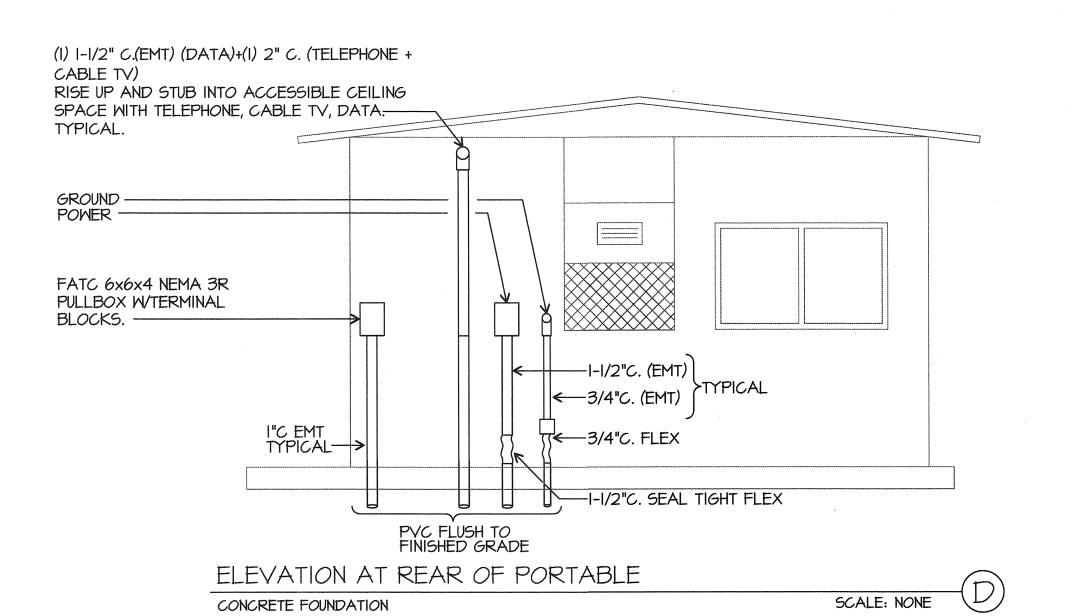
TYPICAL TRAILER STEEL FRAME BONDING/GROUNDING DETAIL


SCALE: NONE

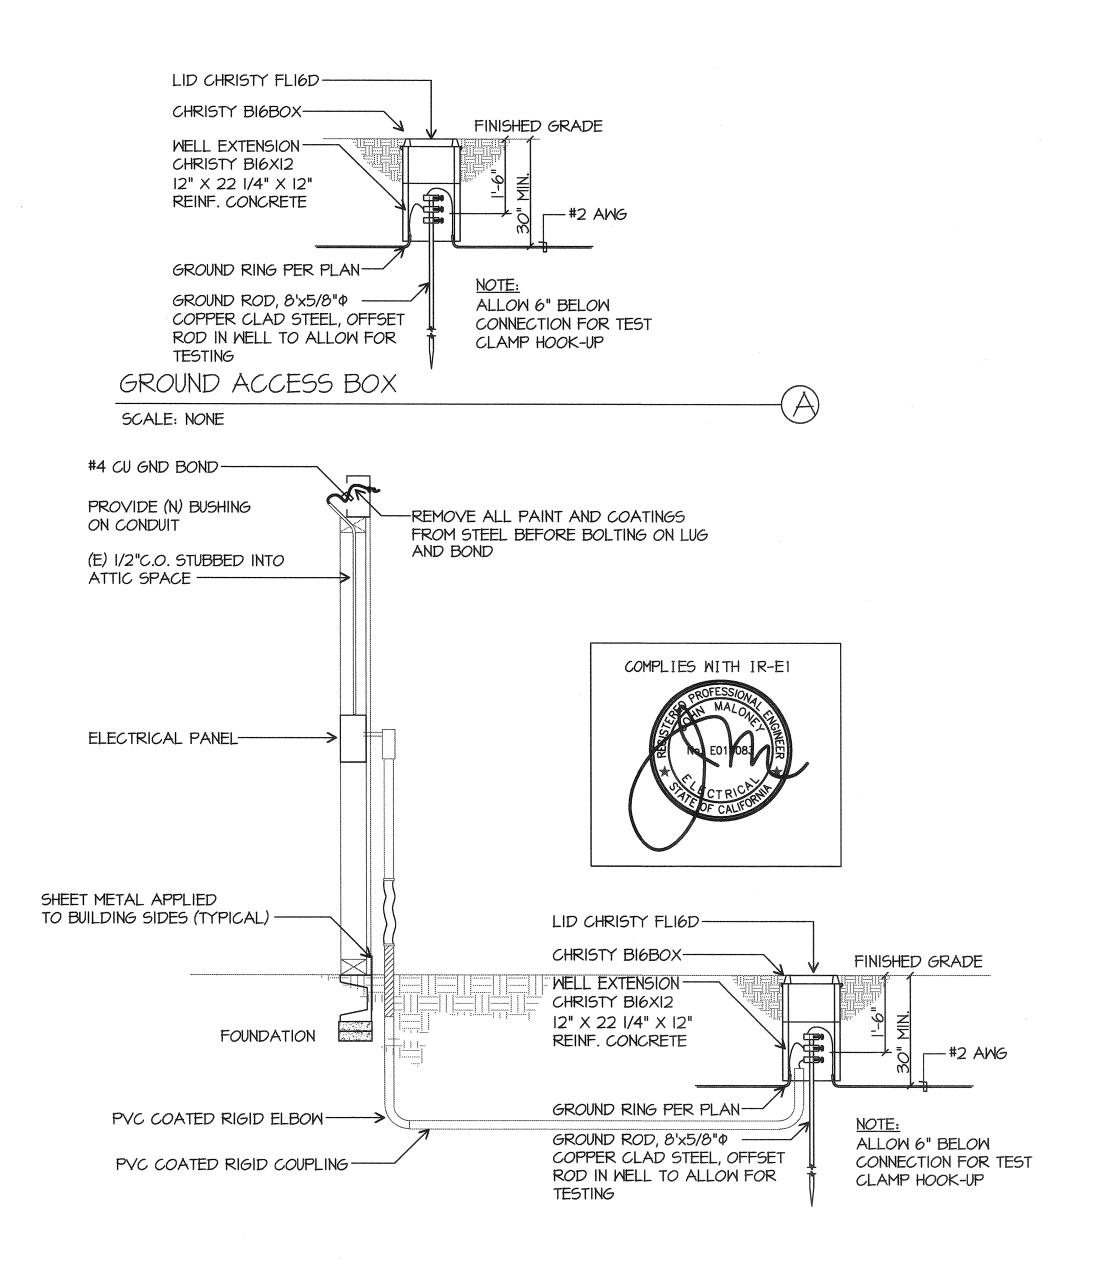

TYPICAL PORTABLE GROUNDING

SCALE: NONE

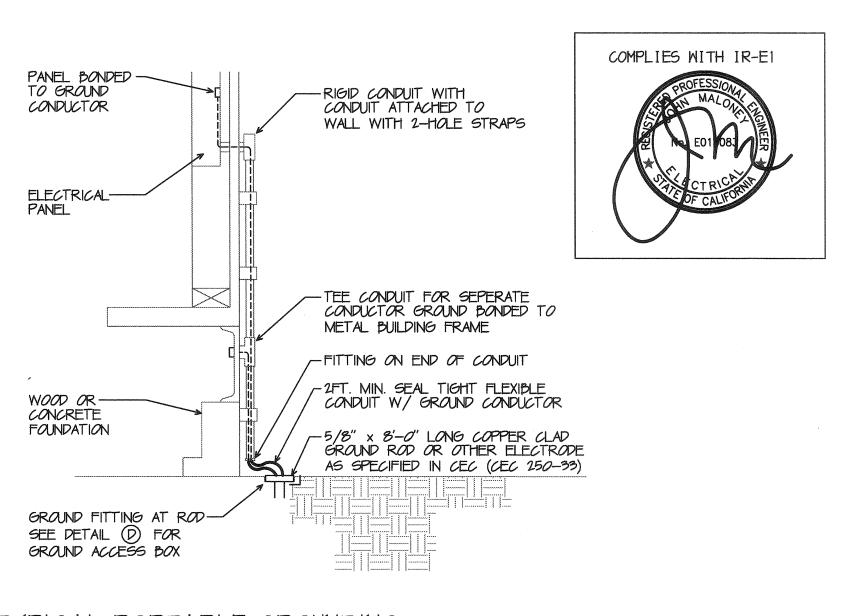

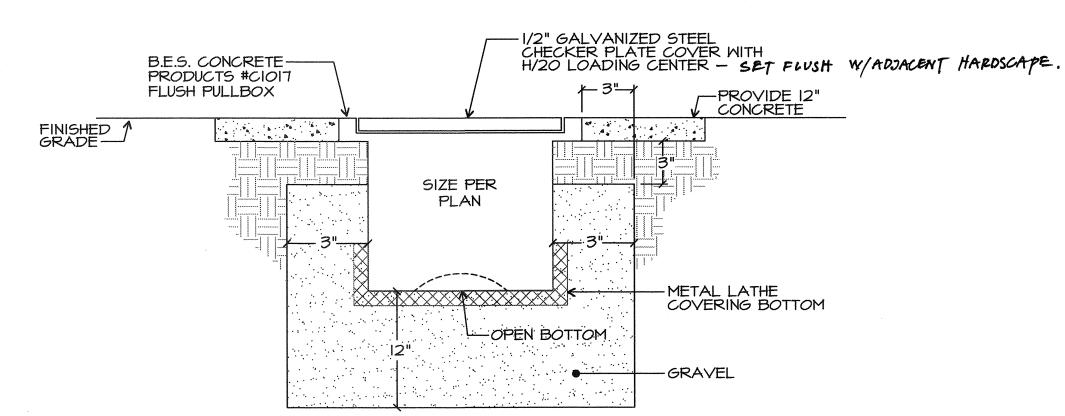


FLUSH PULLBOX DETAIL

SCALE: NONE

NOTES:

I. FOR OUTDOOR TRANSFORMER MOUNTING, CONCRETE PAD SHALL BE 6" WIDER THAN TRANSFORMER HOUSING. TOP OF PAD SHALL BE 2" ABOVE ADJACENT GRADE.

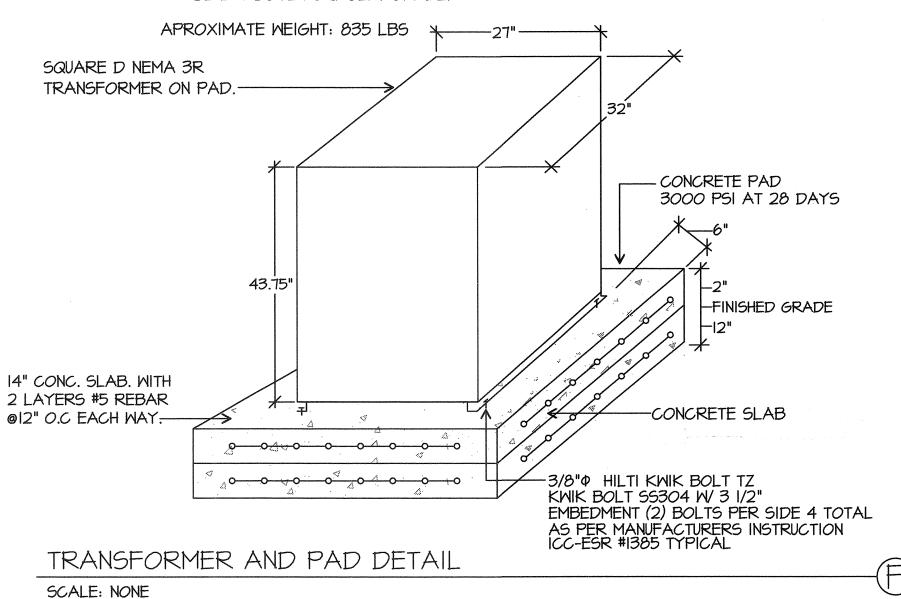

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BAKERSFIELD CITY SCHOOL DISTRICT



CHIPMAN JR. HIGH NEW RELOCATABLES (3)

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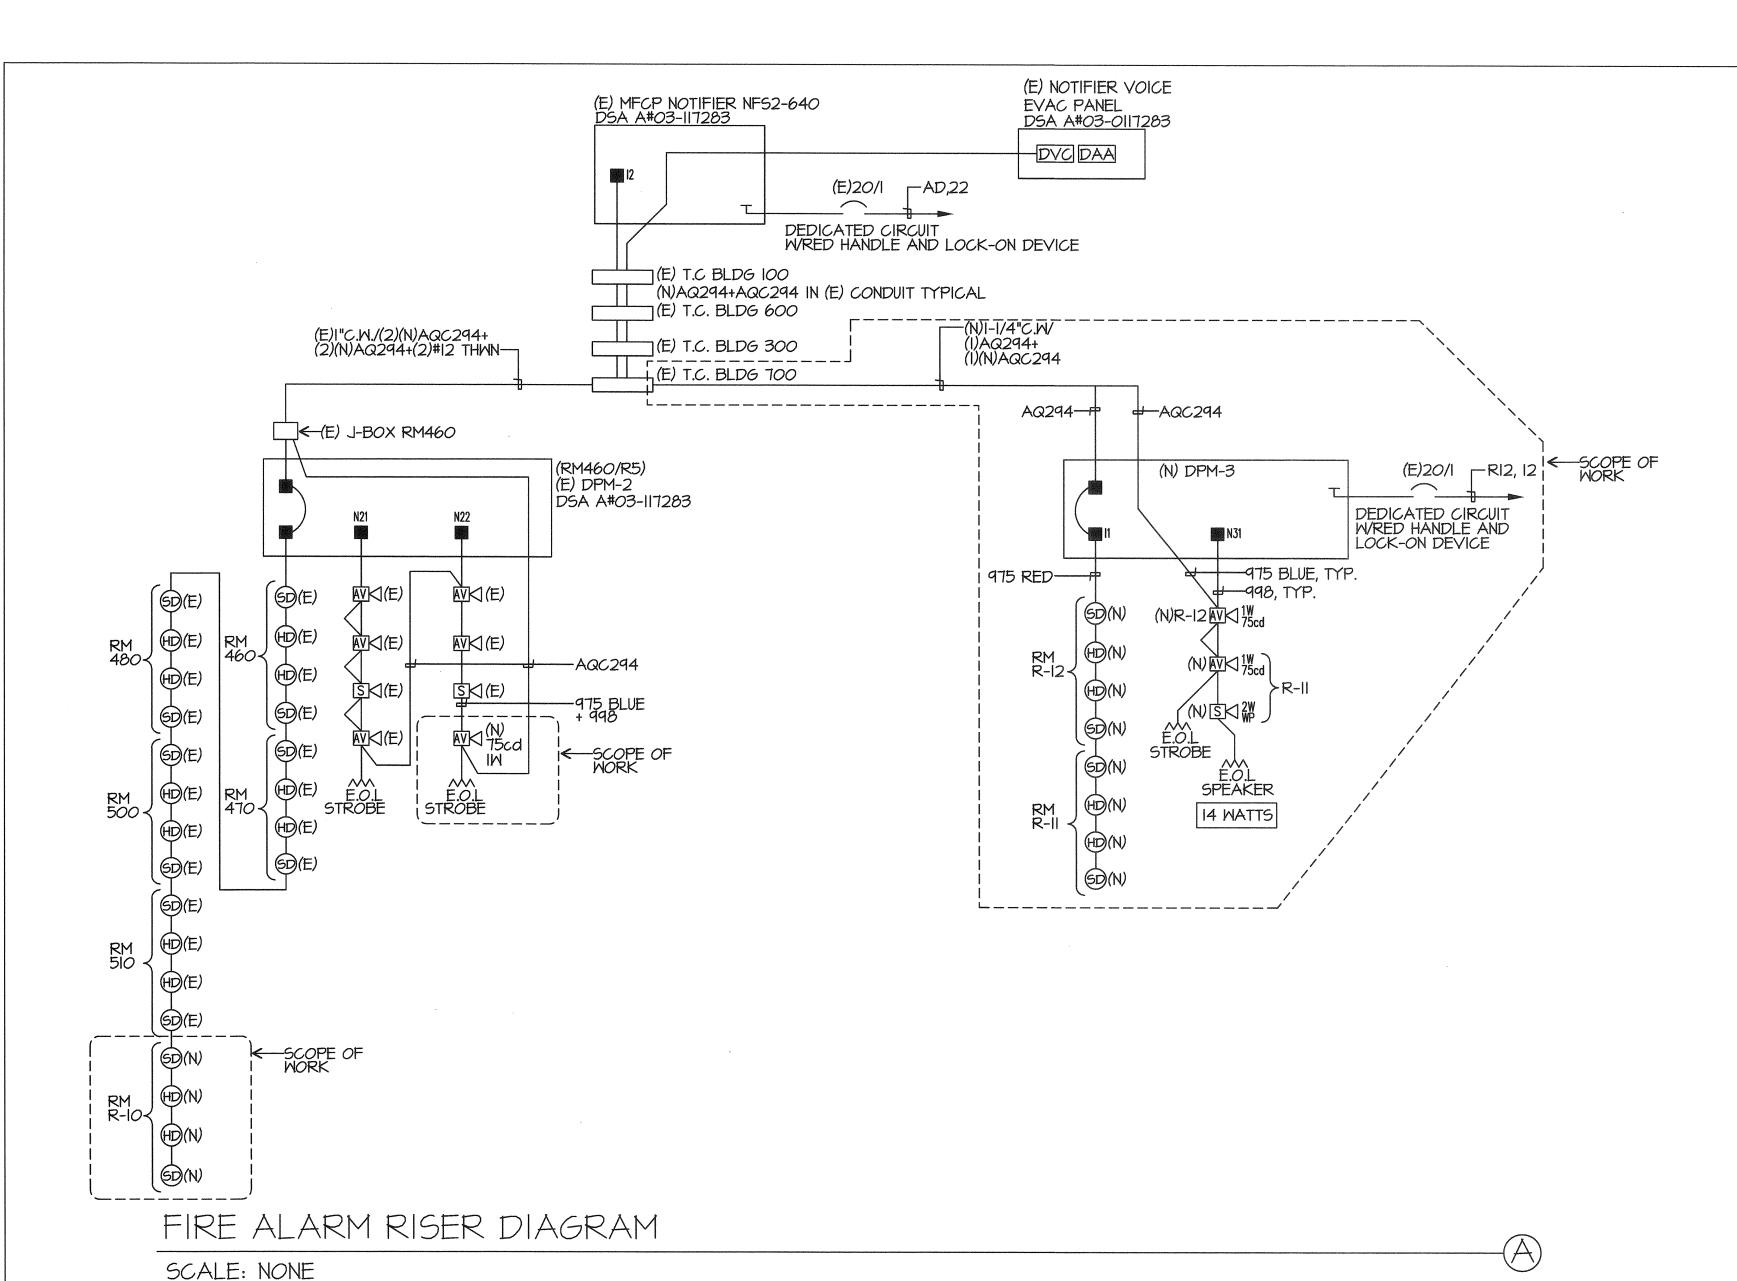
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DETAILS

SHEET NUMBER

SHEET TITLE

E-0.1



	F	A SYMBOL L	IST MATRIX	
SYMBOL	DEVICE	MFR & CAT N.	REMARKS	CSFM LISTING
<u></u>	SMOKE DETECTOR	NOTIFIER FSP-851	PROVIDE BASE B2IO LP ON 4"SQ. DEEP BOX	7272-0028:0206
D AV	SPEAKER/STROBE	NOTIFIER SPSR	PROVIDE 4"SQ. DEEP BOX	7320-1653:201
S MP	EXTERIOR HORN	NOTIFIER SPRK	PROVIDE MWBB >96"	7320-1653:201
(H)	HEAT DETECTOR (IN ATTIC SPACE)	NOTIFIER FST-851	PROVIDE BASE B2IO LP ON 4"SQ. DEEP BOX	7270-0028:0196
	(E)MAIN FIRE ALARM PANEL	NOTIFIER NFS2-640	EXISTING	7165-0028:0243
DPM	NAC POWER	NOTIFIER FCPS-24S6	SURFACE MOUNT 7Ah BATTERY	7315-0028:0225
DVC	DIGITAL VOICE COMMAND	NOTIFIER DVC-EM	EXISTING	7165-0028:0243
DAA	DIGITAL AUDIO AMP	NOTIFIER DAA-5025	EXISTING	7165-0028:0243
^	END OF LINE RESISTOR			
	FLP CABLE	WEST PENN AQ294 CABLE		7161-0859:0101
	FLP CABLE	WEST PENN AQC294 CABLE		7161-0859:0101
	FLP CABLE	WEST PENN 975 CABLE		7161-0859:0101
	FLP CABLE	WEST PENN 998 CABLE		7161-0859:0101

FIRE ALARM SEQUENCE (INITIATION	OF OPERA	TION		
RESPONSE	AREA SMOKE DETECTOR	AREA THERMAL DETECTOR	FULL STATION	AC POWER FAILURE
ANNUNCIATE AT FIRE CONTROL ROOM ALARM AND TROUBLE	YES	YES	YES	YES (TROUBLE)
CENTRAL STATION MONITORING	YES	YES	YES	YES
ACTIVATE AUDIO VISUAL THROUGHOUT FLOOR OF ALARM	YES	YES	YES	YES
CENTRAL STATION MONITORING	YES	YES	YES	YES
ACTIVE SPEAKERS	YES	YES	YES	NO

FIRE WATCH, FIRE MARSHAL REQUIREMENTS:

REQUIREMENTS FOR DISABLING THE FIRE ALARM SYSTEM;

- 1. As required by the **2013 CALIFORNIA FIRE CODE**, Section 901.7, standby personnel or systems temporarily "OUT OF SERVICE". The local Fire Marshal is authorized to require the Contractor to provide standby personnel as set forth in these sections, until the system is restored to operation.
- 2. Such individual shall be subject to the local Fire Marshal's order at all times when so employed and shall remain on duty during the time such places are open to the public or when such public activity is being conducted. Fire watch personnel shall be provided with at least one approved means for notification of the Fire Department.
- 3. Such individuals shall keep a diligent watch for fires and be able to take prompt and appropriate action in the event of a fire. Such individuals shall not be required or permitted, while on duty, to perform any other duties than these herein specified.

Existing FIRE ALARM BAT	TERY CALCULATION-DI	STRIBUTED POW	ER MODU				
DPM-2				SUPER			ALARM
EQUIPMENT D	ESCRIPTION	QUANTITY		CURRENT		CURRENT	
				l	ERES)		PERES)
		EXISTING	NEW	EACH	SUB-TOTAL	EACH	SUB-TOTAL
DISTRIBUTED POWER MO	DULE	1	0	0.065	0.065	0.145	0.145
FCM-1		1	0	0.0003	0.0003	0.0003	0.0003
		0	0	0	0	0.062	0
VISUALS	15 cd	0	0	0	0	0.066	0
VISUALS	15/75 cd	0		0	0	0.077	0
VISUALS	30 cd	0	0	0	0	0.094	0
VISUALS	75 cd	5	1	0	0	1	0.948
VISUALS	95 cd	0	0	0	0	0.202	0
		0	0	0	0	0	0
SUB TOTAL AMPERES				0.0653	AMPS	1.0933	AMPS
				x 24 HOURS		X 0.25 HO	JRS
SUB TOTAL AMPERE-HOU	RS			1.5672	A.H.	0.273325	A.H.
TOTAL REQUIRED AMPER	E-HOURS FOR DISTRIBU	JTED POWER MC	DULE			1.840525	A.H.
BATTERY NON-LINEAR DIS	CHARGE CHARACTER!	STIC FACTOR					x 1.2
TOTAL MINIMUM AMPERE	HOURS REQUIRED					2.20863	A.H.
PROVIDED BATTERY CAP.	ACITY					7.00	A.H.

DPM-3			SUPER	RVISORY		ALARM
EQUIPMENT DESCRIPTION	QUANTITY		Cl	JRRENT	C	URRENT
				IPERES)	(AN	(IPERES)
	EXISTING	NEW	EACH	SUB-TOTAL	EACH	SUB-TOTAL
DISTRIBUTED POWER MODULE	0	1	0.065	0.065	0.145	
FCM-1	0	1	0.0003	0.0003	0.0003	0.0003
HORNS	0	0	0	0	0.062	0
VISUALS 15 cd	0	0	0	0	0.066	0
VISUALS 15/75 cd	0	***************************************	0	0	0.077	0
VISUALS 30 cd	0		0	0	0.094	3
VISUALS 75 cd	0	2	0	0	0.158	1
VISUALS 95 cd	0	0	0	0	0.202	1
	0	0	0	0	0	1
	0	0	0	0	0	1
SUB TOTAL AMPERES			0.0653		L	AMPS
		•	x 24 Houf		X 0.25 HO	
SUB TOTAL AMPERE-HOURS			1.5672	A.H.	0.115325	A.H.
TOTAL REQUIRED AMPERE-HOURS FOR DIST	RIBUTED POWER MO	DULE			1.682525	9
BATTERY NON-LINEAR DISCHARGE CHARACT	ERISTIC FACTOR					x 1.2
TOTAL MINIMUM AMPERE HOURS REQUIRED					2.01903	5
PROVIDED BATTERY CAPACITY					7.00	A.H.

INEV VOICE PANEL	BATTERY CALCULATION	- DAC-EIAI				<u></u>	<u> </u>
				SUPE	RVISORY		ALARM
EQUIPI	MENT DESCRIPTION	QUANT	ΓΙΤΥ	C	URRENT	CURRENT	
				(AN	(IPERES)	(AN	(IPERES
		EXISTING	NEW	EACH	SUB-TOTAL	EACH	SUB-TO
DVC		.1	0	0.44	0.44	0.44	
DAA 5025		1	0	0.35	0.35	1.9	
					0		
1/4 Watt Speaker		0	0	0	0	0.017	
1 Watt Speaker		5	3	0	0	0.068	O
2 Watt Speaker		2	1		0	0.132	C
		0	0		0	0	
VISUALS	75 cd	0	0		0	0.158	
VISUALS	30 cd	0	0	0	0	0.094	
VISUALS	15 cd	0	0	0	0	0.066	
		0	0	0		0	1
SUB TOTAL AMPER	RES			0.79	AMPS	3.28	AMPS
į				x 24 HOUF	२८	X 0.25 HO	URS
SUB TOTAL AMPER	RE-HOURS			18.96	A.H.	0.82	A.H
	AMPERE-HOURS FOR DIST			E		19.78	· -
	EAR DISCHARGE CHARACT		R				x 1.2
TOTAL MINIMUM AN	MPERE HOURS REQUIRED					23.736	A.H
Existing BATTERY (CAPACITY					55.00	A.H

	LARM BATTERY CA			····	RVISORY	AI	ARM
EQUIPMENT DESC	CRIPTION	QUAN	ITITY	CUF	RRENT	CUI	RRENT
				(AM	PERES)	(AM	PERES)
		EXISTING	NEW	EACH	SUB-TOTAL	EACH	SUB-TOTA
FIRE ALARM PANEL		1	0	0.1	0.1	0.1	0
DIGITAL ALARM COMMUNIC	CATOR	1	0	0.02	0.02	0.02	0.0
SUPERVISED OUTPUT MODU	LE			0.00022	0	0.0003	
				0	0	0	
SMOKE DETECTOR		15	6	0.00039	0.00936	0.00039	0.008
HEAT DETECTOR		13	6	0.00035	0.0077	0.00035	0.006
HORNS		8	0		0	0.062	0.49
AUDIBLE/VISUALS	75 cd	18	0		0	0.121	2.1
AUDIBLE/VISUALS	15 cd	21			0	0.052	1.0
SUB TOTAL AMPERES				0.13706	AMPS	3.90084	AMPS
				x 24 HOU	RS	x 0.084 HO	OURS
SUB TOTAL AMPERE-HOURS				3.28944	A.H.	0.327671	A.H.
TOTAL REQUIRED AMPERE-F				E		3.617111	A.H.
BATTERY NON-LINEAR DISC		RISTIC FACT	OR				x 1.2
TOTAL MINIMUM AMPERE H	OURS REQUIRED					4.340533	<u> </u>
BATTERY AH SUPPLIED						26.00	A.H.

VOLTAGE DROP CALCULATIONS							
CIRCUIT	2x	LENGTH x	AMPS x	RESISTANCE x	= VOLTS	VOLTAGE DROP	
N22	2	200	0.474	0.00205	0.389	1.62 %	
N31	2	120	0.316	0.00205	0.155	0.65 %	

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BAKERSFIELD CITY SCHOOL DISTRICT



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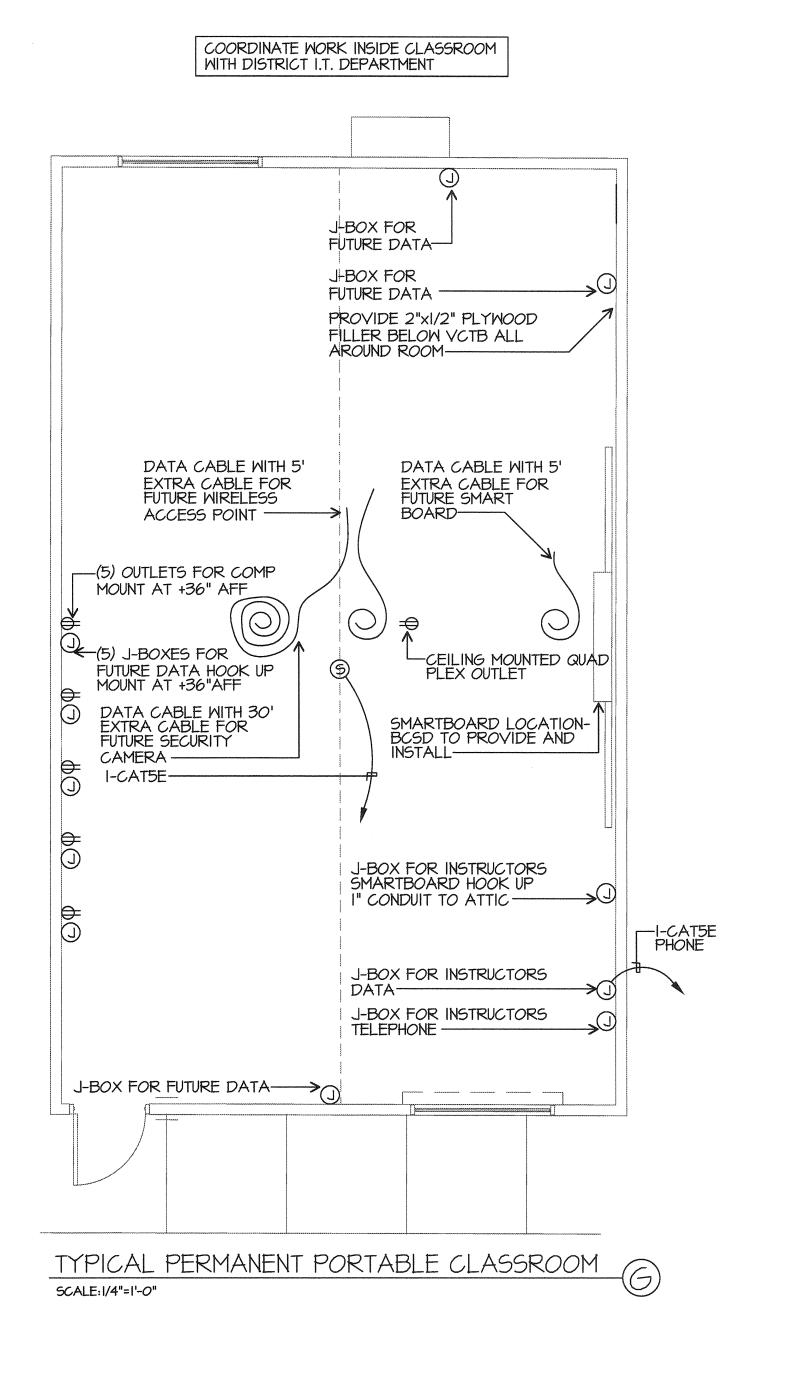
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PROJECT NO:	16166.000
DRAWN BY:	AC
CHK'D BY:	KT
ISSUE DATE:	10/05/2016


FIRE ALARM RISER CALCULATIONS

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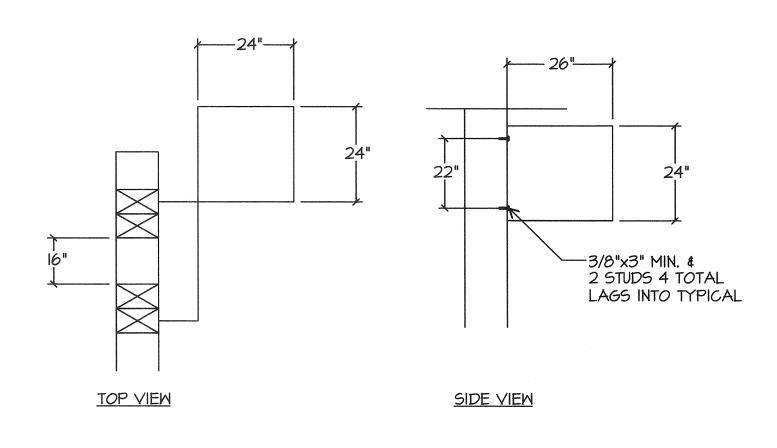
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E-0.2







DPM ATTACHMENT MOUNTING DETAIL, WOOD SCALE: NONE

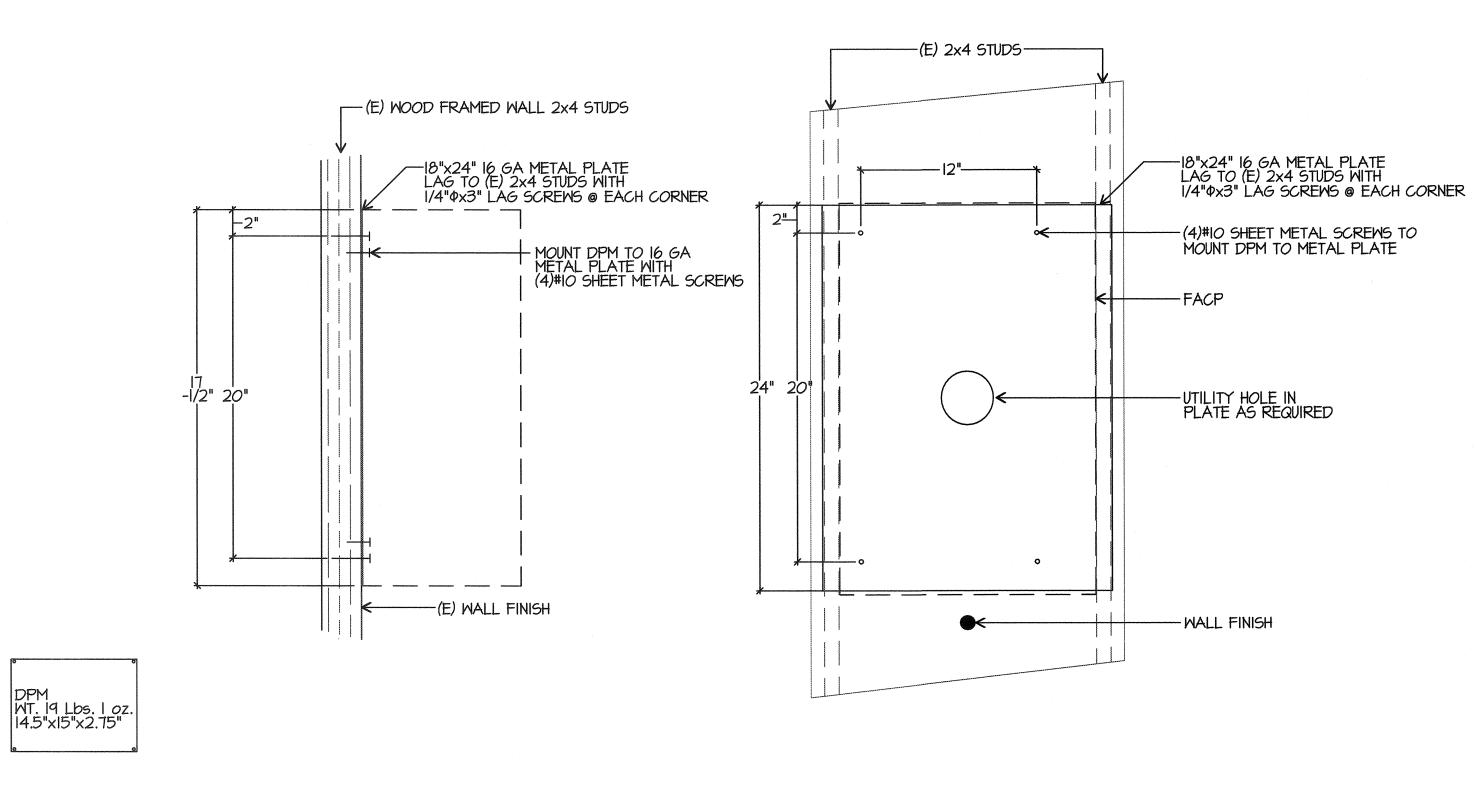


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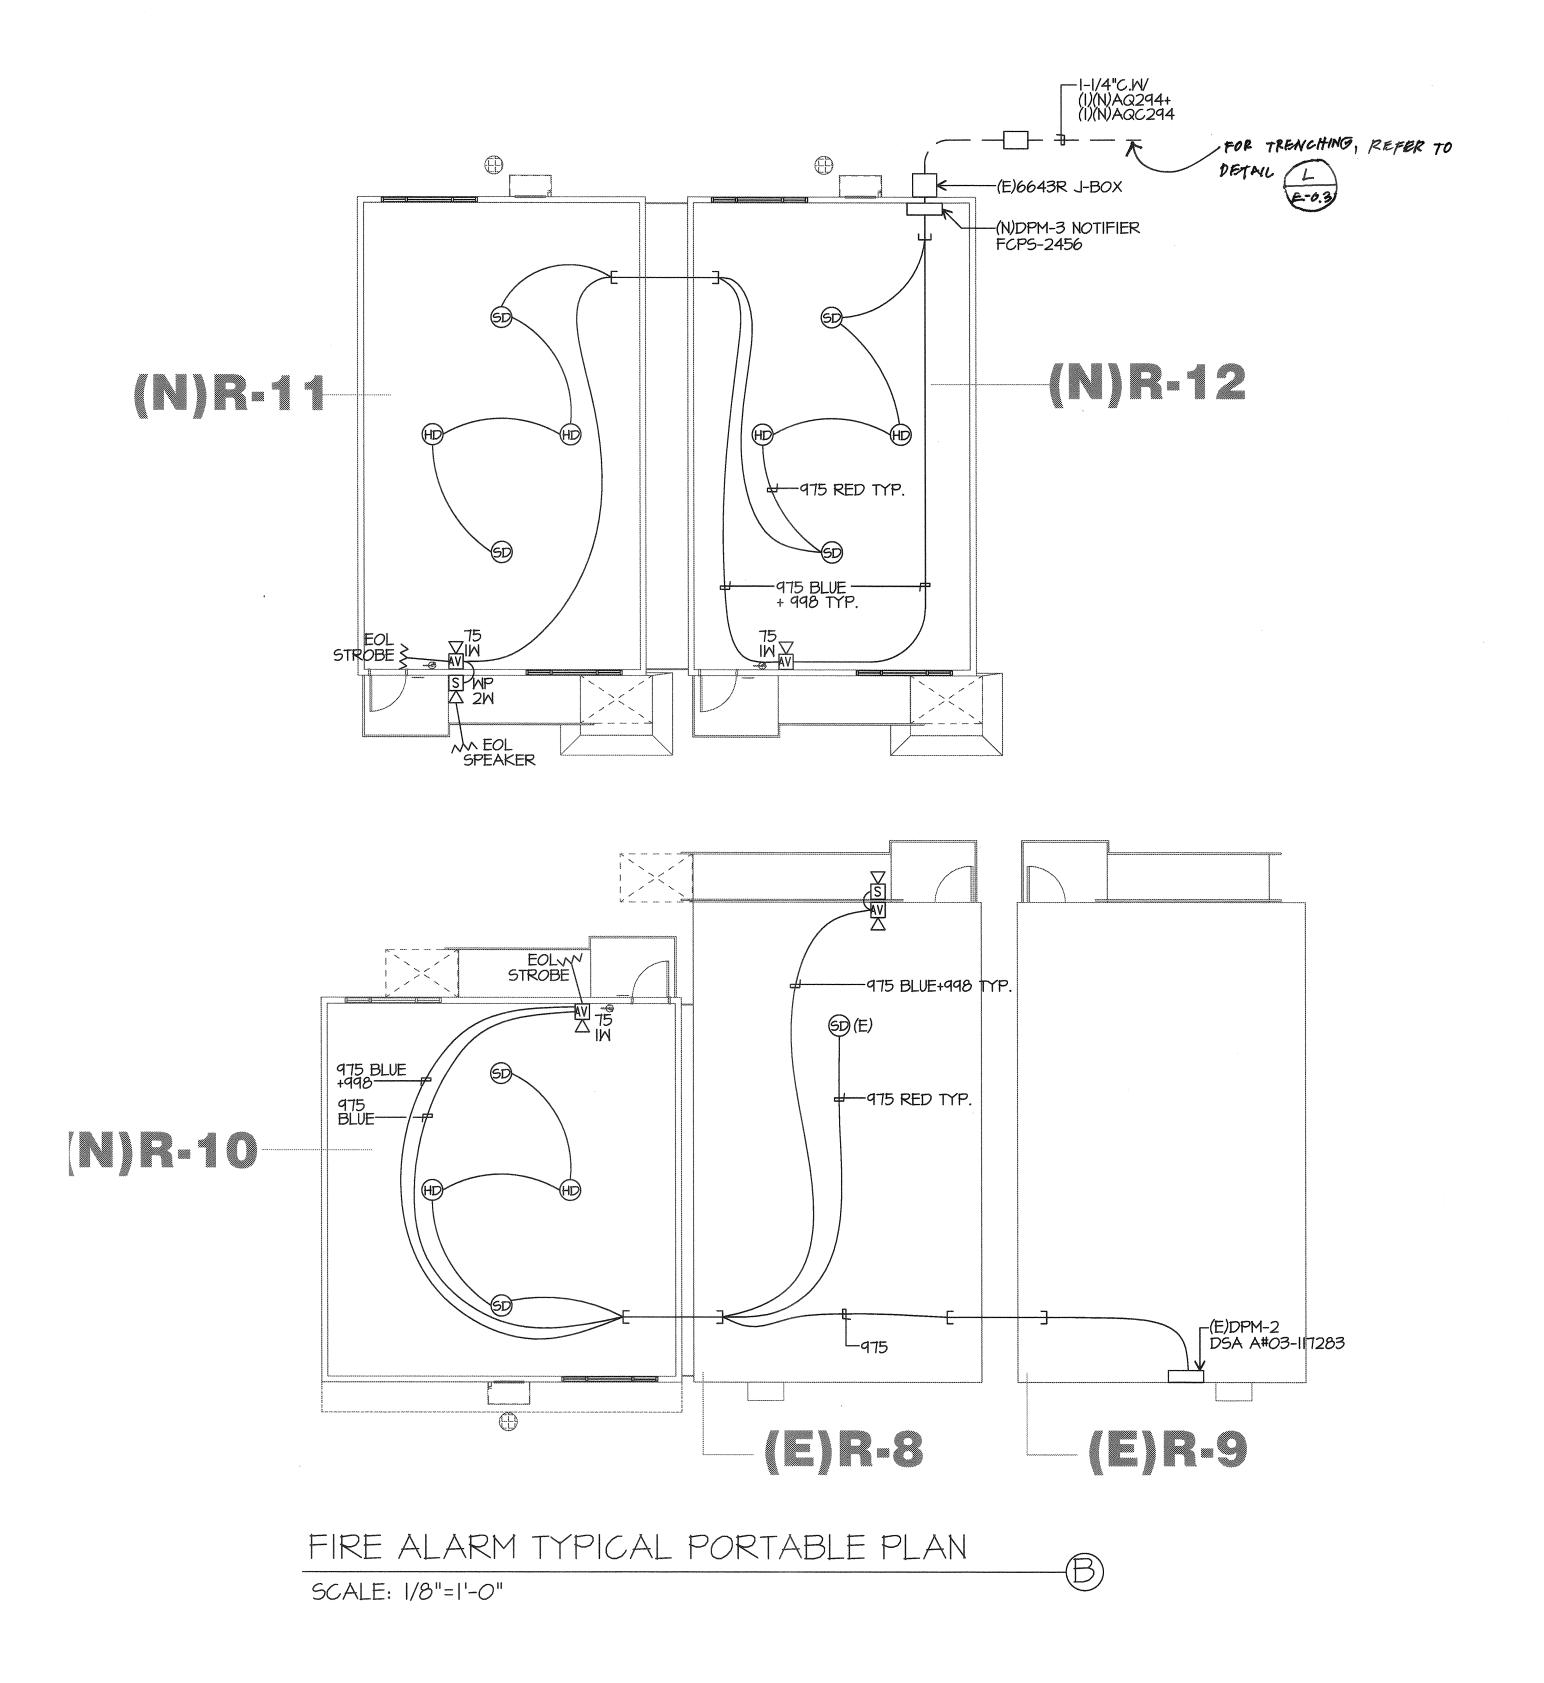
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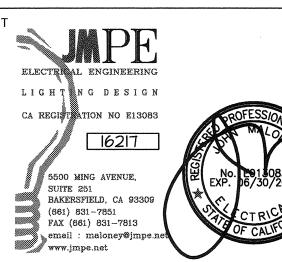


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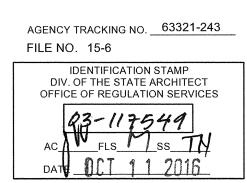
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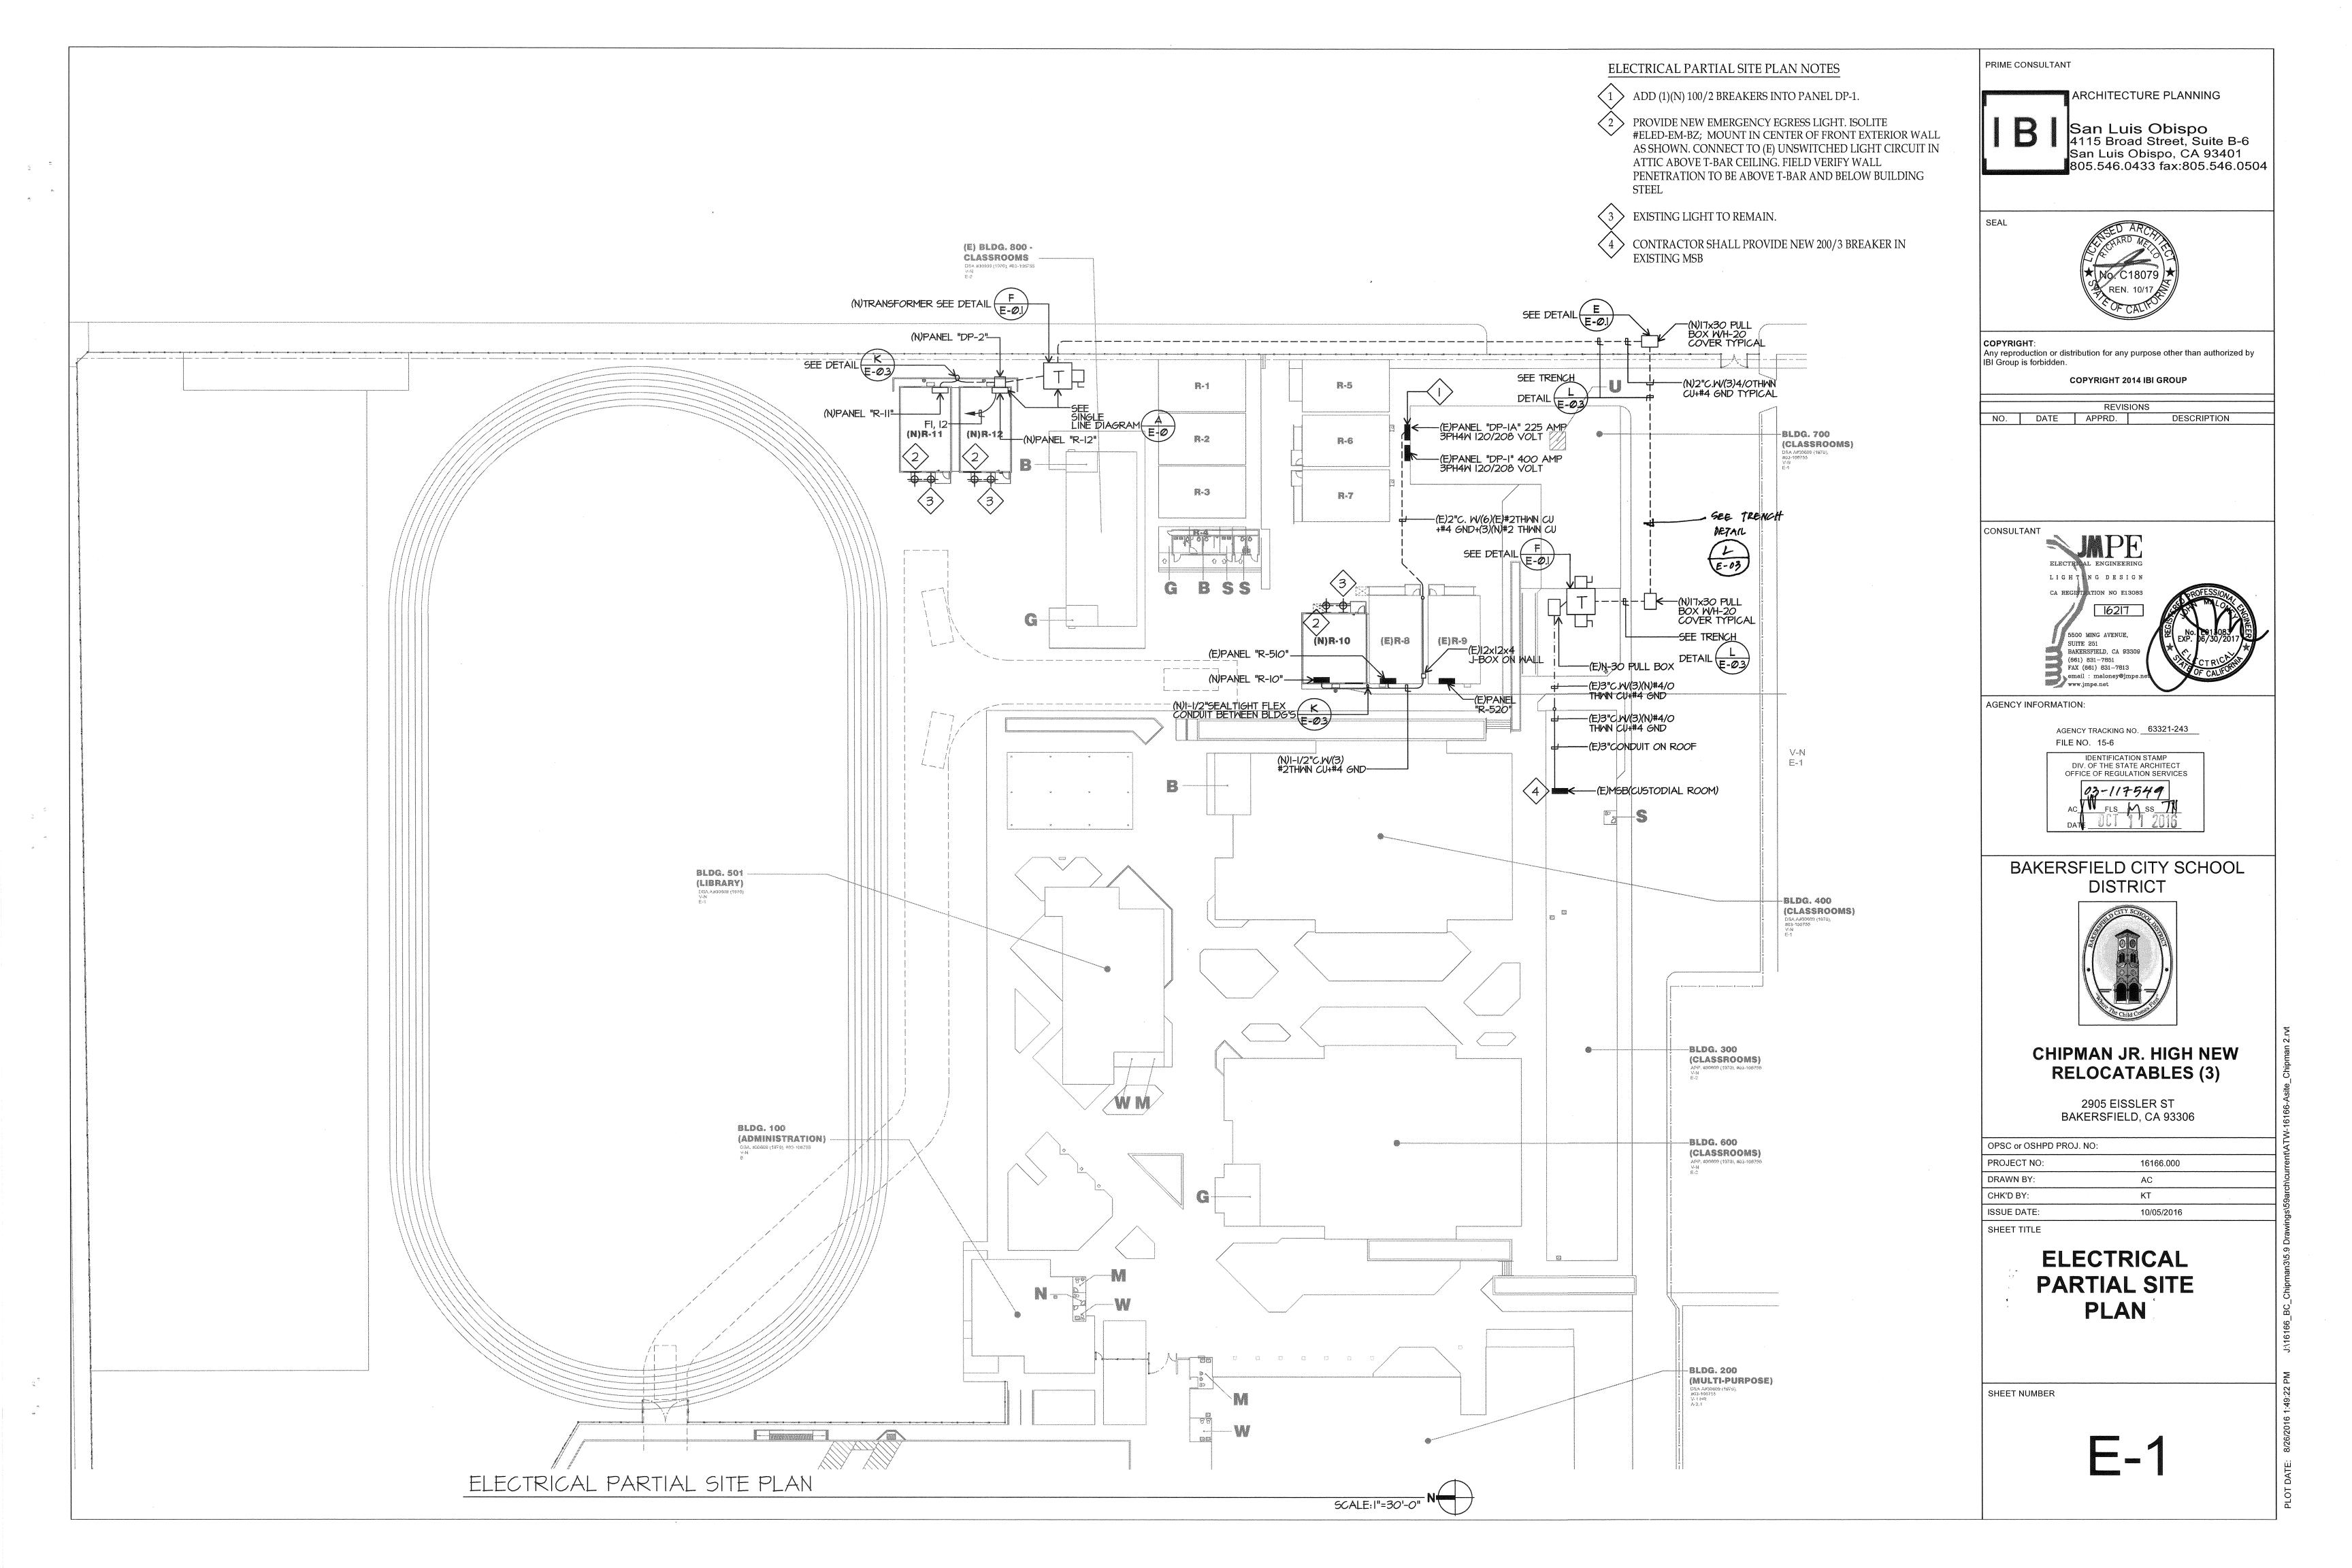
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PROJECT NO:	16166.000 `
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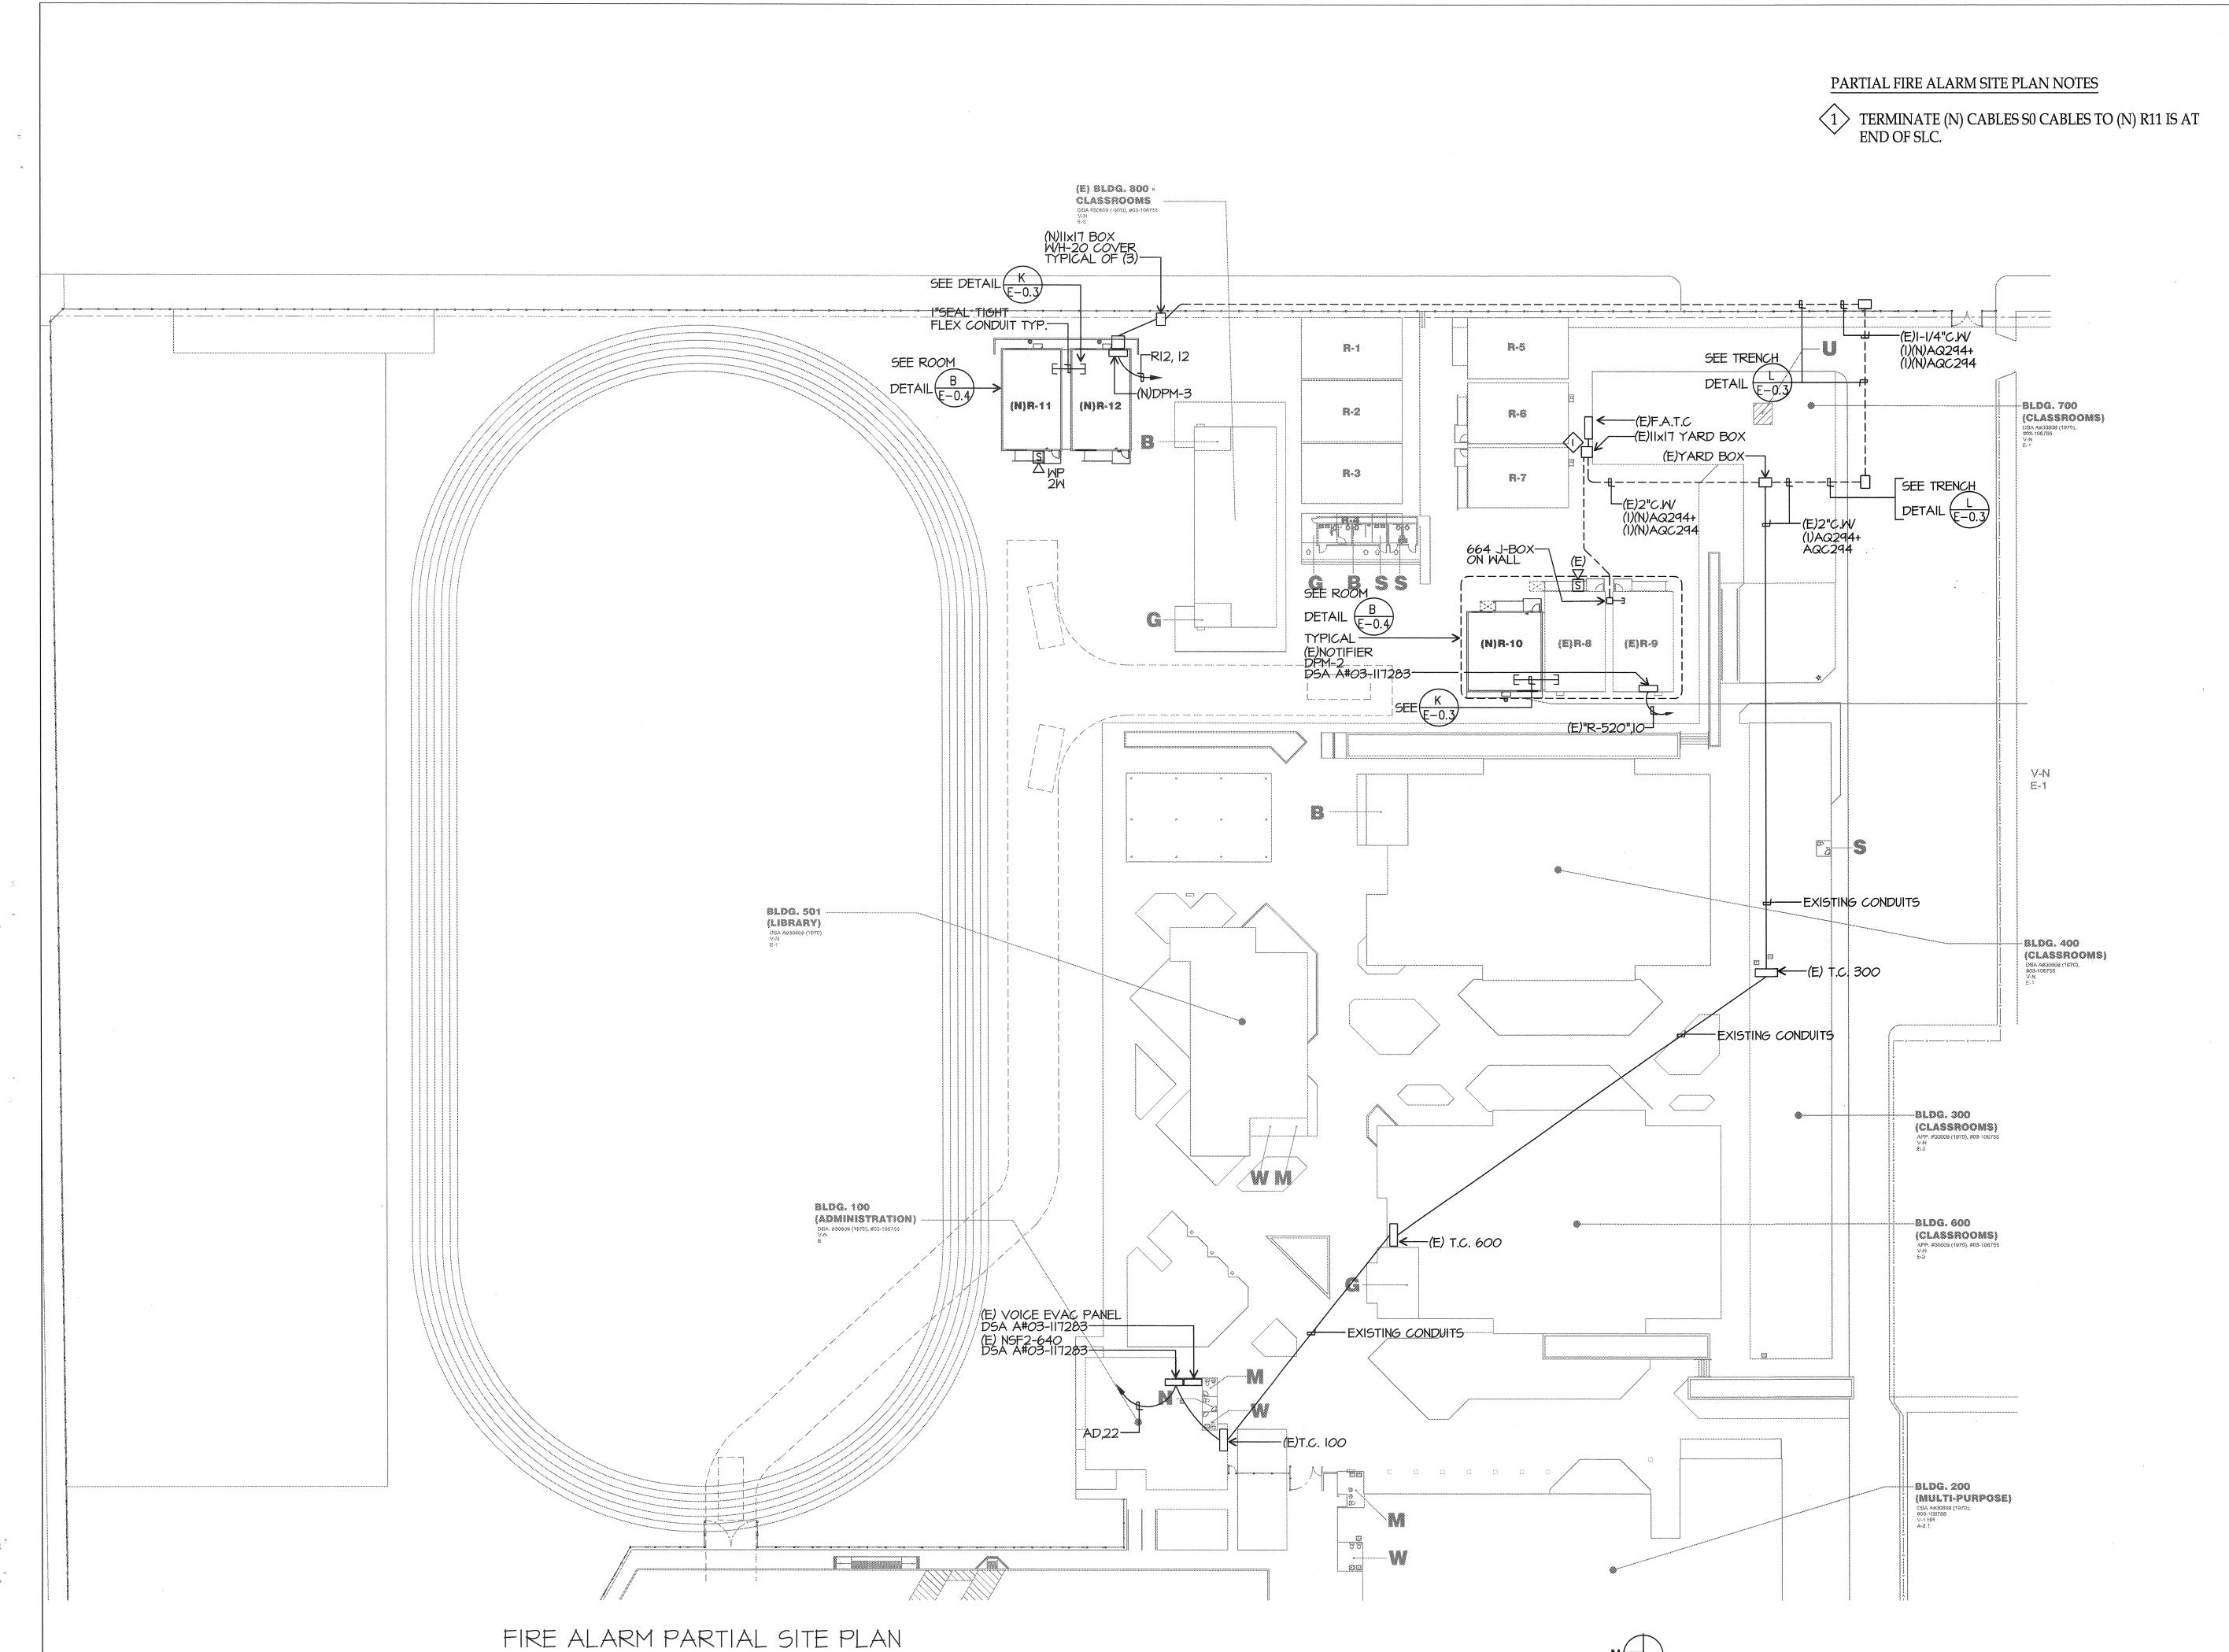
FIRE ALARM PORTABLE PLAN

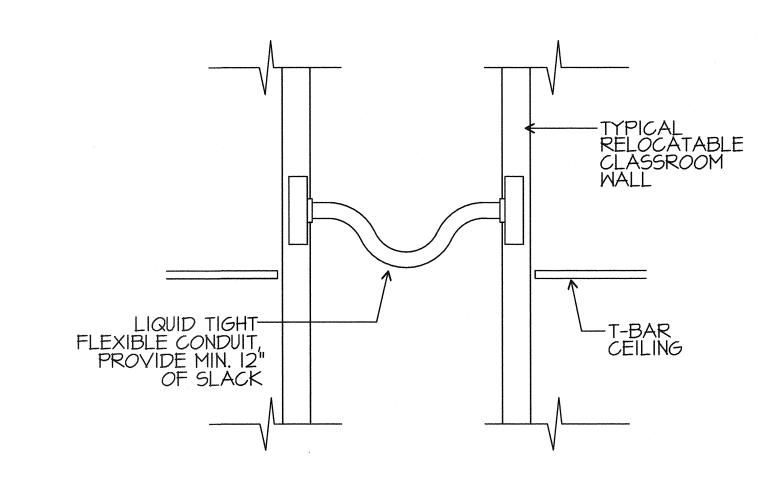SHEET NUMBER
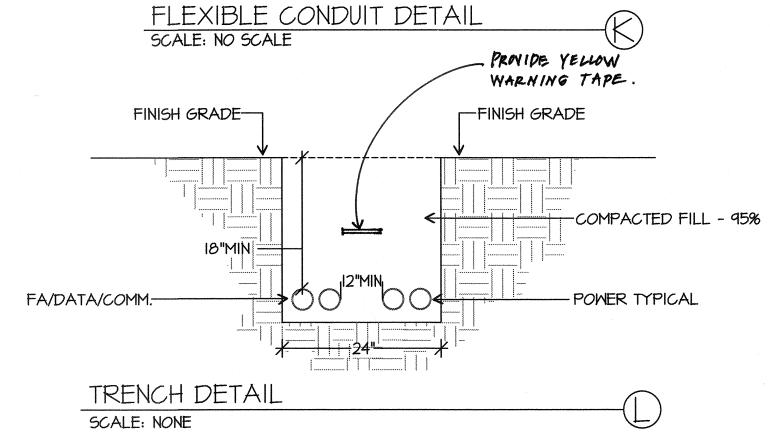
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SCALE: |"=30'-0"
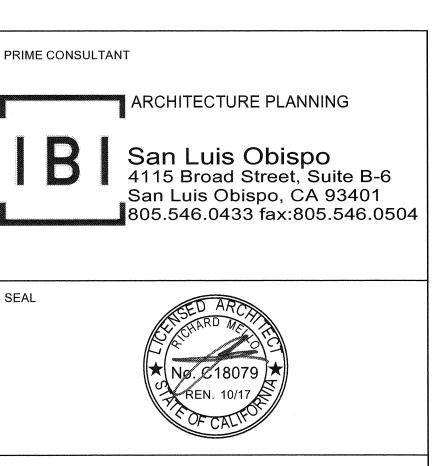
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 PROJECT NO:
 16166.000

 DRAWN BY:
 AC

 CHK'D BY:
 KT

 ISSUE DATE:
 10/05/2016

SHEET TITLE

FIRE ALARM
PARTIAL SITE
PLAN

SHEET NUMBER

E-2

PLOT DATE: 8/26/2016 1:49

