




TYPICAL SIDE WALL 14

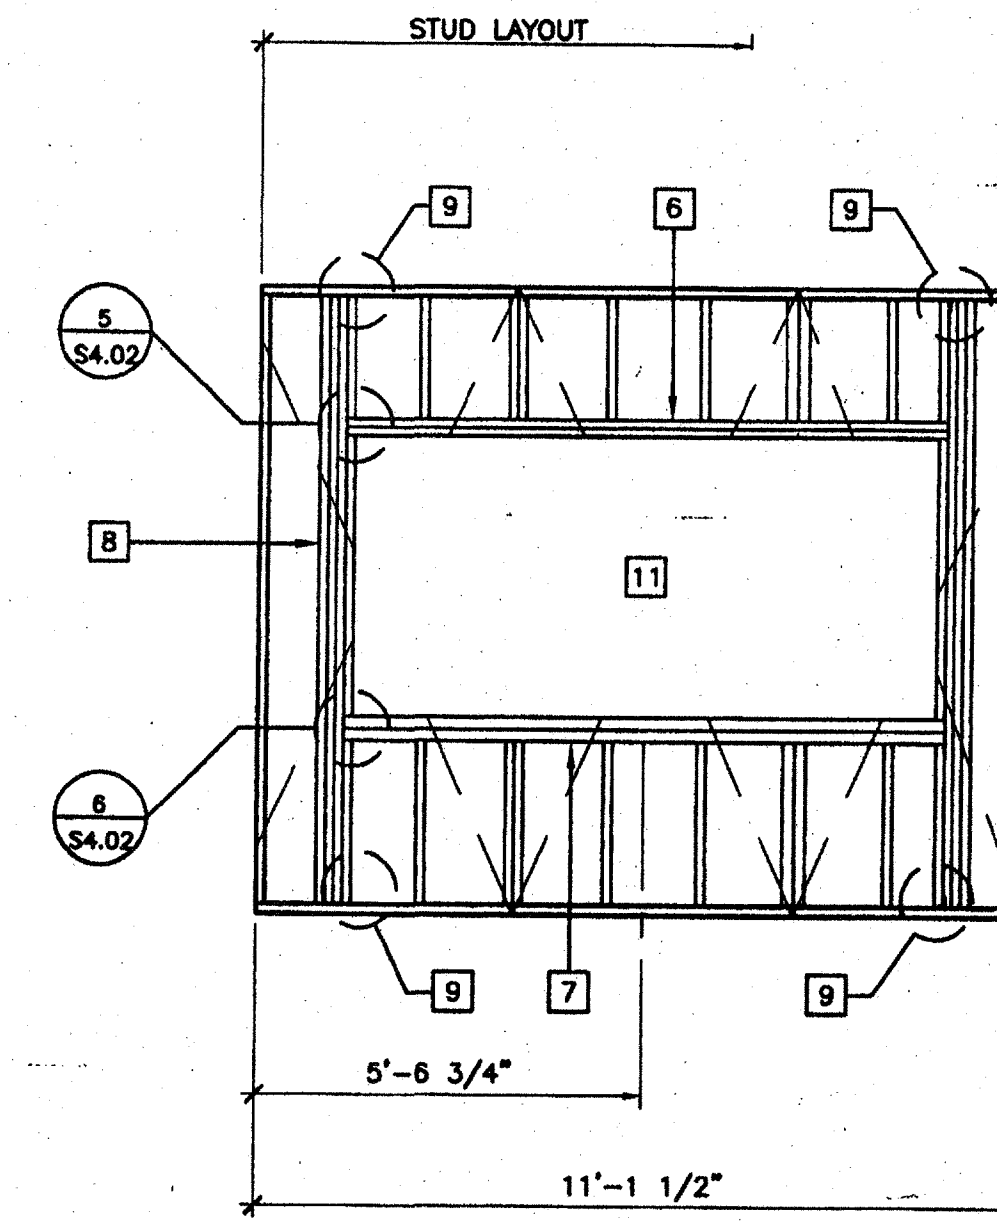


TYPICAL WINDOW

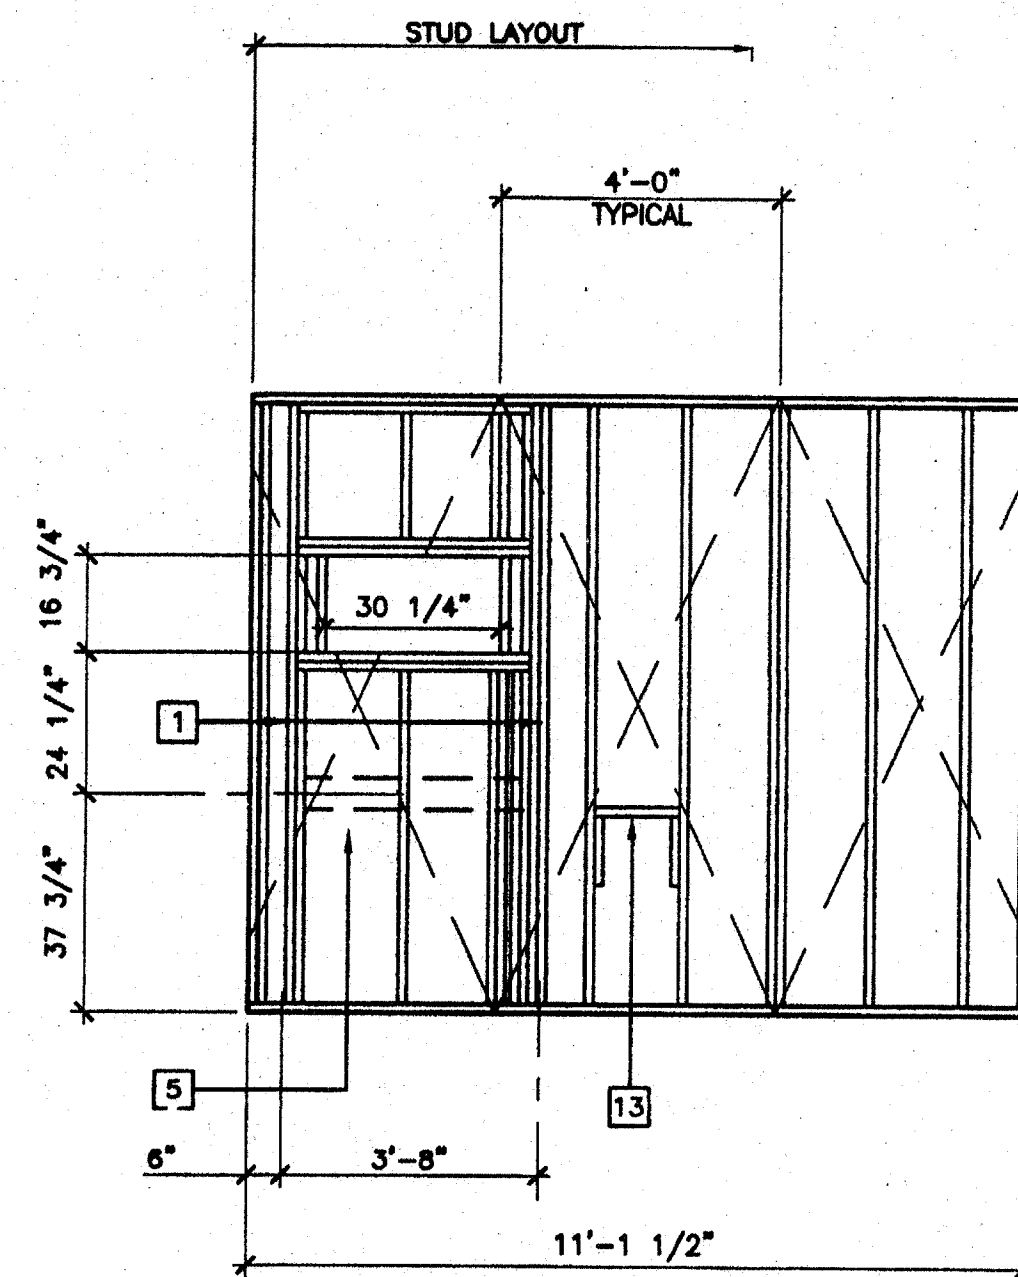

TYPICAL HVAC

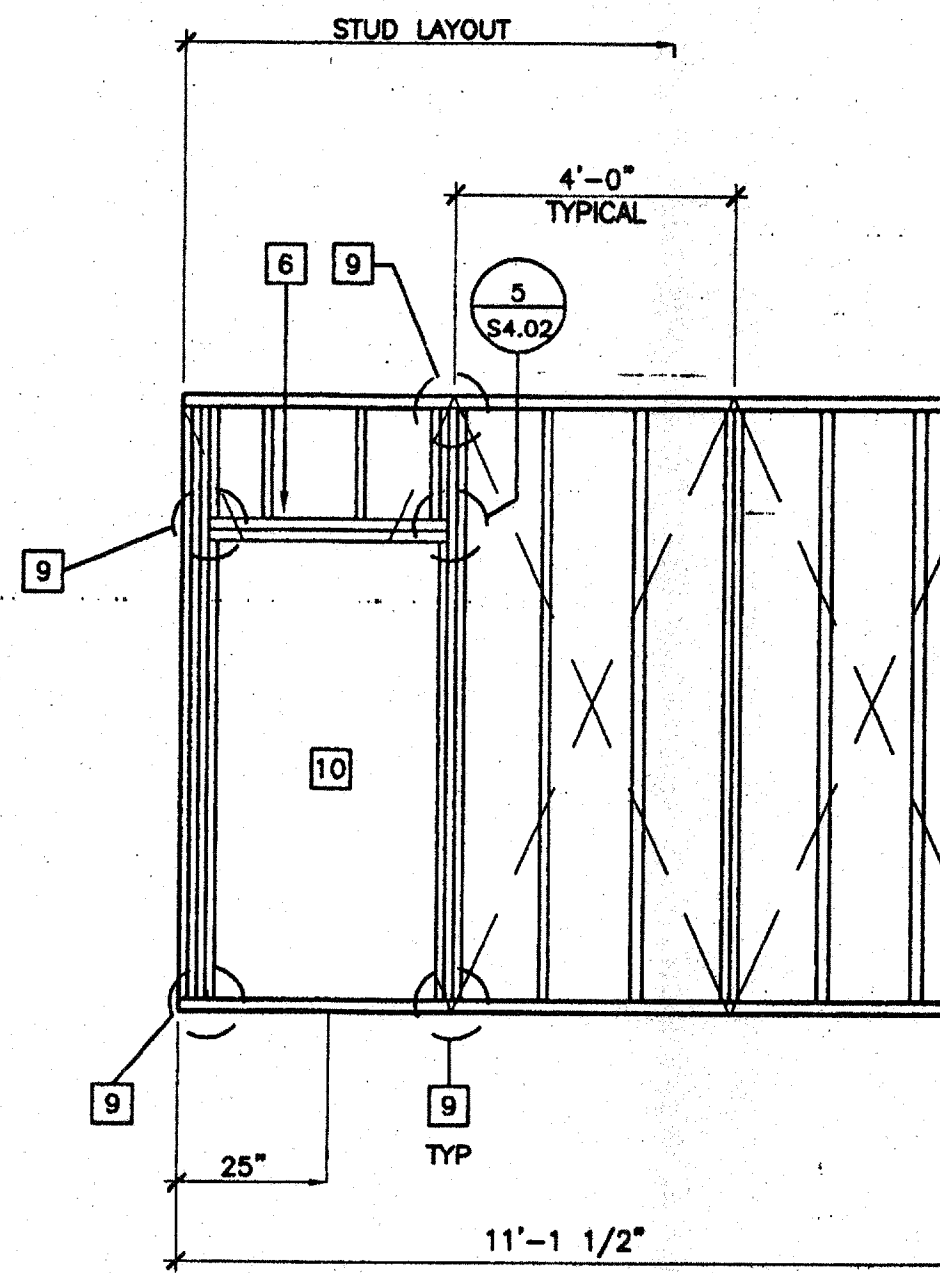

TYPICAL DOOR

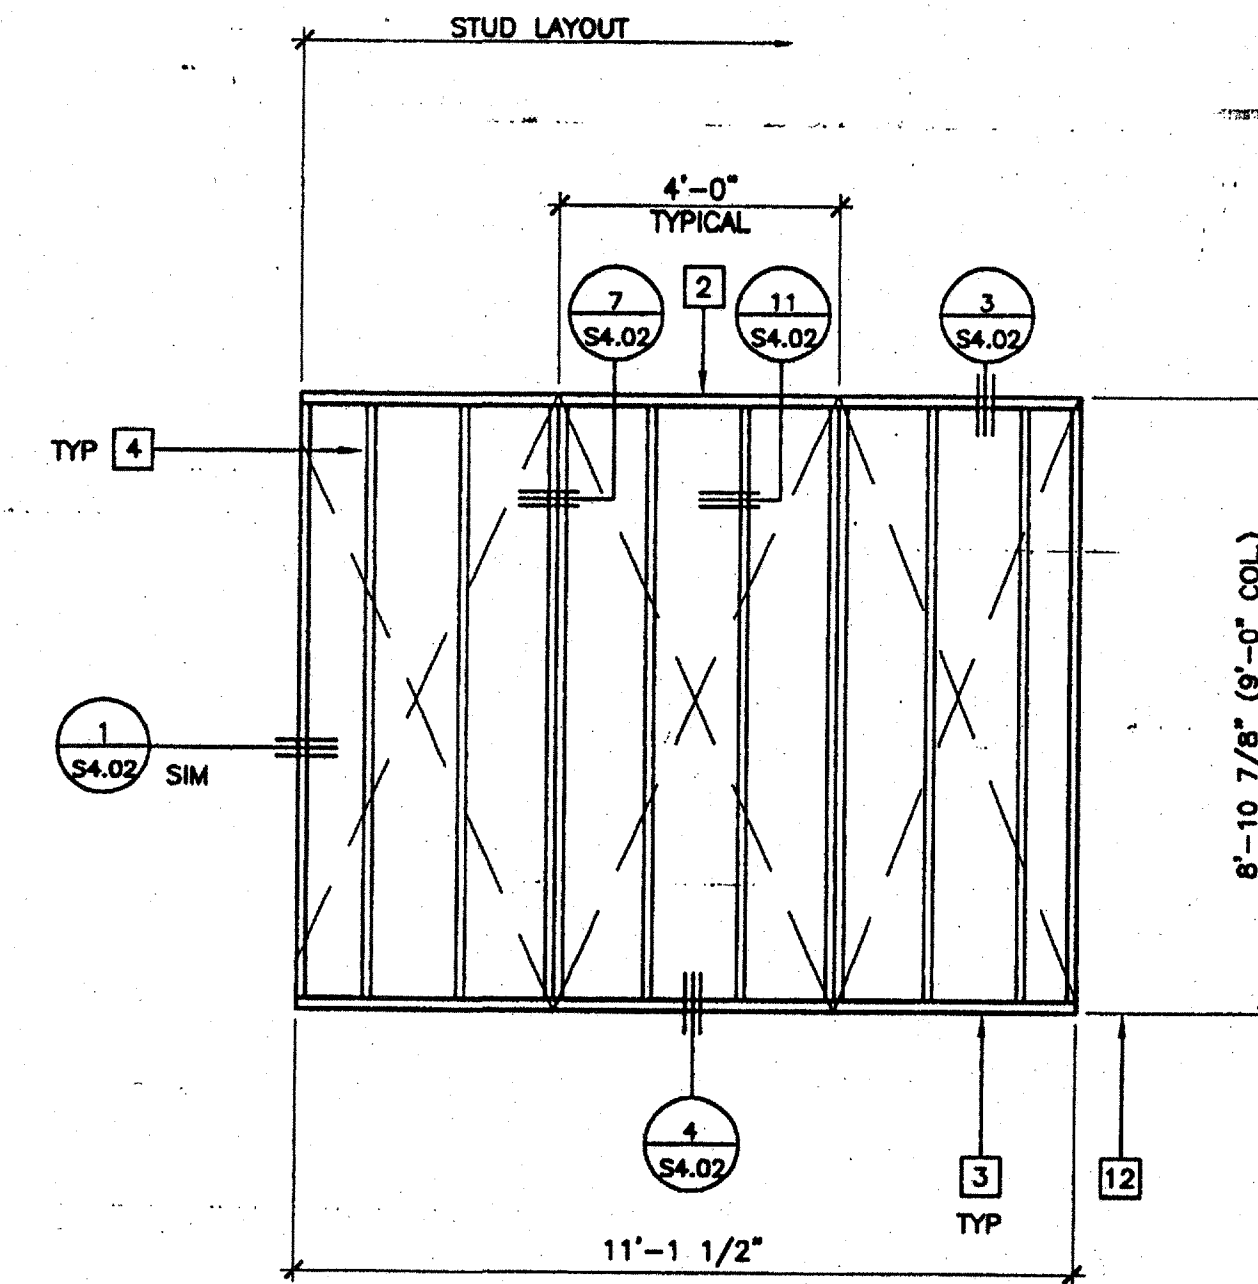

TYPICAL END WALL

KEY NOTES

- 1 4"x4" POST
- 2 2"x4" TOP PLATE
- 3 2"x4" FLOOR SILL PLATE
- 4 2"x4" STUDS AT 16" OC TYPICAL - FOR BUILDINGS EXCEEDING 2180 SF ONLY USE 12" OC SPACING WITHIN 4'-0" OF BUILDING CORNERS
- 5 2"x6" LET IN FOR AC SUPPORT
- 6 2"x4" HEADER - SEE ROUGH OPENING SCHEDULE ON SHEET S4.02
- 7 2"x4" SILL - SEE ROUGH OPENING SCHEDULE ON SHEET S4.02
- 8 2"x4" FULL HEIGHT KING STUDS AND 2"x4" TRIMMER 13/S4.02 SEE ROUGH OPENING SCHEDULE ON SHEET S4.02
- 9 A 34 CLIPS AT HEADER AND SILL TO FULL HEIGHT STUDS AND FULL HEIGHT STUDS TO TOP AND BOTTOM PLATES
- 10 REQUIRED OPENING FOR A 3068 DOOR SEE ROUGH OPENING SCHEDULE ON SHEET S4.02
- 11 REQUIRED OPENING FOR A 8040 WINDOW SEE ROUGH OPENING SCHEDULE ON SHEET S4.02
- 12 FINISH FLOOR LINE
- 13 FRAME FOR ELECTRICAL PANEL
- 14 PROVIDE 2x6 FLAT WALL BLOCKING WITH 3-16d BOX NAILS EACH END AT EACH HANDRAIL CONNECTION - 6/R1.01 SEE FLOOR PLAN FOR RAMP LOCATION.

IDENTIFICATION STAMP
 DIV. OF THE STATE ARCHITECT
 OFFICE OF REGULATION SERVICES
 04 105299
 AC [Signature]
 DATE MAY 22 2003

FOR 10'-6" COLUMN HEIGHT OPTION
 USE 6" WALL FRAMING

WALL FRAMING ELEVATIONS

WOOD STUDS
 SCALE: 1/4" = 1'-0"

REVISIONS

AGENCY TRACKING NO. 62231-247
 FILE NO. 15-6
 IDENTIFICATION STAMP
 DIV. OF THE STATE ARCHITECT
 03118235
 AC [Signature] FLS [Signature] SS [Signature]
 DATE JUL 11 2004

PC Professional of Record Seal
 ARCHITECTS SEAL
 LICENSE EXPIRES 6-30-2004

PC
 CBC 2001
 IDENTIFICATION STAMP
 DIV. OF THE STATE ARCHITECT
 OFFICE OF REGULATION SERVICES
 PC-04
 104801
 AC [Signature] FLS [Signature] SS [Signature]
 DATE 5/22/03

MODTECH™
 INC.
 2830 BARRETT AVENUE PH (909) 943-4014
 PERRIS, CALIF. 92571 FAX (909) 940-0427

PROJECT NUMBER: _____
 © MODTECH, INC. 2002
 CLASS LEASING INC STOCKPILE # 70
 100-24 x 40 CLASSROOM BUILDINGS
 4012-125 05-22-2003 80 MPH

DRAWN BY: STKP-70
 DATE: 05-22-03
 CHECKED BY: _____
 DATE: _____
 MODTECH Index No. _____
S4.01

WALL FRAMING

WOOD STUDS

FILE PATH: 2440-S4.01.DWG PROJECT NO. PC-04-104801