



bfgc architects planners inc. bakersfield 5500 ming avenue, suite 450, bakersfield ca. 93309-4631 805 836-4300 fax 805 836-4311

san luis obispo 3211 broad street suite 113 san luis obispo, california 93401 805 546-0433

san jose 160 west santa clara st. suite 525

san jose, california 95113 408 924—0841 principal architects

david r. cartnal, a.i.a., C-6564
frank a. ghezzi, a.i.a., C-3132
mark engelien, a.i.a., C-8021
willian r. tuculet, a.i.a., C-8702 dean a tatsuno, ala, C- 9190 bruce m biggar, ala, C-23134 brad a henderson ala, C-10901 richard i mello, ala, C-18079

34TH STREET COMMUNITY SCHOOL EXPANSION


222 34TH STREET BAKERSFIELD, CA

KERN COUNTY SUPERINTENDENT OF SCHOOLS

ISSUED FOR B.P. #17, #20, #24

TOPOGRAPHIC SURVEY

drawn by chk'd by copyright

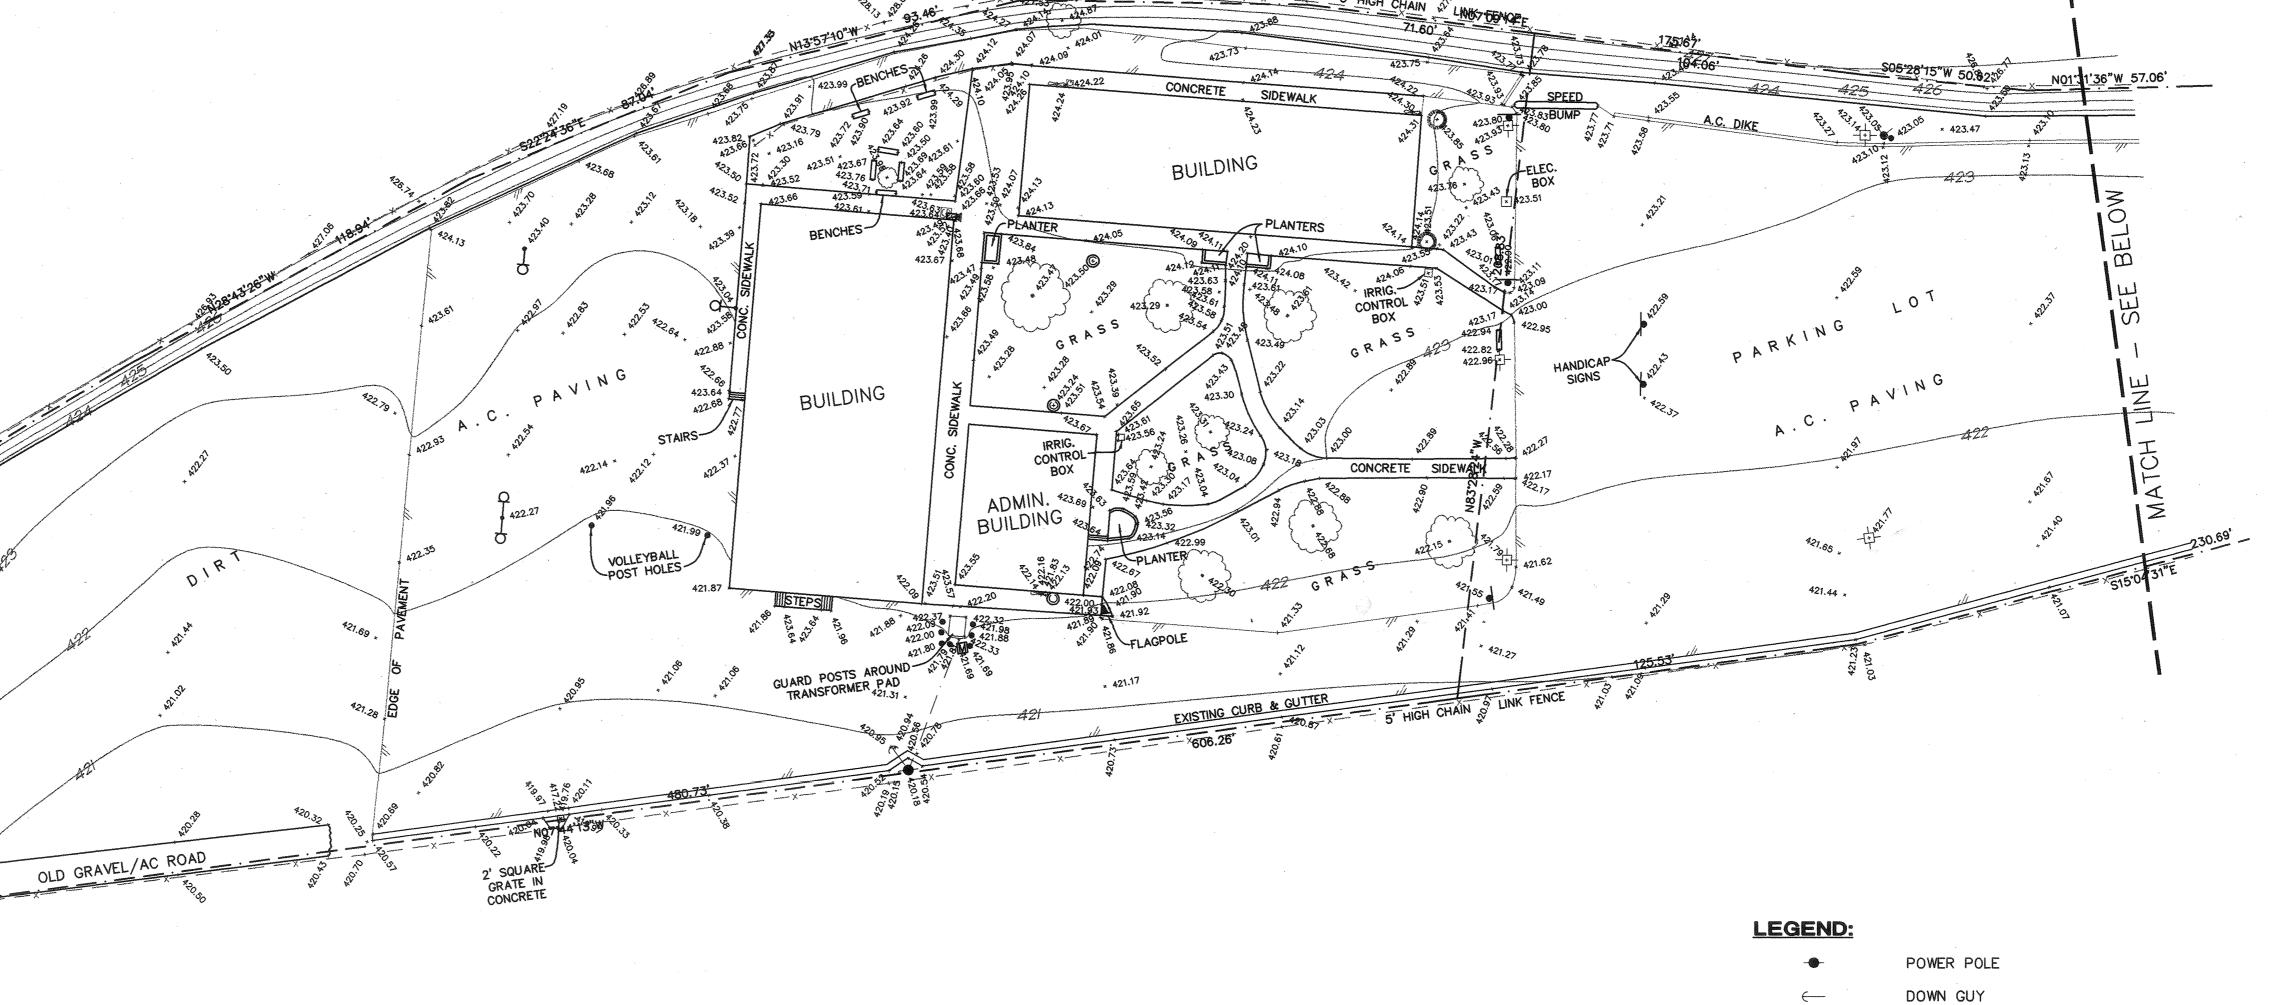

BENCH MARK:

CHISELED "" ON THE TOP OF CURB LOCATED 5' SOUTH OF THE SOUTHWEST PROPERTY CORNER. ELEVATION = 423.51' (CITY DATUM)

BASIS OF BEARINGS:

THE BEARING OF S.89°43'40"E. AS SHOWN AS THE CENTERLINE OF 34TH STREET IN SECTION 19, T.29S., R.29S., M.D.M. RECORDED IN DEED BOOK 4116 AT PAGE 314 IN THE OFFICE OF THE KERN COUNTY RECORDER WAS USED AS THE BASIS OF BEARINGS SHOWN HEREON.

SURVEYOR'S STATEMENT:


THIS MAP CORRECTLY REPRESENTS A SURVEY MAD BY ME OR UNDER MY DIRECTION IN CONFORMANCE WITH THE REQUIREMENTS OF THE LAND SURVEYOR'S ACT AT THE REQUEST OF COMMUNITY LEARNING CENTER IN MAY, 1997.

ROGER A. McINTOSH L.S. 4383

NOTE:

NOT ALL UNDERGROUND UTILITIES OR FACILITIES WERE LOCATED BY THIS SURVEY AND THE SURVEYOR ASSUMES NO RESPONSIBILITY FOR UNDERGROUND UTILITIES NOT SHOWN OR FOR INFORMATION OBTAINED FROM OUTSIDE SOURCES.

THE SURVEYOR ASSUMES NO RESPONSIBILITY FOR EASEMENTS, RIGHT OF WAYS, PROPERTY LINES OR ANY OTHER INFORMATION PERTAINING TO RECORD TITLE INTEREST DUE TO THE FACT NO TITLE REPORT WAS PROVIDED FOR THIS SURVEY.

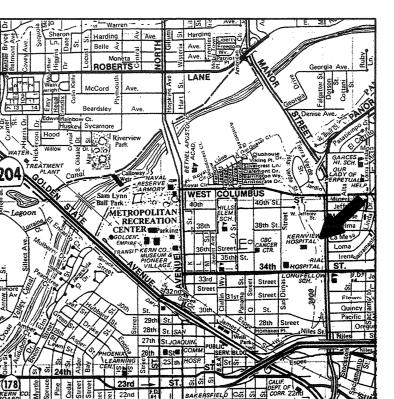

LIGHT STANDARD

WATER VALVE

FIRE HYDRANT

WATER SPIGOT

SEWER MANHOLE

SEWER CLEANOUT

BASKETBALL HOOP

TREE

CYPRESS


GAS METER

GUARD POST

MAILBOX

EDGE OF PAVEMENT

VICINITY MAP

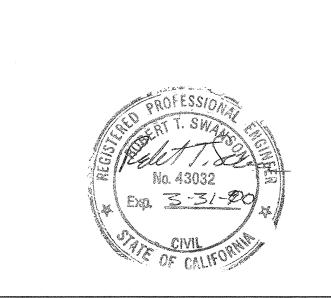

Martin ~ McIntosh

ENGINEERING & SURVEYING
2001 Wheelan Court

Bakersfield, California 93309
(805) 834-4814 bfgc architects planners inc.

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160 west santa clara st. suite 525 san jose, california 95113 408 924–0841

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dean a tatsuno, a.i.a., bruce m. biggar, a.i.a., brad a. henderson, a.i.a., richard l. nello, a.i.a.,

34TH STREET COMMUNITY SCHOOL EXPANSION


222 34TH STREET BAKERSFIELD, CA

KERN COUNTY SUPERINTENDENT OF SCHOOLS


ISSUED FOR B.P. #17, #20, #24

GRADING PLAN SOUTH HALF


job no.	97-120	
date	5/16/97	
drawn by	RTS	
chk'd by	^	V
copyright	1997	

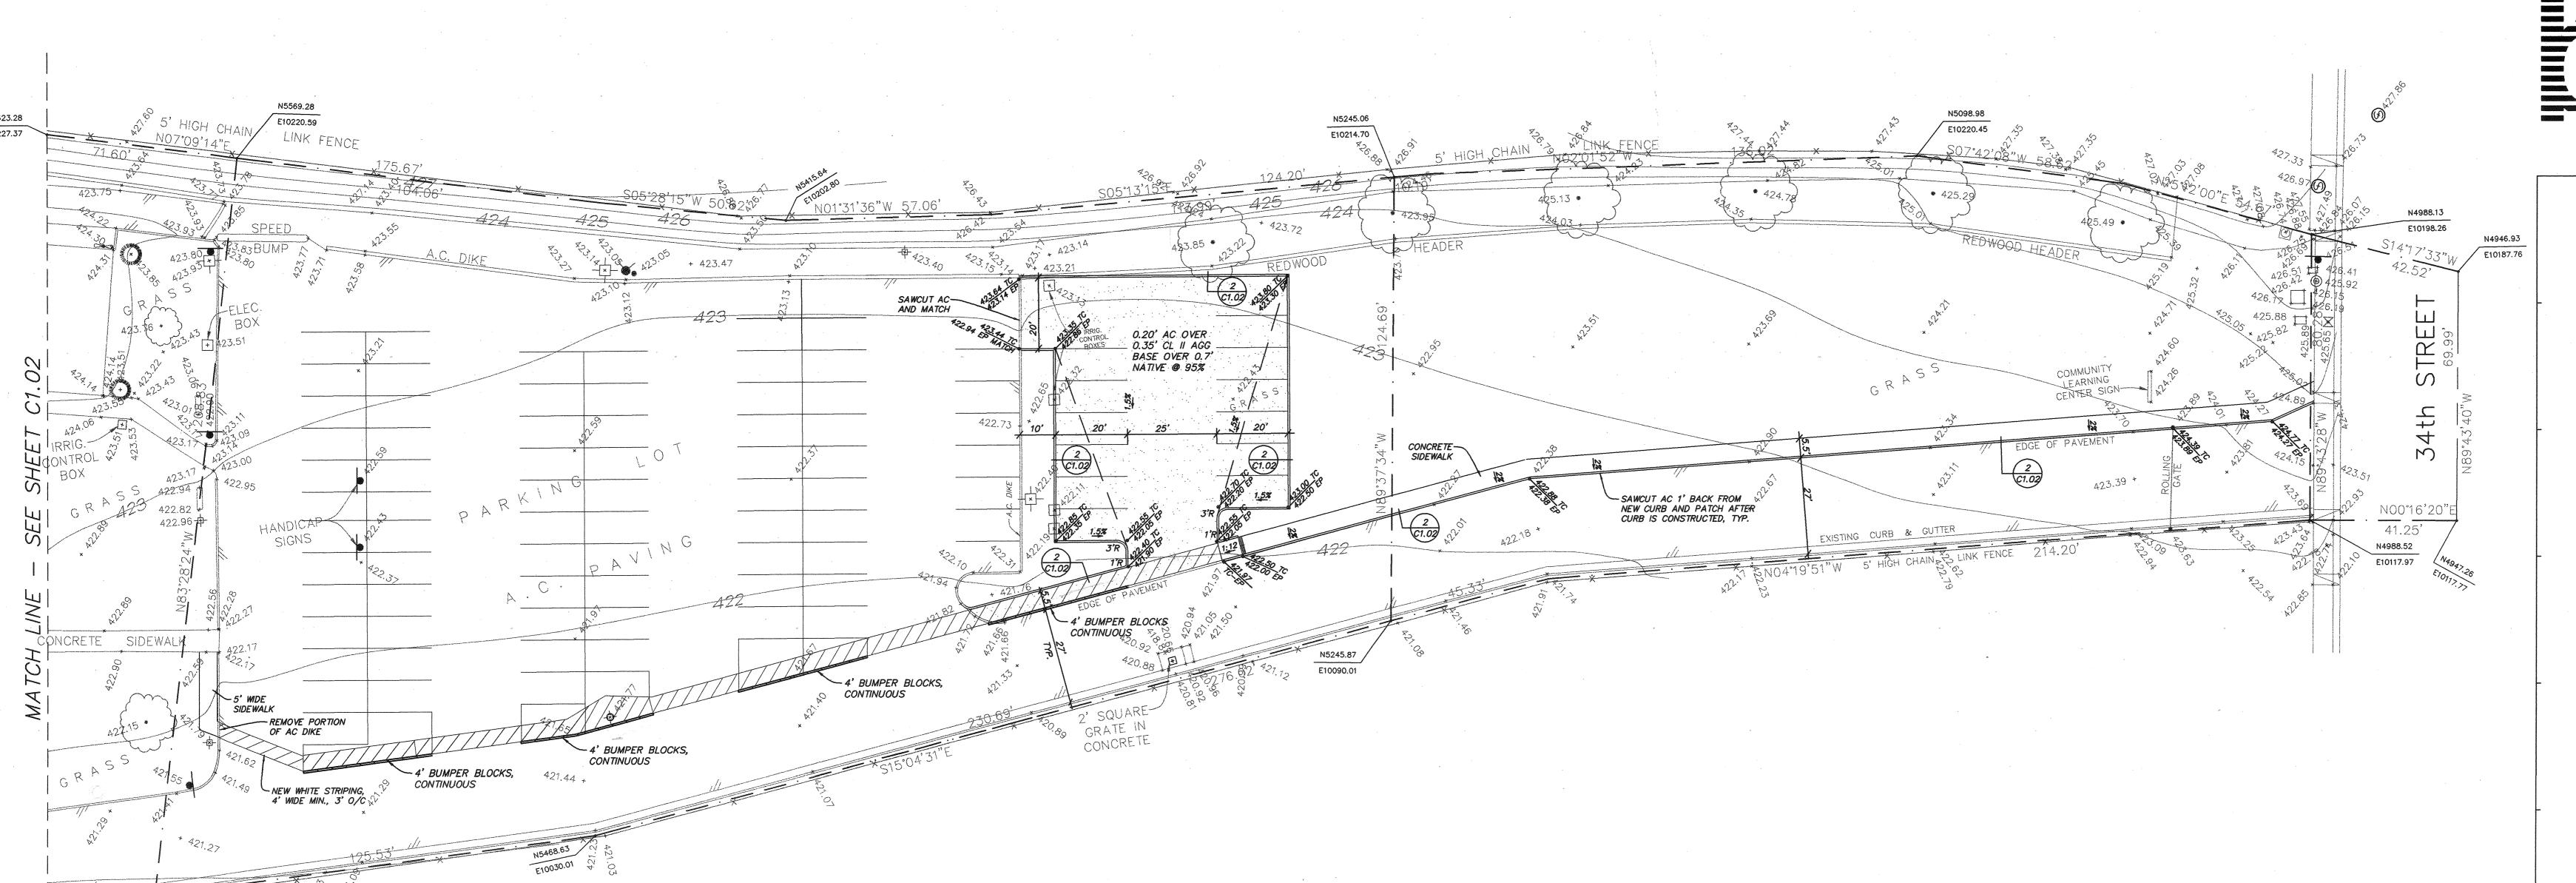

CHISELED "" ON THE TOP OF CURB LOCATED 5' SOUTH OF THE SOUTHWEST PROPERTY CORNER. ELEVATION = 423.51' (CITY DATUM)

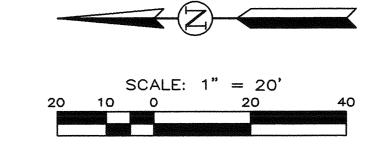



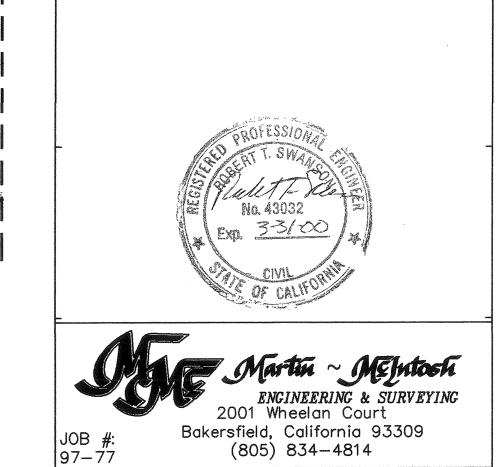

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, C-6564 dean a tatsuno, a.i.a., , C-3132 bruce m. biggar, a.i.a., C-8021 brad a. henderson, a.i.a., a., C-8702 richard l. mello, a.i.a.,





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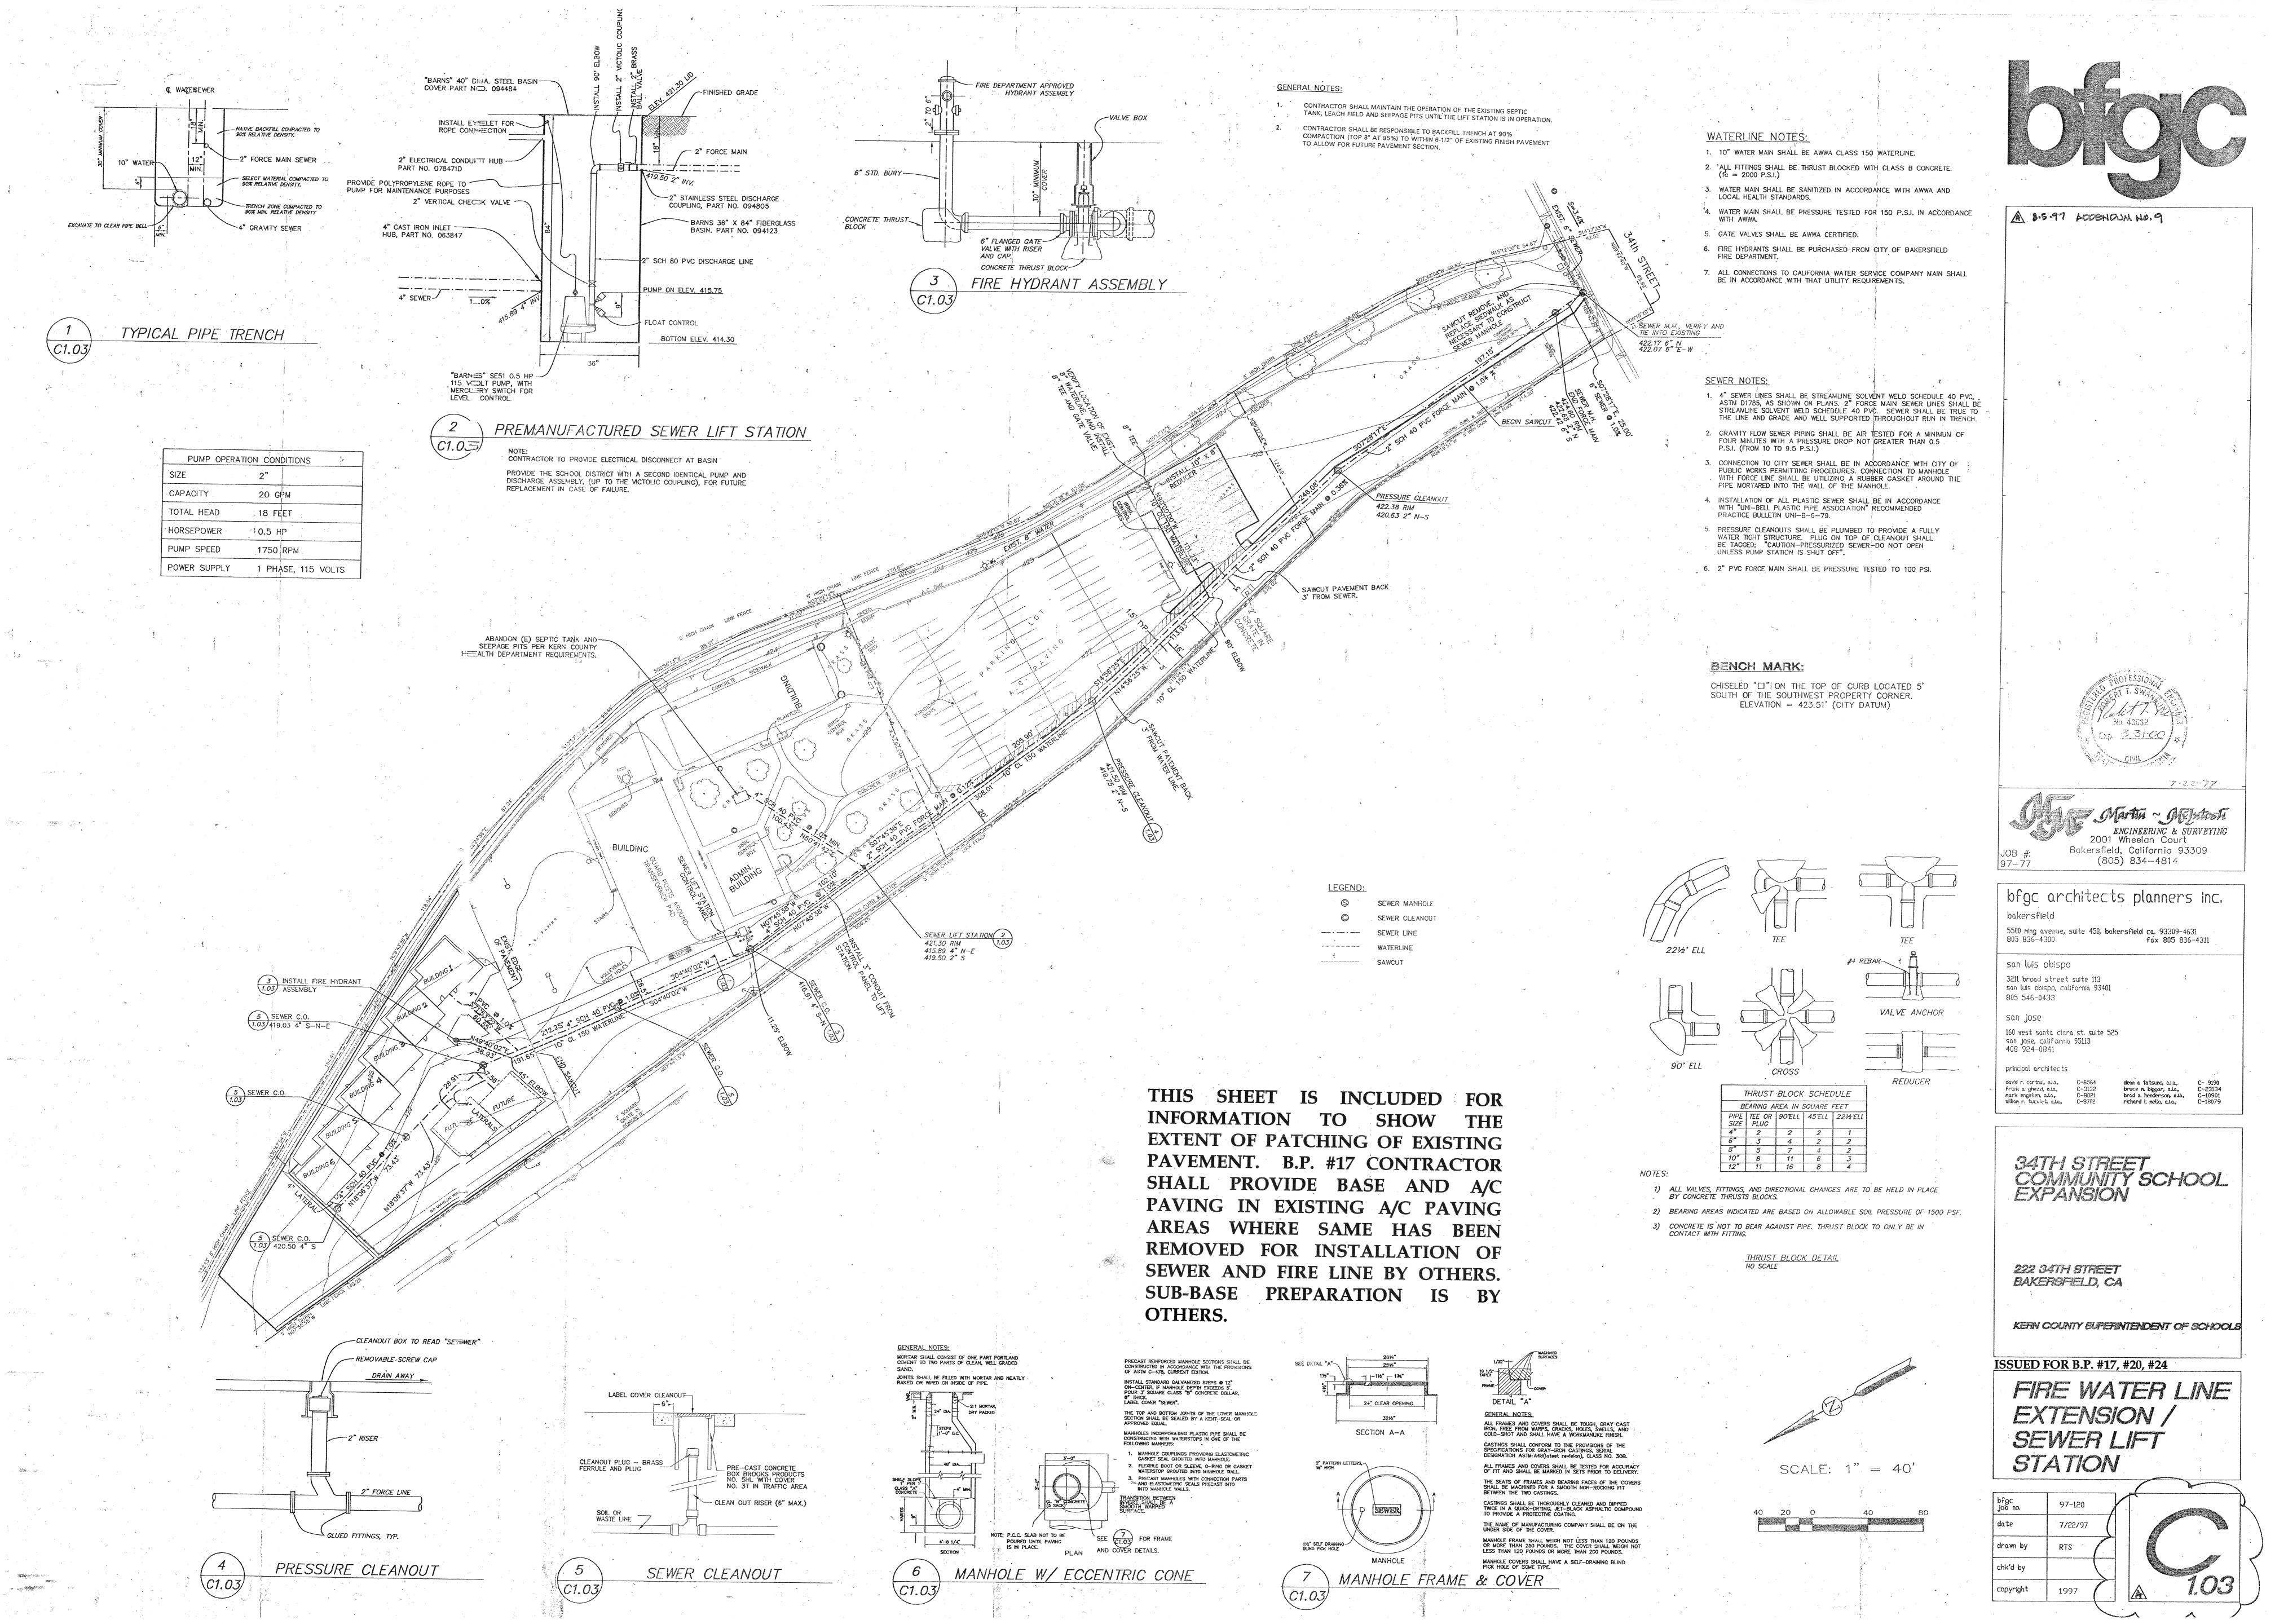
KERN COUNTY SUPERINTENDENT OF SCHOOLS


ISSUED FOR B.P. #17, #20, #24

GRADING PLAN NORTH HALF



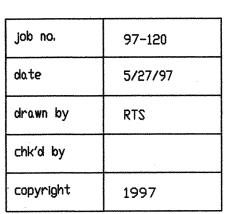

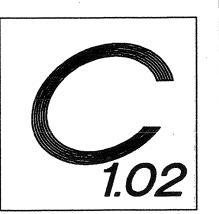

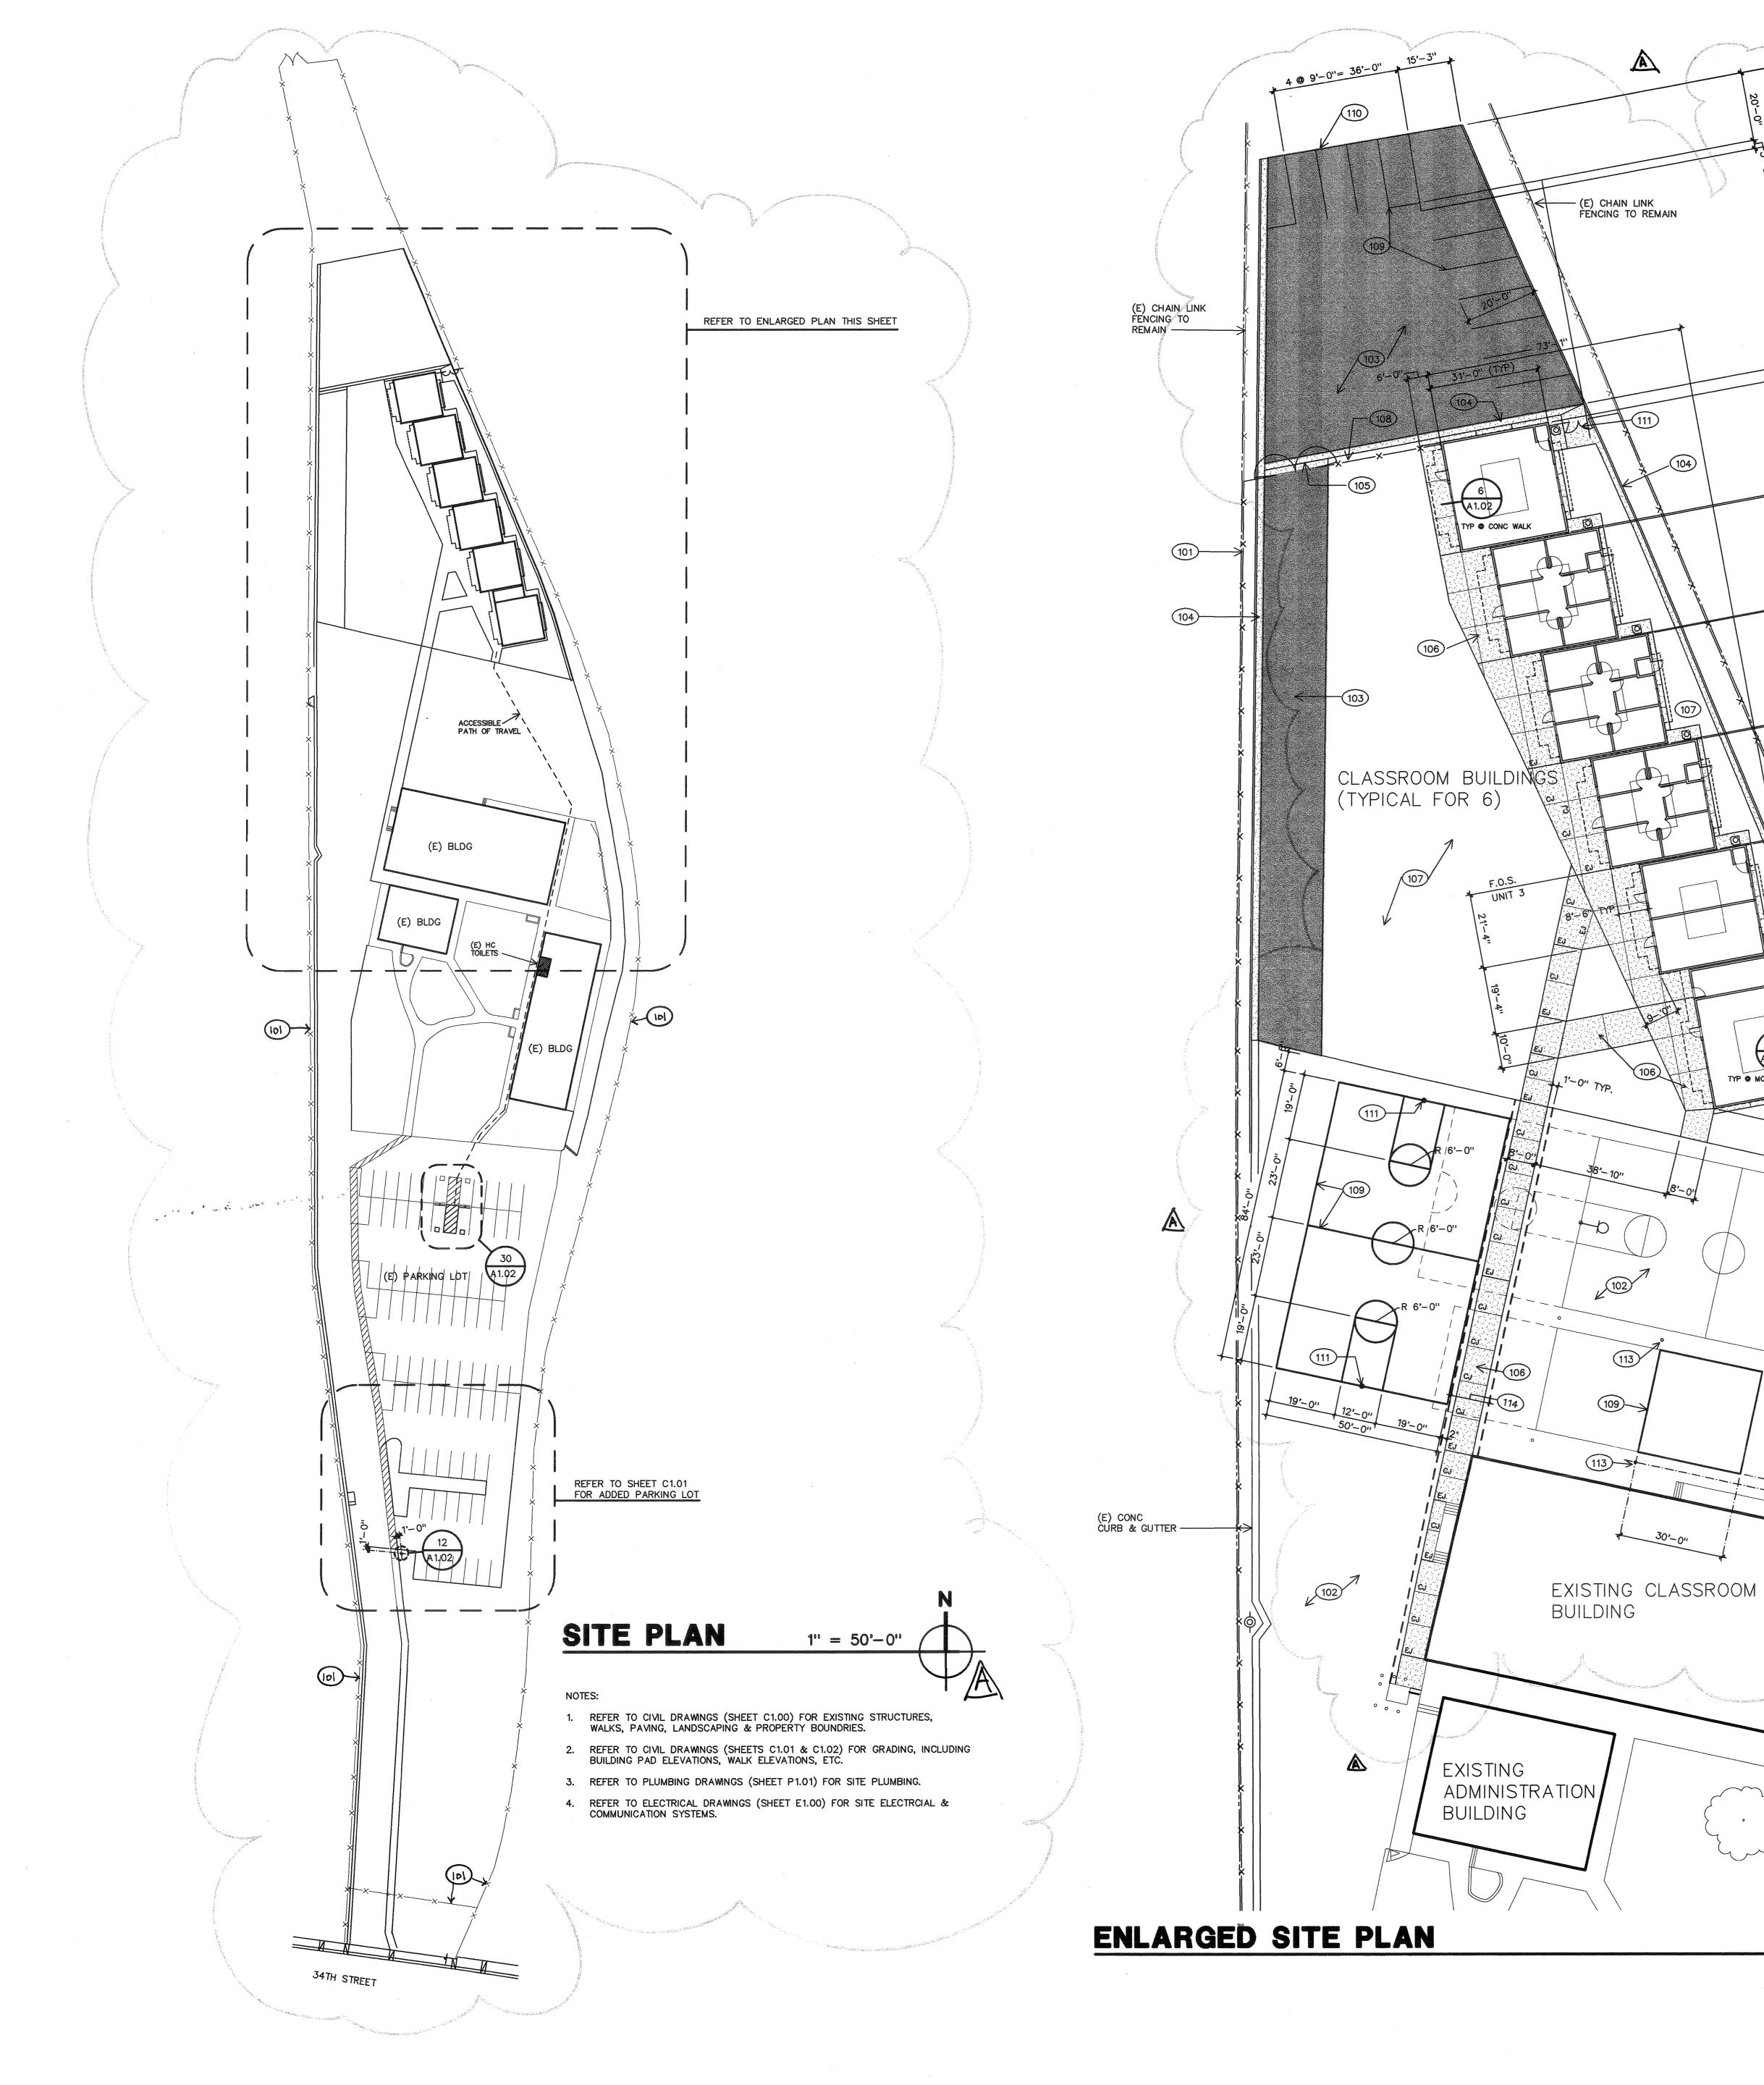



KEYNOTES

REMOVE & REPLACE (E) CHAIN LINK FENCING (6'-0" HIGH)

102 (E) AC PAVING TO REMAIN

103 AC PAVING (SEE C1.03 FOR PAVING SECTION) 104 CONCRETE CURB/GUTTER (SEE DETAIL 1/C1.02)

105 CONCRETE 'V' GUTTER (SEE DETAIL 3/C1.02) 106 CONCRETE SIDEWALK (SEE DETAIL 11/A1.02)

107 FUTURE LANDSCAPE AREA 108 CHAIN LINK FENCING (6'-0" HIGH W/

12'-0" PR GATE)

109 PAINTED WHITE LINES (2" WIDE) - 110 REDWOOD HEADER (SEE DETAIL 4/C1.02)

111 CHAIN LINK FENCING (6'-0" HIGH W/

6'-0" PR GATE) - 112 SLEEVE FOR BASKETBALL (4-1/2" O.D. POST)

113 SLEEVE FOR VOLLEYBALL (2-7/8" O.D. POST) 114 REMOVE (E) AC PAVING. PATCH & REPAIR

AFTER INSTALLATION OF CONC. WALK

A 7-14-97 LOOENOUM NO.4

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805 546-0433

101

1'' = 20' - 0''

160 west santa clara st. suite 525 san jose, california 95113 408 924–0841

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34TH STREET COMMUNITY SCHOOL **EXPANSION**


222 34TH STREET BAKERSFIELD, CA

KERN COUNTY SUPERINTENDENT OF SCHOOLS


ISSUED FOR B.P. #17, #20, #24

SITE PLAN

job no.	97-120
date	05-28-97
drawn by	R. TROST
chk'd by	R. TROST
convelabt	4007

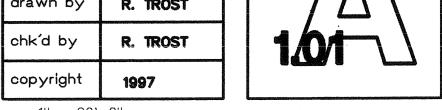

1" = 20'-0"
PLOT DATE: 7-16-97
PATH\NAME: \DRAWING\97-120\7120S101.dc5

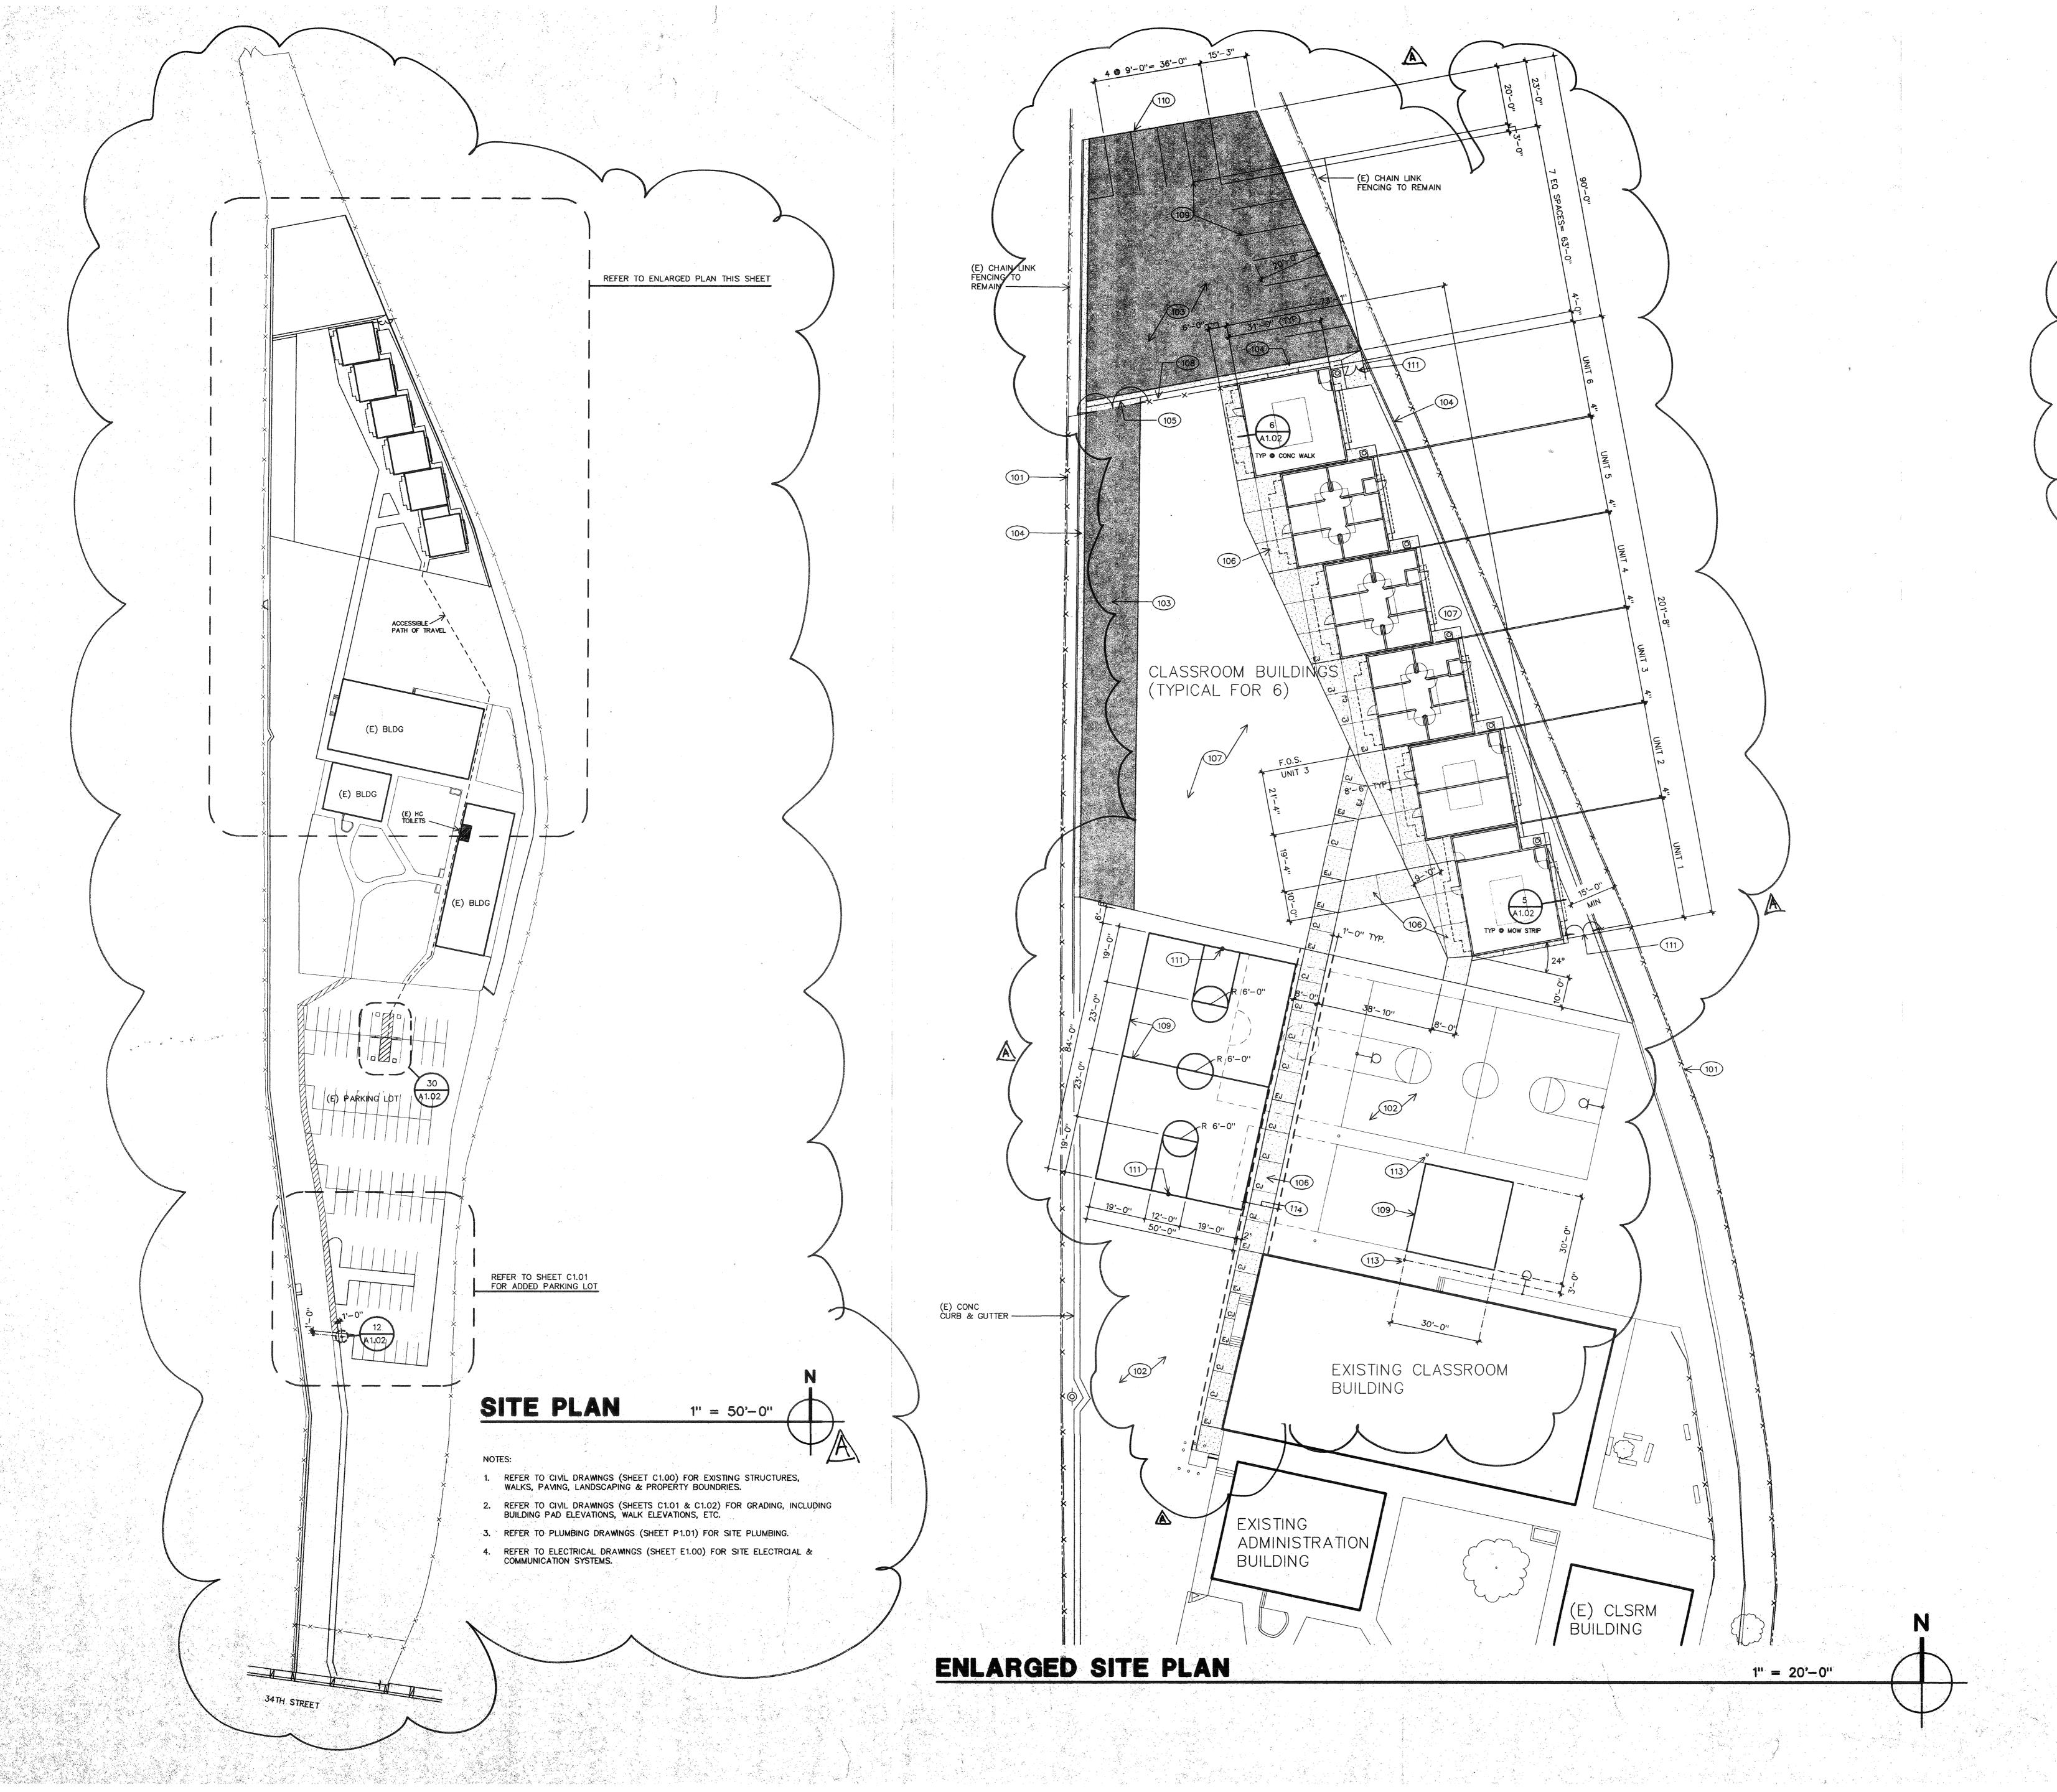



KEYNOTES

REMOVE & REPLACE (E) CHAIN LINK

FENCING (6'-0" HIGH)

102 (E) AC PAVING TO REMAIN 103 AC PAVING (SEE C1.03 FOR PAVING SECTION) CONCRETE CURB/GUTTER (SEE DETAIL 1/C1.02)

105 CONCRETE 'V' GUTTER (SEE DETAIL 3/C1.02) 106 CONCRETE SIDEWALK (SEE DETAIL 11/A1.02) 107 FUTURE LANDSCAPE AREA

108 CHAIN LINK FENCING (6'-0" HIGH W/ 12'-0" PR GATE)

109 PAINTED WHITE LINES (2" WIDE) - 110 REDWOOD HEADER (SEE DETAIL 4/C1.02)

111 CHAIN LINK FENCING (6'-0" HIGH W/ 6'-0" PR GATE)

112 SLEEVE FOR BASKETBALL (4-1/2" O.D. POST) 113 SLEEVE FOR VOLLEYBALL (2-7/8" O.D. POST)

114 REMOVE (E) AC PAVING. PATCH & REPAIR AFTER INSTALLATION OF CONC. WALK

A 7.14.97 ADDENOUM NO. 6

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34TH STREET COMMUNITY SCHOOL **EXPANSION**

222 34TH STREET BAKERSFIELD, CA


KERN COUNTY SUPERINTENDENT OF SCHOOLS

ISSUED FOR B.P. #17, #20, #24

SITE PLAN


		10 June 1	
	Job no.	97 120	
,	date	05-28-	-97
	drawn by	R. TRO	ST
	chk'd by	R. TRO	ST


copyright

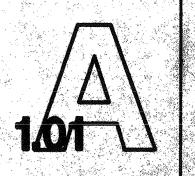

1" = 20'-0" PLOT DATE: 7-16-97 PATH\NAME: \DRAWING\97-120\7120S101.dc5

PERFORMANCE CERTIFICATE OF COMPLIANCE (part 1 of 3) PERF-1 page 3 of 17 Run Initiation Time: 13:52:18 Runcode: 2975-582381184 Project Name: KCSS - 34th St. Community School Expansn Date: 5/22/1997 Address: 222 34th Street	CERTIFICATE OF COMPLIANCE - Lighting LTG-1 page 7 of 17 Run Initiation Time: 13:52:18 Runcode: 2975-582381184 Project Name: KCSS - 34th St. Community School Expansn Date: 5/22/1997
Bakersfield, California Designer: BFGC Architect Planners, Inc. Checked by / Date	Documentation: LAWRENCE-NYE-BECKER ASSOC COMPLY 24 User 2975
DOCUMENTATION: LAWRENCE-NYE-BECKER ASSOC COMPLY 24 User 2975 STATEMENT OF COMPLIANCE This Certificate of Compliance lists the Building features and performance specifications needed to comply with Title 24, Parts 1 and 6, of the State Building Code. This certificate applies only to a Building using the	Name Lamp Type Lamps Lamp Type Luminaire Fixt. Field A Fluorescent 3 32 Electronic 1.0 79 B Fluorescent 8 32 Electronic 1.0 4 D Fluorescent 3 17 Electronic 1.0 10
performance compliance approach. The Principal Designers hereby certify that the proposed building design represented in the construction documents and modelled for this permit application are consistent with all other forms and worksheets, specifications, and other calculations submitted with this permit application. The proposed building as designed meets the energy efficiency requirements	MANDATORY AUTOMATIC CONTROLS Control Control Location ID Control Type Zone Controlled Field
of the State Building Code, Title 24, Part 6, Chapter 1. 1. I hereby affirm that I am eligible under the provisions of Division 3 of the Business and Professions Code to sign this document as the person responsible for its preparation; and that I am licensed as a civil engineer, mechanical engineer, electrical engineer or architect.	CONTROLS FOR CREDIT
2. I affirm that I am eligible under the exemption to Division 3 of the Business and Professions Code by Section 5537.2 of the Business and Professions Code to sign this document as the person responsible for its preparation; and that I am a licensed contractor preparing documents for work that I have contracted to perform.	Control Control Type Zone Controlled Field
3. I affirm that I am eligible under the exemption to Division 3 of the Business and Professions Code by Section of the Code to sign this document as the person responsible for its preparation; and for the following reason:	Project Name: KCSS - 34th St. Community School Expansn Date: 5/22/1997 Documentation: LAWRENCE-NYE-BECKER ASSOC COMPLY 24 User 2975
SCOPE OF COMPLIANCE (Designers should circle applicable paragraph numbers) ENVELOPE - Required Forms: ENV-1, ENV-2	CVCTEM FFATURES Note to
Principal Designer BFGC Architect Planners, Inc. Location of Mandatory Measures on Plans (Signature) (Date) (Circle)	Zone Name F-1, CU-1 Time Control Setback Control Both
Principal Designer Interstate Engineering (209) 432-4490 Required Forms: LTG-1, LTG-2 Location of Mandatory Measures in Plans (Signature) (Date) (Circle)	#of Isolation Zones n/a HP Thermostat n/a Electric Heat n/a Fan Control Constant Volume VAV Min Position n/a Simul. Heat/Cool n/a
MECHANICAL - Required Forms: MECH-1, MECH-2, MECH-3, MECH-4 Location of Mandator Measures in Plans Principal Designer Lawrence-Nye-Becker Associates 1 2 3	Heat Supply Reset Constant Temp Cool Supply Reset Constant Temp Ventilation OA Damper Control Economizer Type No Economizer
PERFORMANCE CERTIFICATE OF COMPLIANCE (part 2 of 3) PERF-1 page 4 of 17 Run Initiation Time: 13:52:18 Runcode: 2975-582381184 Project Name: KCSS - 34th St. Community School Expansn Date: 5/22/1997	Outdoor Air CFM 1901 Heat Equip Type Gas Furnace Make & Model No. Carrier 58 WAV 091-16 Cool Equip Type DX Make and Model Carrier 38 TRA 048
Documentation: LAWRENCE-NYE-BECKER ASSOC COMPLY 24 User 2975	
ANNUAL SOURCE ENERGY USE SUMMARY (KBtu/sqft-yr) Standard Proposed Compliance	
Energy Component Design Margin Space Heating 11.55 14.04 -2.49	
Space Cooling 54.75 35.30 19.44 Indoor Fans 38.23 24.14 14.09 Heat Rejection 0.00 0.00 0.00	
Pumps 0.00 0.00 0.00 Domestic Hot Water 12.59 12.56 0.03 Lighting 53.03 42.88 10.15	
Receptacle 16.92 16.92 0.00 Process 29.90 29.90 0.00	
TOTALS 216.97 175.74 41.23 GENERAL INFORMATION	
Conditioned Floor Area: 5940 Compliance Method: COMPLY 24 v5.05 Average Ceiling Height: 10.0 Location: Bakersfield AP Glass Area / Wall Area: 0.06 Climate Zone: 13 Average Glazing U-Value: 1.13 Front Orientation: 0 deg (N) Number of Stories: 1 Number of Zones: 3	Time Control Ventilation OA Damper S:Prog Switch B:Air Balance A:Auto O:Occ Sensor C:OA Cert. G:Gravity M:Man Timer M:OA Measure D:Demand Cont
Number of Occupancies: 1	
ZONE INFORMATION Floor Display Inst Tailored Process Tailored Area Perim. LPD Lighting Loads Vent. Zone Name (sqft) (ft) (w/sf) (watts) (w/sf) (y/n)	CERTIFICATE OF COMPLIANCE - Mechanical (part 2 of 2) MECH-1 page 9 of 17 Run Initiation Time: 13:52:18 Runcode: 2975-582381184
Special Ed Classroom 1980 0 1.33 0 1 N Special Ed/Ed. Tech Cr. 990 0 1.28 0 1 N Office Building 2970 0 1.60 0 3 N	Project Name: KCSS - 34th St. Community School Expansn Date: 5/22/1997 Documentation: LAWRENCE-NYE-BECKER ASSOC COMPLY 24 User 2975
PERFORMANCE CERTIFICATE OF COMPLIANCE (part 3 of 3) PERF-1 page 5 of 17 Run Initiation Time: 13:52:18 Runcode: 2975-582381184 Project Name: KCSS - 34th St. Community School Expansn Date: 5/22/1997 Documentation: LAWRENCE-NYE-BECKER ASSOC COMPLY 24 User 2975	DUCT INSULATION System Name Type Duct Location Allowed R-Val Field Carrier 58 WAV 091-16 Heating Ducts in Attic Cooling Ducts in Attic Y / N 4.2 Cooling Ducts in Attic
The documentation preparer hereby certifies that the documentation is	PIPE INSULATION Insul Note to System Name Pipe Type Required Field
DOCUMENTATION AUTHOR Seth Waltner (209) 226-0101 Contact and complete. (Signature) (Date)	Domestic Hot Water Y / N Carrier 58 WAV 091-16 Y / N
EXCEPTIONAL CONDITIONS COMPLIANCE CHECKLIST The local enforcement agency should pay special attention to the items specified in this checklist. These items require special written justification and documentation, and special verification to be used with the performance approach. The local enforcement agency determines the adequacy of the justification, and may reject a building or design that	NOTES TO FIELD - For Building Department Use Only
otherwise complies based on the adequacy of the special justification and documentation submitted. Special Ed Classroom 0.65 w/sf Process Load has been Input (See MECH-5) Special Ed/Ed. Tech Cr. 1.30 w/sf Process Load has been Input (See MECH-5)	
Office Building 2.66 w/sf Process Load has been Input (See MECH-5) BUILDING DEPARTMENT APPROVAL OF EXCEPTIONAL FEATURES JUSTIFICATION: The exceptional features listed in this performance approach application have specifically been reviewed. Adequate written justification and documentation for their use have been provided by the applicant.	
authorized signature or stamp	
CERTIFICATE OF COMPLIANCE - Envelope ENV-1 page 6 of 17 Run Initiation Time: 13:52:18 Runcode: 2975-582381184 Project Name: KCSS - 34th St. Community School Expansn Date: 5/22/1997	
Documentation: LAWRENCE-NYE-BECKER ASSOC COMPLY 24 User 2975	
OPAQUE SURFACES Const Note to Assembly Name Type Location/Comments Field	
Wood Stud w/ R-19 Wood R-30 Roof(R.30.2x12.16) Wood Corneted Slab On Grade None	
Carpeted Slab On Grade None	
FENESTRATION Frame Orient Panes Type Exterior Shade OH Glazing Type Left (E) 1 Metal None N Single Pane Bronze Left (E) 1 Metal None Y Single Pane Bronze Right (W) 1 Metal None Y Single Pane Bronze	

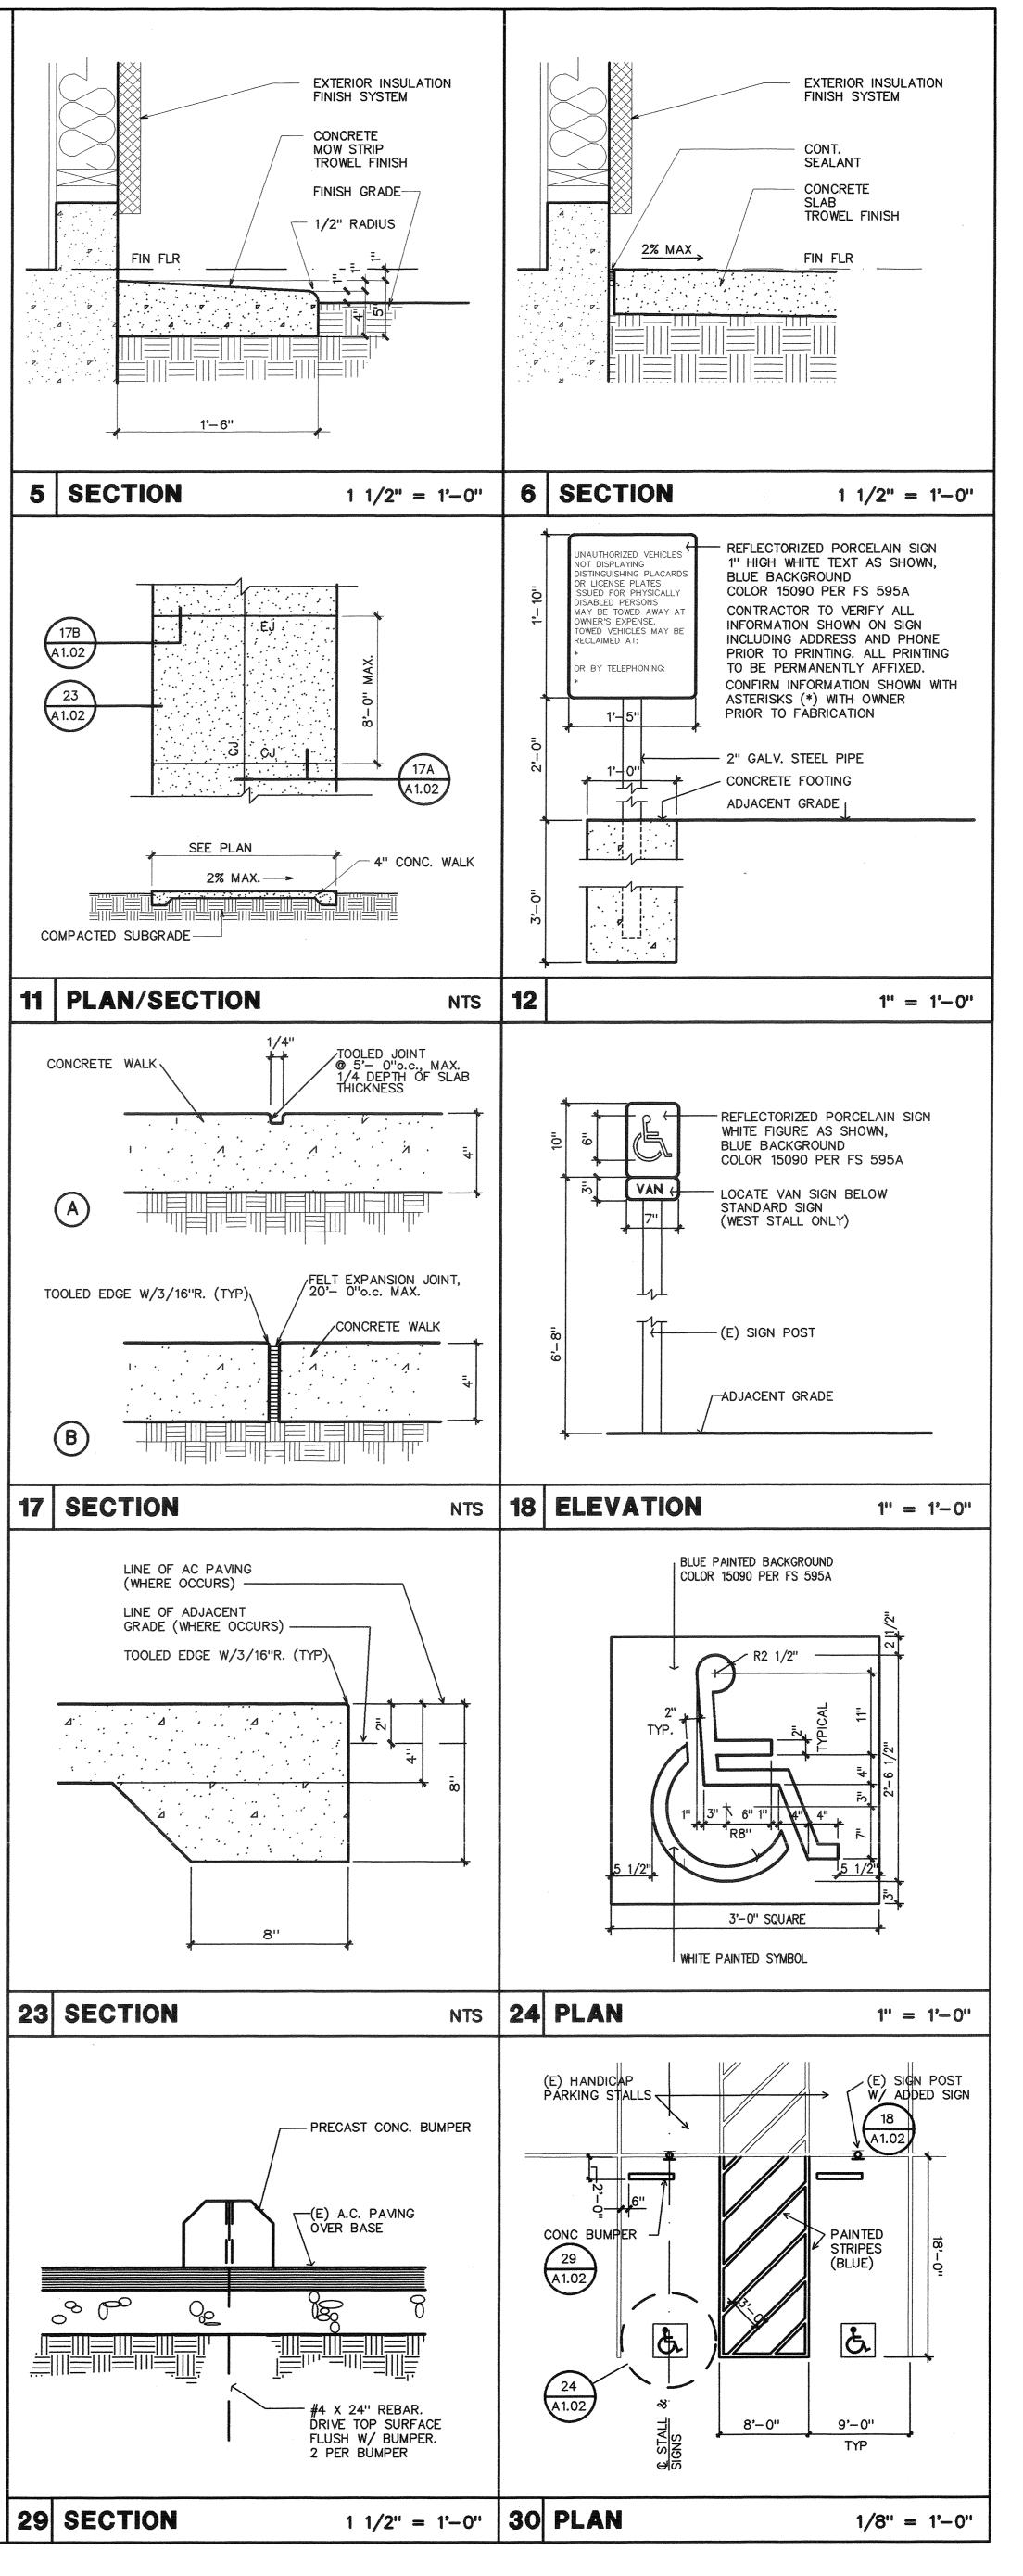

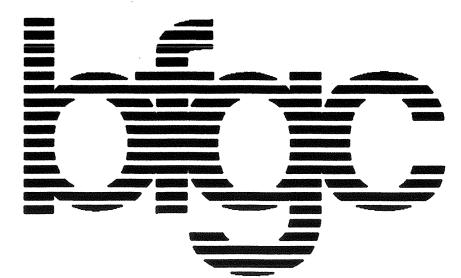



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principal architects

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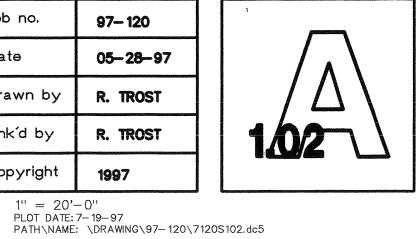
222 34TH STREET BAKERSFIELD, CA


Kern county superintendent of schools


ISSUED FOR B.P. #17, #20, #24

SITE DETAILS T-24 CALCULATIONS

job no.	97 120	
date	05-28-97	
drawn by	R. TROST	
chk'd by	R. TROST	
copyright	1997	



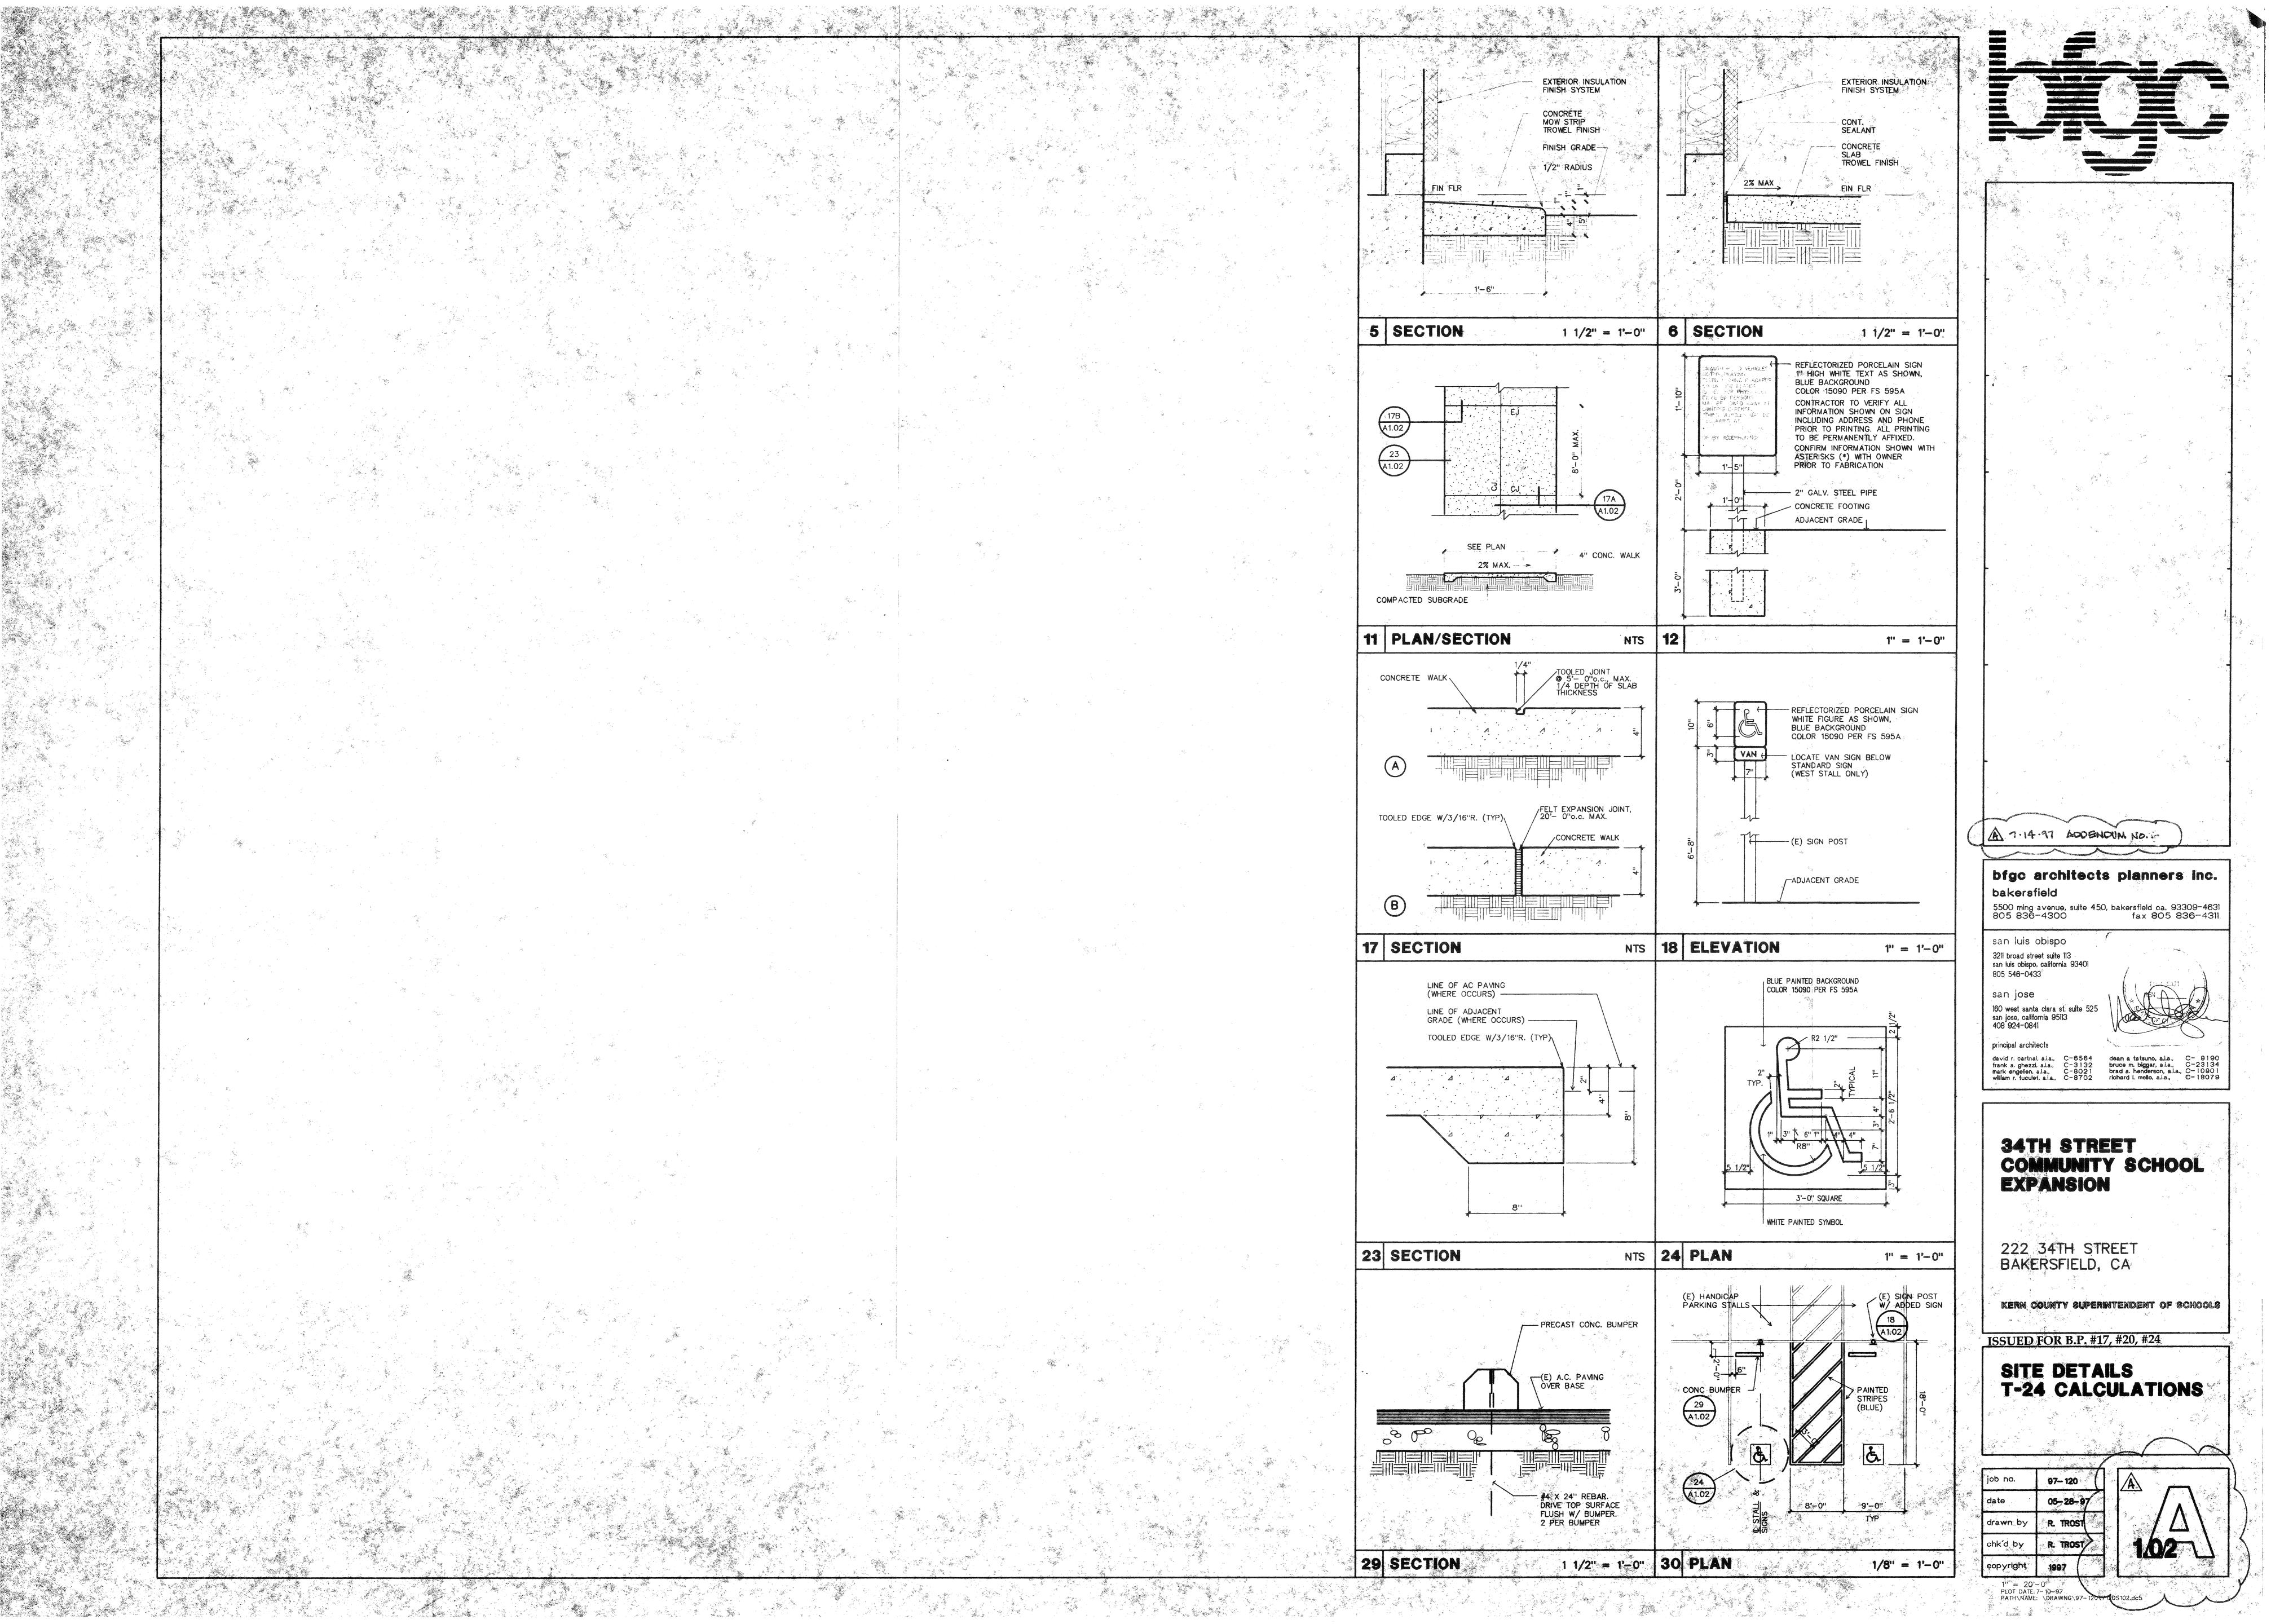

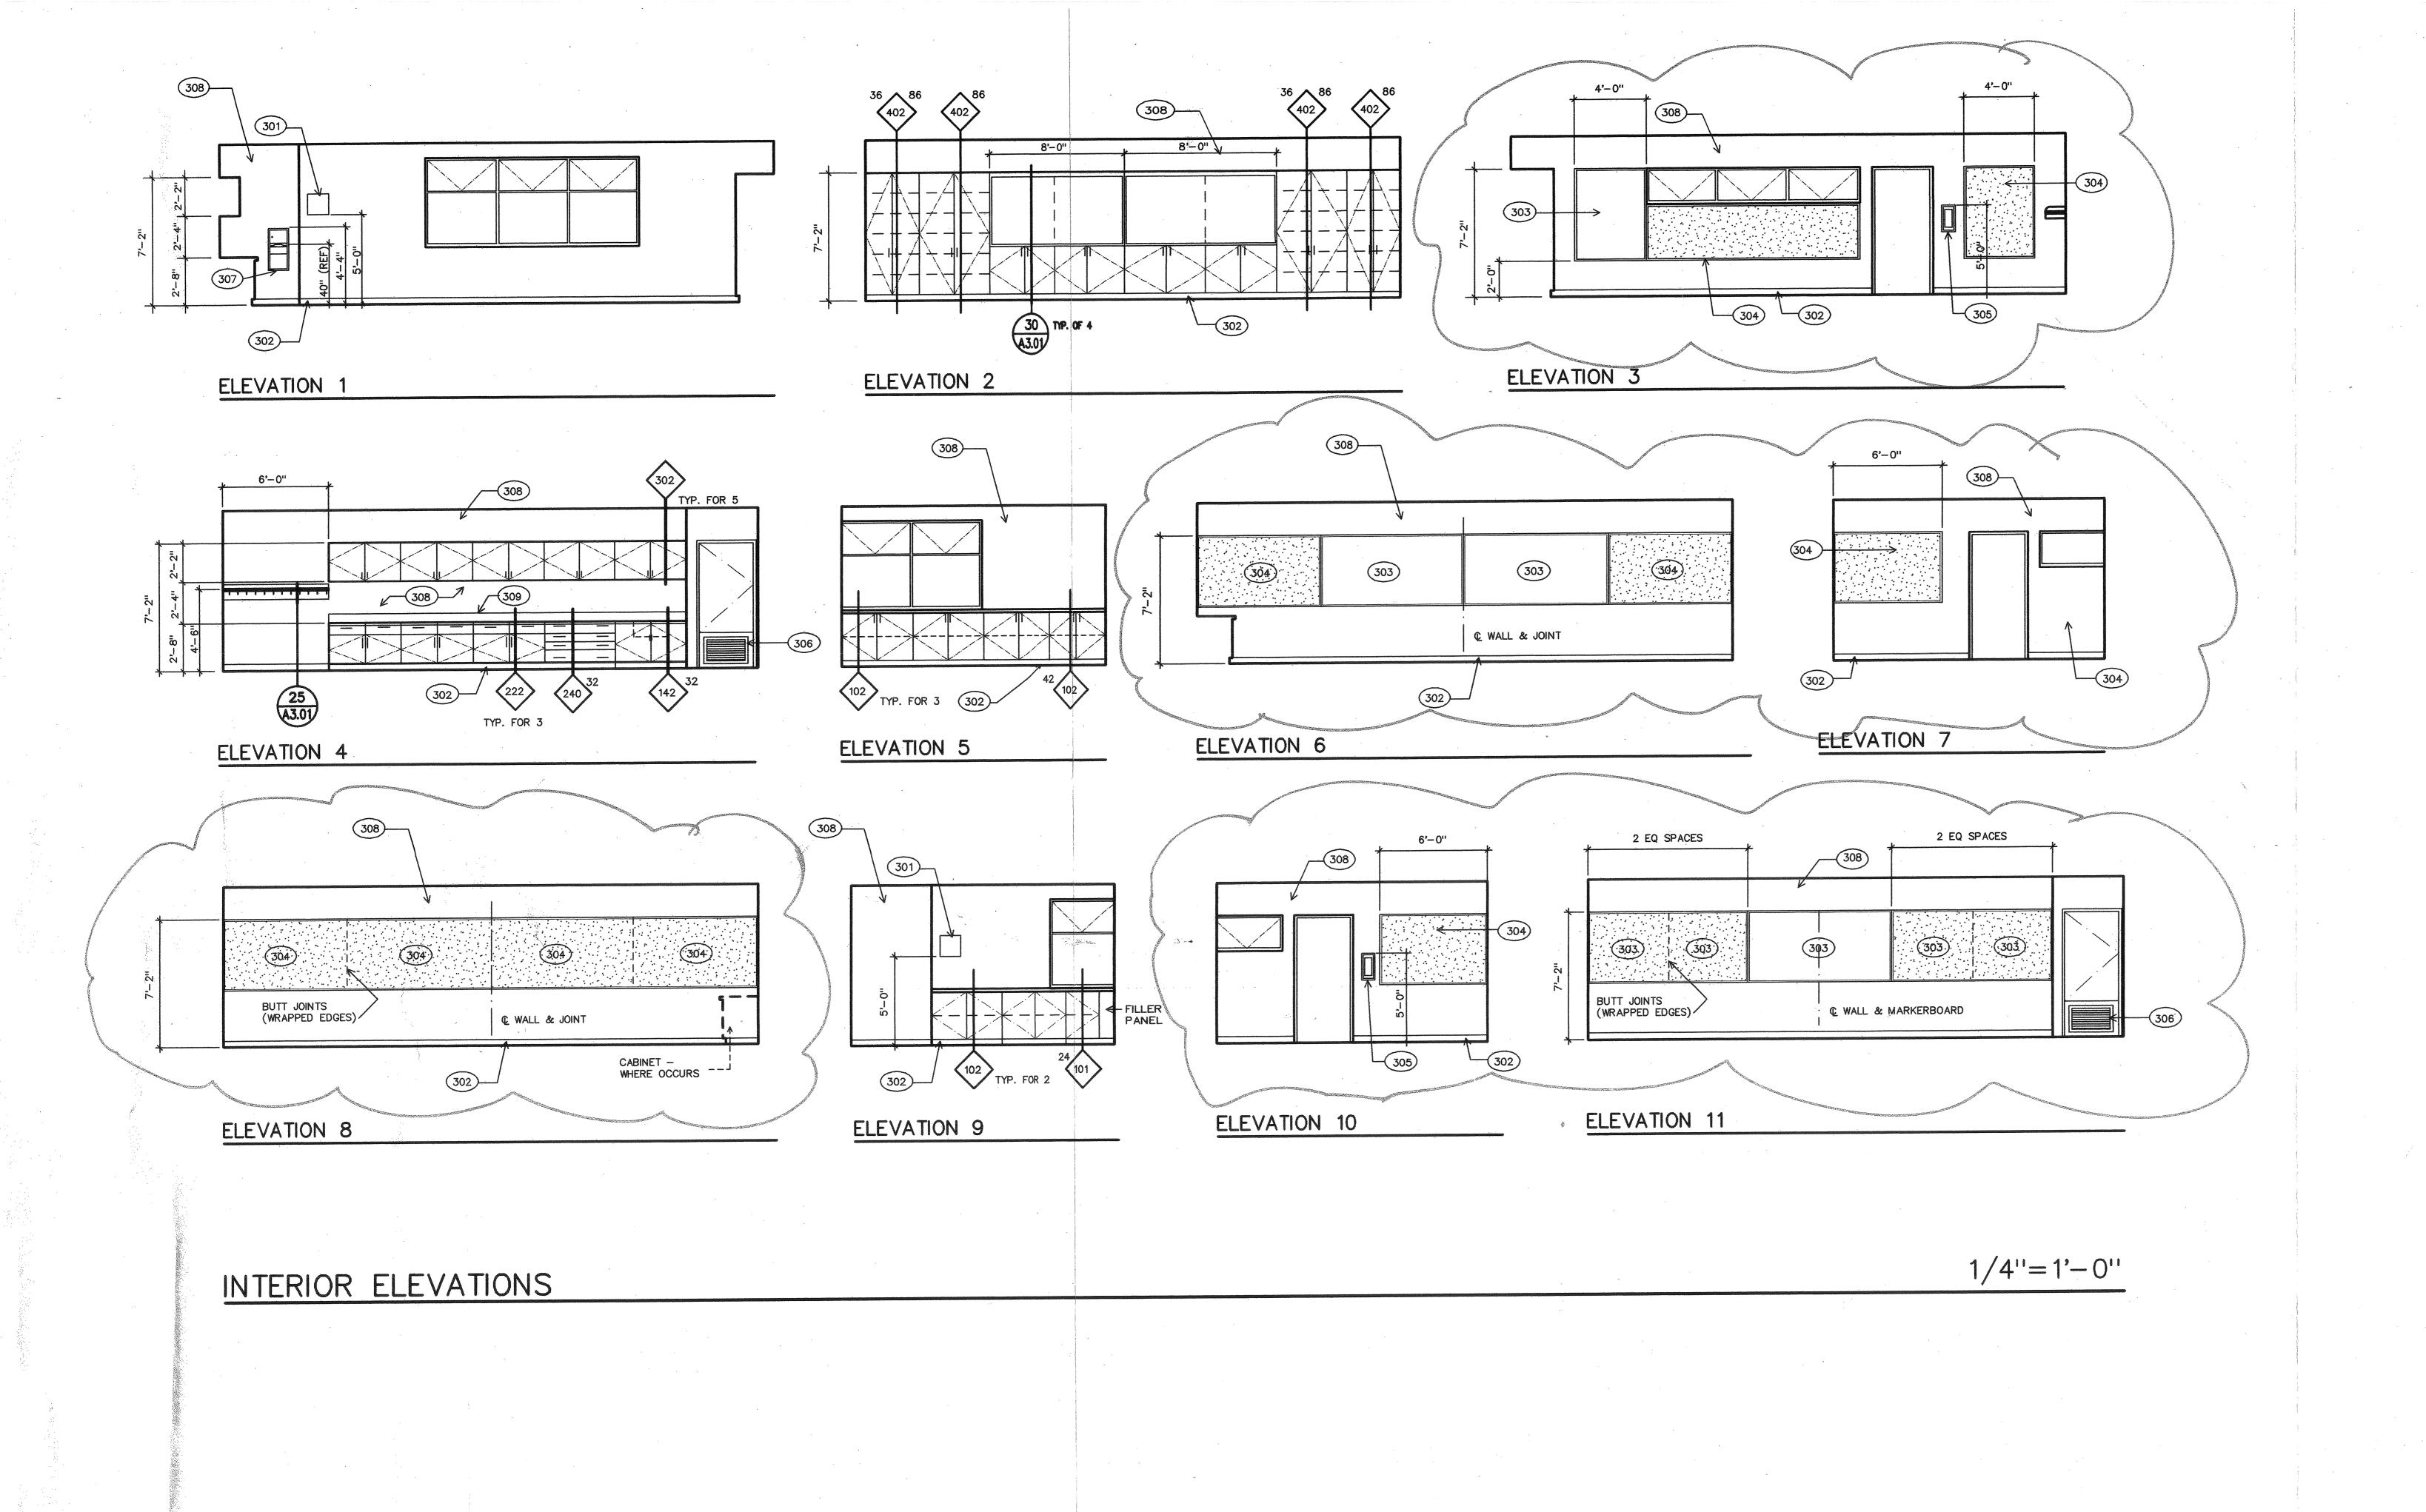



KEYNOTES

301) ELECTRICAL PANEL 302 TOP SET BASE

303 MARKERBOARD

304 TACKBOARD 305 FIRE EXTINGUISHER CABINET

306 RETURN AIR GRILLE

307 TOWEL/TRASH CABINET

308 GYP. BD., TAPE, TEX., & PAINT(ENAMEL)

309 6" LAM. PLAS. SPLASH

A00.#7 7.21.97 A 400 + 6 7.7.97

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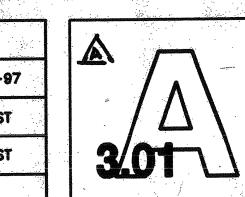
222 34TH STREET BAKERSFIELD, CA


Kern county superintendent of schools


ISSUED FOR B.P. #17, #20, #24

INTERIOR ELEVATIONS CABINET DETAILS

ob no.	97-120
date	05-28-97
drawn by	R. TROST



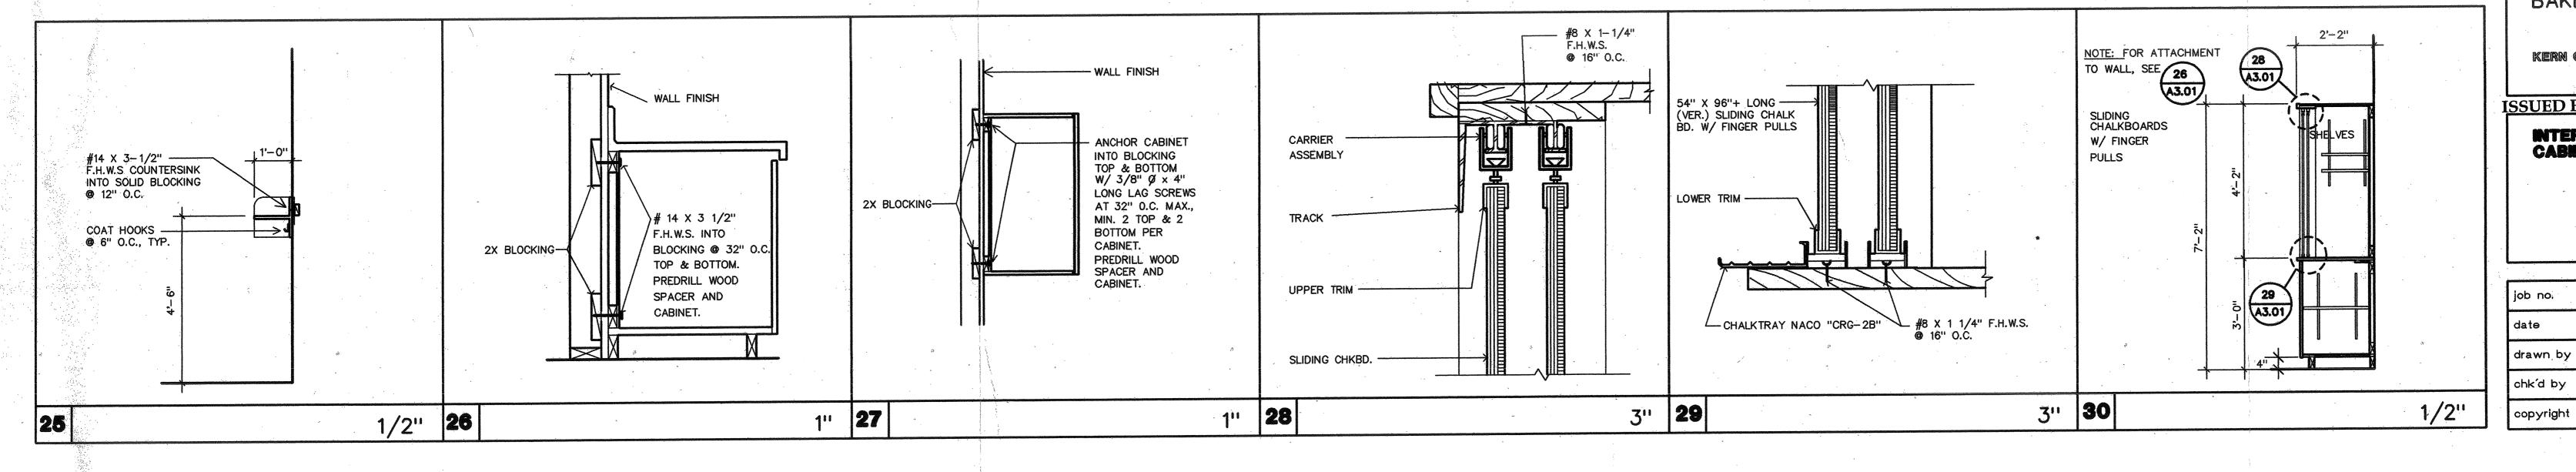

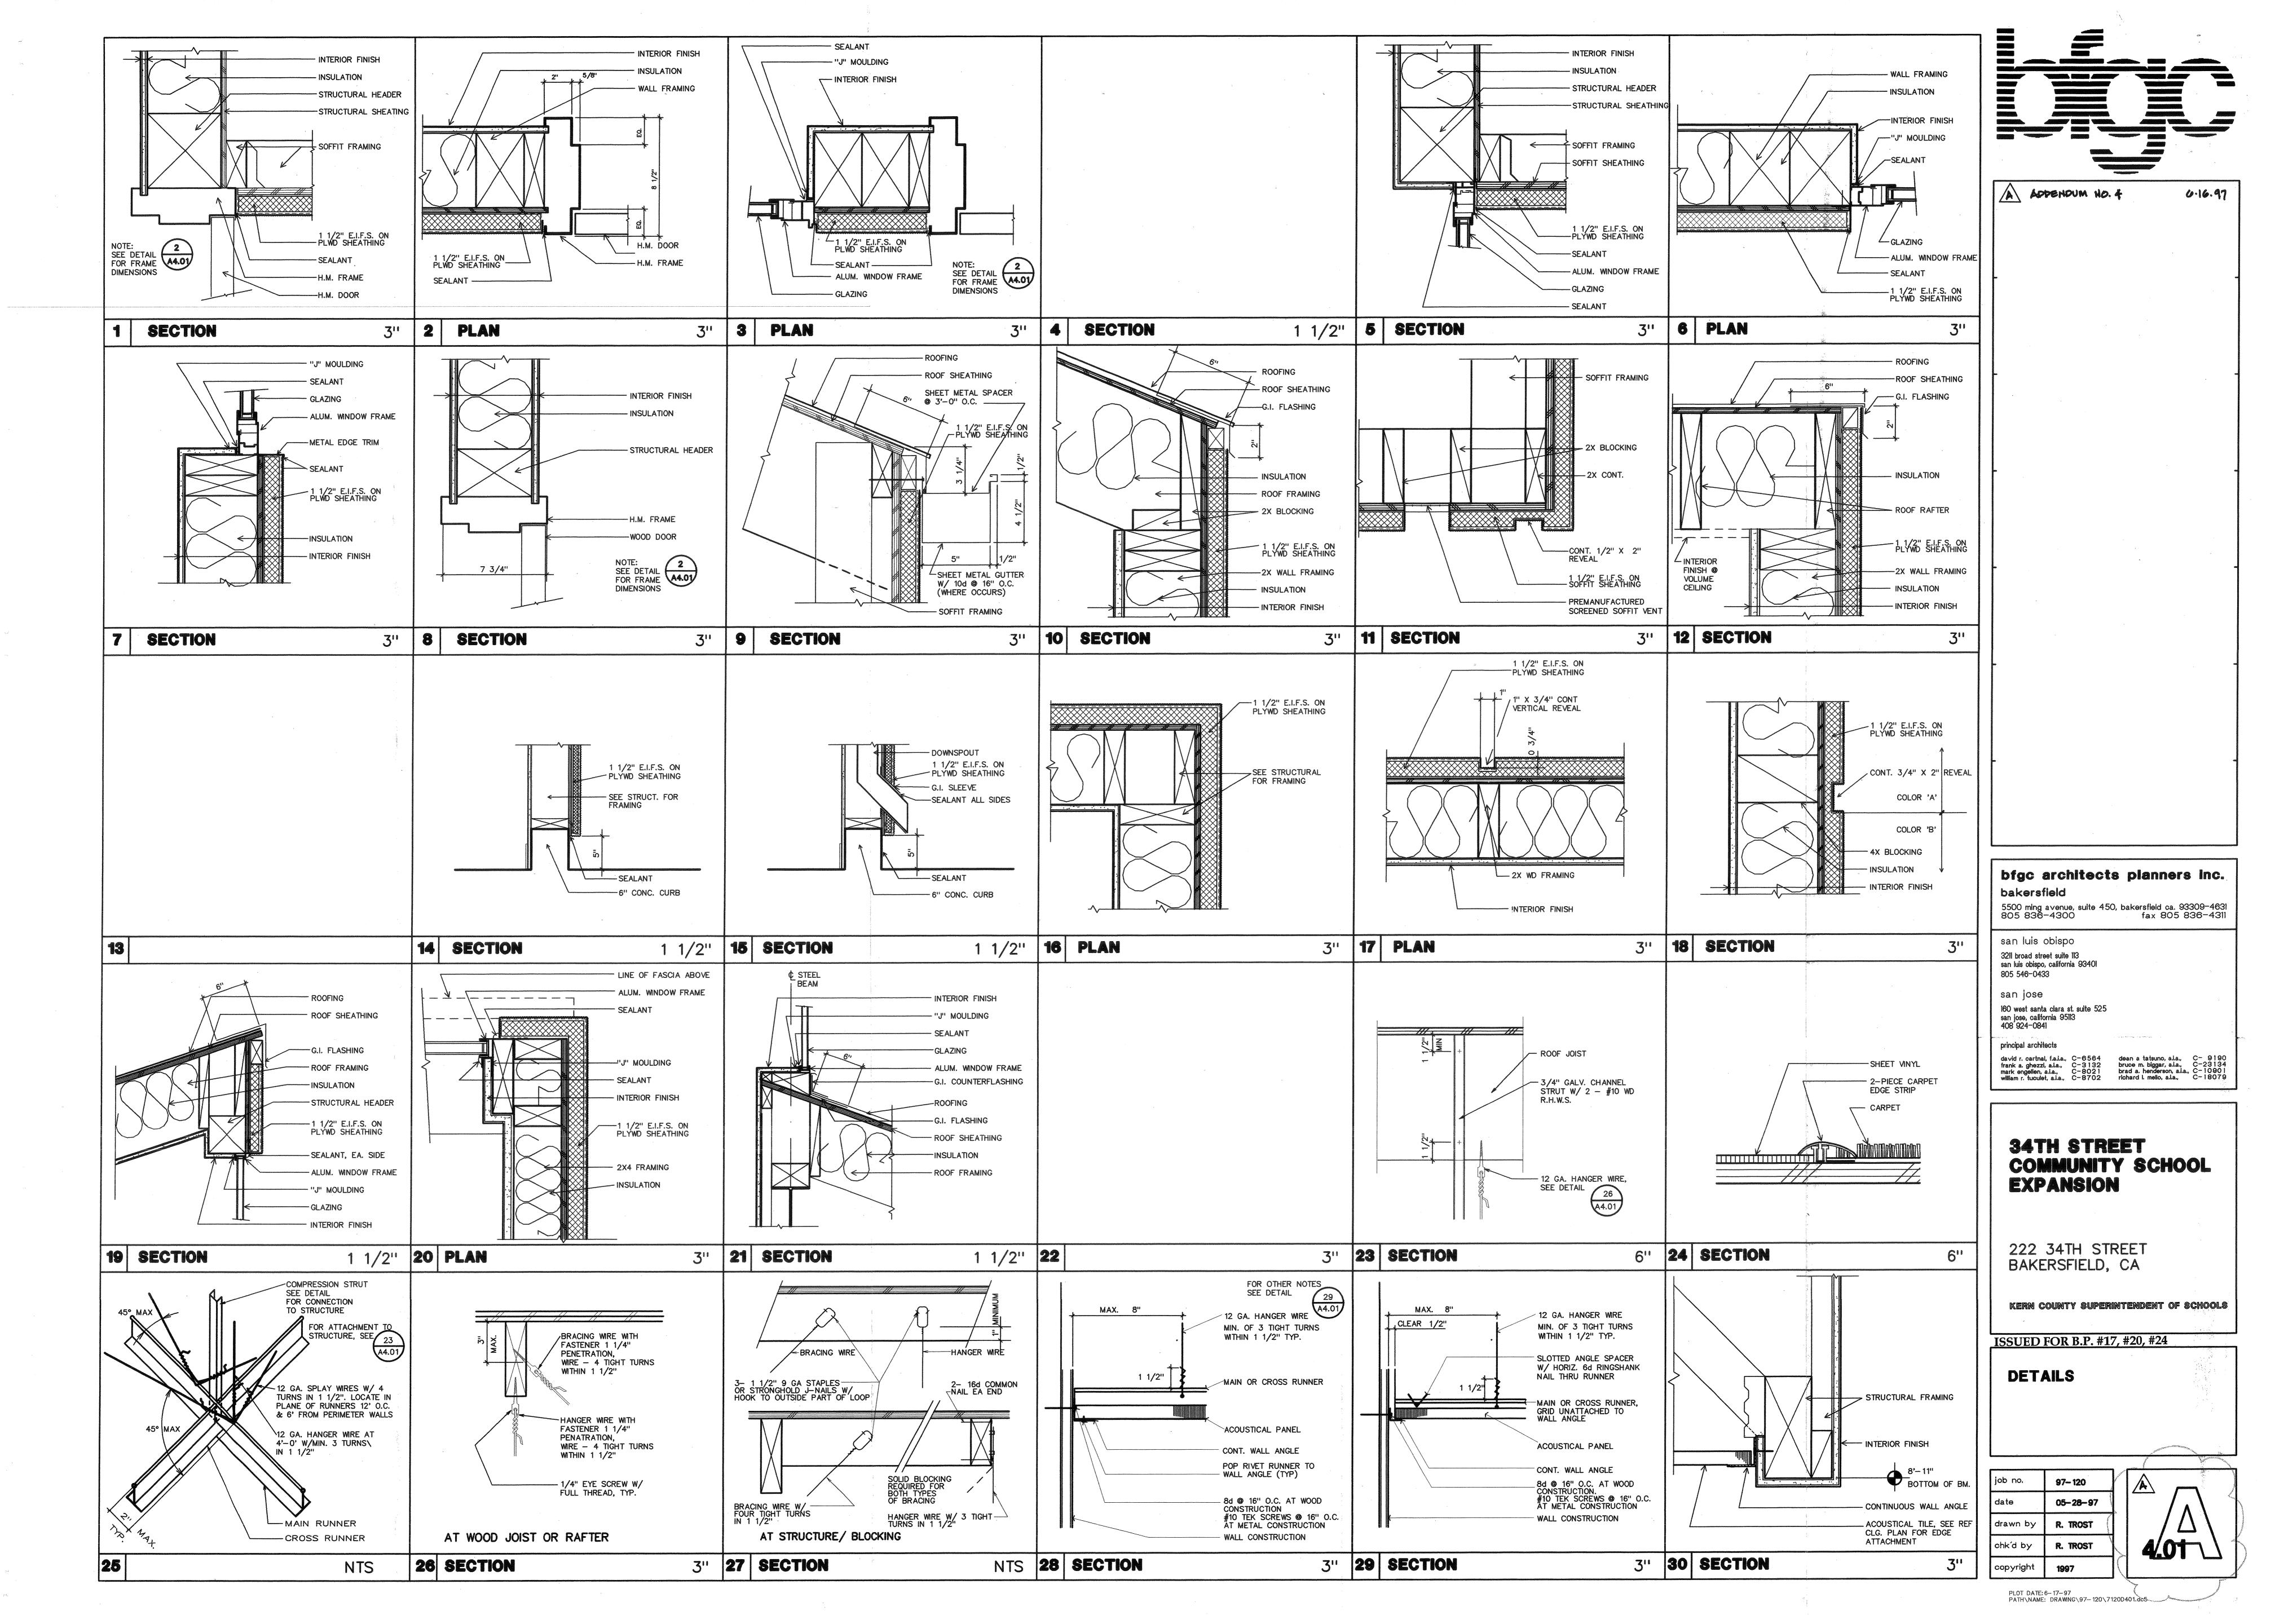

ANCHORED ADEQUATLY FOR SEISMIC LOADS.

CODE OF REGULATIONS (C.C.R.)

TYPICAL DETAILS AND GENERAL NOTES SHALL APPLY IN ALL CASES UNLESS SPECIFICALLY SHOWN OTHERWISE ON THE DRAWINGS. WHERE NO DETAIL IS SHOWN, CONSTRUCTION SHALL BE AS SHOWN FOR OTHER SIMILAR WORK. NO DEVIATIONS FROM THE DRAWINGS SHALL BE

PERMITTED WITHOUT PERMISSION OF THE ENGINEER. SEE NON-STRUCTURAL DRAWINGS AND SPECIFICATIONS FOR ITEMS NOT SHOWN ON THE STRUCTURAL DRAWINGS AND SPECIFICATIONS. ALL EQUIPMENT SHALL BE BRACED AND

WHERE CONSTRUCTION MATERIALS ARE TEMPORARILY STORED ON THE ROOF FRAMING, THEY SHALL BE DISTRIBUTED SO THAT THE LOAD DOES NOT EXCEED 20 LBS/SF. THE CONTRACTOR SHALL:

- 1. VERIFY ALL (E) EXISTING CONDITIONS AND DIMENSIONS AND REPORT ANY DIFFERENCES IN ASSUMED CONDITIONS TO THE ENGINEER PRIOR TO
- 2. PROVIDE AND BE SOLELY RESPONSIBLE FOR ALL TEMPORARY SHORING, GUYS AND BRACING NECESSARY FOR STRUCTURAL WORK SHOWN ON THESE DRAWINGS.
- 3° PERFORM ALL WORK AND RECEIVE ALL TESTS AND INSPECTIONS IN ACCORDANCE WITH THE PROJECT DRAWINGS, SPECIFICATIONS, THE "STRUCTURAL TESTS & INSPECTIONS SCHEDULE" AND TITLE 24, PART 2 OF THE CALIFORNIA
- 4. BE SOLELY RESPONSIBLE FOR CONDITIONS AT THE JOB SITE, INCLUDING SAFETY OF ALL PERSONS AND PROPERTY.
- 5. PERFORM ALL DEMOLITION, REMOVAL AND DISPOSAL IN CONFORMANCE WITH ALL APPLICABLE LAWS, ORDINANCES, RULES AND REGULATIONS. EXCESS MATERIAL SHALL BE REMOVED FROM THE SITE AND DISPOSED OF OFF SITE UNLESS. OTHERWISE DIRECTED BY THE ARCHITECT.
- 6. PERFORM ALL WORK UNDER CONTINUOUS INSPECTION OF AN DIVINGH OF THE STATE ARCHITECT (D.S.A.) APPROVED INSPECTOR.

ALL SUPPORT SERVICES PERFORMED BY THE ENGINEER DURING CONSTRUCTION SHALL BE DISTINGUISHED FROM CONTINUOUS AND DETAILED INSPECTION SERVICES WHICH ARE FURNISHED BY OTHERS. THE SUPPORT SERVICES PERFORMED BY THE ENGINEER, ARE PERFORMED SOLELY FOR THE PURPOSE OF ASSISTING IN QUALITY CONTROL AND IN ACHIEVING CONFORMANCE WITH THE CONTRACT DRAWINGS AND SPECIFICATIONS. THESE SUPPORT SERVICES DO NOT GUARANTEE THE CONTRACTOR'S PERFORMANCE AND SHALL NOT BE CONSTRUED AS SUPERVISION OF CONSTRUCTION.

THE D.S.A APPROVED INSPECTOR SHALL NOTIFY THE STRUCTURAL ENGINEER TWO (2) WORKING DAYS PRIOR TO:

- 1. START OF CONSTRUCTION.
- 2. POURING CONCRETE.
- 3. COVERING PLYWOOD SHEATHING AND FRAMING.

FOUNDATIONS AND SLABS SHALL BE PLACED ONLY ON FIRM BEARING AND NOT ON LOOSE SOIL OR UNCOMPACTED FILL. THE CONTRACTOR SHALL PERFORM ALL WORK AND RECEIVE ALL TESTS AND INSPECTIONS IN ACCORDANCE WITH THE DRAWINGS # SPECIFICATIONS

SOIL TYPE: SILTY SAND, SAMOY SILT & SAMO BASIC ALLOWABLE BEARING PRESSURE: /500 LBS/SF.

THE GEOTECHNICAL INVESTIGATION REPORT BY "BSK, INC" JOB NO 03200195 PATED MAY 5, 1997 IS AVAILABLE TO THE CONTRACTOR FOR REVIEW.

MATERIALS SHALL BE CONTINUOUS, DEFORMED BARS CONFORMING TO ASTM A615: ## BARS & SMALLER . . . GRADE 40 # SBARS & LARGER . . . GRADE 60 CONTINUOUS BAR SPLICES (UNO) SHALL BE:

MASONRY 40 BAR DIAMETERS (2'-0" MINIMUM) CONCRETE 30 BAR DIAMETERS (2'-0" MINIMUM) CONCRETE COVERAGE FOR REINFORCEMENT SHALL BE:

CAST AGAINST FORMS & PERMANENTLY EXPOSED TO EARTH OR WEATHER . . . 2" CAST AGAINST FORMS & NOT PERMANENTLY EXPOSED TO EARTH OR WEATHER SLABS, WALLS & JOISTS 3/4" BEAMS, GIRDERS & COLS 1-1/2"

MATERIALS SHALL CONFORM TO THE FOLLOWING SPECIFICATIONS: PORTLAND CEMENT (ONE BRAND, DONESTIC). ASTM C150 (AGGREGATES SHALL CONTAIN NOT MORE THAN 2%

SHALE OR OTHER DELETERIOUS PARTICLES.) ADMIXTURE (TYPE A. WATER REDUCING) ASTM C494 OF FINISHES, COVERINGS OR PAINT)

(NO FREEWATER, NO SLUMP, TAMP INTO PLACE) EPOXY RAMSET "EPCON" CERAMIC 6 (ICBO #4285)

CONCRETE MIX AND CONSTRUCTION SHALL BE TYPE II, REGULAR WEIGHT (145 LBS.) AND CONFORM TO THE FOLLOWING: MINIMNM ULTIMATE COMPRESSIVE STRENGTH @ 28 DAYS . . 3000 PSI MAXIMUM SLUMP (PER ASTM C-143) 4 INCHES

CONTRACTOR SHALL SUBMIT A CONCRETE DESIGN MIX, APPROVED BY A CALIFORNIA LICENSED CIVIL ENGINEER, TO THE ARCHITECT FOR REVIEW 15 WORKING DAYS PRIOR TO PLACEMENT. THE MIX DESIGN SHALL BE IN ACCORDANCE WITH THE C.C.R.. TITLE 24; SECTION 2604(C), METHOD "B".

MINIMUM CEMENT CONTENT 5.75 SACKS/CY

SONCRETE MASONRY

TOP OF TH' BLOCK.

CONCRETE BLOCK SHALL BE GRADE N-1, MEDIUM OR LIGHT WEIGHT (WITH A DRY NET WEIGHT OF NOT MORE THAN 115 LBS. PER CUBIC FOOT), OPEN-END UNITS AND COMFORM TO ASTM C-90 MINIMUN COMPRESSIVE STRENGTHS.

FILL ALL CELLS WITH GROUT. NO SPLICES SHALL BE PERMITTED IN VERTICAL REINFORCING EXCEPT WHERE DETAILED ON THE DRAWINGS. ALL ISOLATED BOLTS EMBEDDED IN MASONRY SHALL BE GROUTED SOLIDLY IN PLACE WITH NOT LESS THAN I' OF GROUT SURROUNDING THE BOLT IF WORK IS STOPPED FOR ONE HOUR OR LONGER, PROVIDE HORIZONTAL CONSTRUCTION JOINT BY STOPPING THE GROUT 1-1/2" BELOW THE

MINIMUM MORTAR STRENGTH @ 28 DAYS (TYPE (SHALL CONTAIN NO ADMIXTURES) MINIMUM GROUT STRENGTH @ 28 DAYS . 🖊

(SHALL CONTAIN "SIKA GROUT AID, TYPE II", AS PER MANUFACTURERS RECOMMENDATIONS. NO OTHER ADMIXTURE SHALL BE ADDED. CONTRACTOR SHALL SUBMIT A GROUT DESIGN MIX, APPROVED BY & CALIFORNIA LICENSED

PL'ACEMENT. SEE ARCHITEPTURAL DRAWINGS FOR TYPES OF MATERIALS USED FOR VENEERS. SONRY WORK SHALL BE CONTINUOUSLY INSPECTED BY AN AS A APPROVED SPECIAL

CIVIL ENGINEER, TO THE ARCHITECT FOR REVIEW 15 WORKING DAYS PRIOR TO

SHAPES, PLATES, BARS, RODS ASTM A36, (FY = 36 KSI) PIPES ASTM A53, GRADE B, (FY = 35 KSI) SQUARE & RECTANGULAR TUBING ASTM A500, GRADE B, (FY = 46 KSI) WELDING ELECTRODES AWS E70XX MACHINE BOLTS & ANCHOR BOLTS ASTM A36 OR ASTM A307 AUTOMATIC END WELDED STUDS ASTM A108 (NELSON GRANULAR FLUX FILLED STUDS

WELDING SHALL BE DONE BY THE ELECTRIC SHIELDED ARC OR SUBMERGED ARC PROCESS. WELDERS SHALL BE CERTIFIED AND WORK DONE IN ACCORDANCE WITH THE STRUCTURAL WELDING CODES. AWS D1.1. FABRICATION AND ERECTION SHALL CONFORM TO THE LATEST EDITION OF THE AISC SPECIFICATIONS. ALL STEEL NOT IN CONTACT WITH CONCRETE SHALL RECEIVE ONE COAT OF SHOP PAINT IN ACCORDANCE WITH THE PROVISIONS OF THE CODE OF STANDARD PRACTICE OF AISC AND THE SPECIFICATIONS. SHOP DRAWINGS SHALL BE SUBMITTED TO AND REVIEWED BY THE ARCHITECT PRIOR TO FABRICATION. THE STEEL FABRICATOR SHALL VERIFY ALL DIMENSIONS, DETAILS AND QUANTITIES WITH THE DRAWINGS.

FRAMING LUMBER SHALL BE DOUGLAS FIR & GRADE MARKED AS FOLLOWS (UND): 2X4 & SMALLER- STANDARD OR BETTER 2X6 & DEEPER (NO. 2)

3X & LARGER NO. 1 SILLS (HEM FIR OR DOUGLAS FIR) (PRESSURE TREATED) NO. 2 STANDARD CÚT WASHERS SHÁLL BE USED UNDER BOLT HEADS AND NUTS THAT WOÙLD OTHERWISE BEAR ON WOOD SURFACES. ALL LIGHT GAGE METAL CONNECTORS SHALL BE MANUFACTURED BY "SIMPSON STRONG-TIE CO., INC." OR APPROVED EQUAL. ALL "HD" CONNECTORS SHALL BE INSTALLED WITH WASHERS AS PER MANUFACTURES RECOMMENDATIONS. RETIGHTEN BOLTS BEFORE CLOSING IN.

ALL NAILS SHALL BE COMMON GAGE, UNCOATED AND HAVE FULL HEADS.

C1015 COLD ROLLED STEEL)

WHERE DRIVING NAILS CAUSES SPLITTING, LEAD HOLES WITH A DIAMETER EQUALING 60 TO 75 PERCENT OF THE NAIL DIAMETER SHALL BE PROVIDED. NAILING SHALL BE AS PER CC.R. CHAPTER 23. "NAILING SCHEDULE".

LAG SCREWS OR LAG BOLTS: CONNECTORS SHALL BE INSERTED IN DRILLED HOLES AS SHOWN ON THE PLANS. THE THREADED PORTION OF THE CONNECTOR SHALL BE INSERTED IN ITS LEAD HOLE BY TURNING IT WITH A WRENCH AND NOT BY DRIVING IT WITH

	PLYW	OOD SHEATHING SCHEL	DULE	
IDENT.	MATERIAL	NAILING	REMARKS	
ROOF SI+7Cs (TYP. UNO)	Se" PLYWD., APA RATED SHTG., EXPOSURE I, 40/20	10d e G " BOUND. 10d e G " EDGES 10d e 12" INTERM.	1. 4 x BLRG & PLYWO JTS.	
Δ.	"OMIT"	a constant		
2 \$ 10001 WALL SHTG	APA RATED SHTG., EXPOSURE I, 24/0 , STRUCT. I	/0d e 6" BOUND: /0d e 6" EDGES /0d e/2" INTERM.	1. 2 m P.T. SILL 12 m/ 58" \$ m 1- ABOUTS & 4:0" B.C.	0
ROOF SHTER	MIT		English Colon Parketing	and the second s

FOOT NOTES

(1) SEE THIS SHT FOR GENERAL NOTES AND TYPICAL DETAILS.

(2) PLYWOOD SHALL CONFORM TO PS-1-83. PANELS SHALL BE STAGGERED AND PLACED SO THAT THE FACE GRAIN IS PERPENDICULAR TO THE SUPPORTING MEMBERS (UNO) .

(3) PLYWOOD NAILS SHALL HAVE FULL HEADS AND BE OF THE FOLLOWING SIZES: 100 = :148" DIA. X 2-3/8" LONG (RING SHANK OR SCREW SHANK) 8D = .131" DIA. X 2-1/8" LONG. (4) NO PANEL LESS THAN 24 INCHES WIDE SHALL BE USED IN ANY HORIZONTAL

PLYWOOD DIAPHRAGM. NO PANEL LESS THAN 12 INCHES WIDE SHALL BE USED IN ANY VERTICAL PLYWOOD DIAPHRAGM.

(5) THE EDGES OF ALL OPENINGS SHALL BE PERIMETER NAILED PER THE BOUNDARY NAILING REQUIRED FOR THAT AREA. (6) THE PLYWOOD EDGE DISTANCE ON A 2-1/2" OR WIDER MEMBER SHALL BE

3/4" MINIMUN. THE PLYWOOD EDGE DISTANCE ON A 1-1/2" WIDE MEMBER SHALL BE 3/8" MINIMUN. NAILS MAY BE SLANT DRIVEN TO MAINTAIN THE MINIMUM EDGE DISTANCE.

TO CONTINUED SATISFACTORY PERFORMANCE. IF NAILHEADS PENETRATE


THE OUTER PLY MORE THAN WOULD BE NORMAL FOR A HAND HAMMER OR IF

OMIT - TWO LAYERS OF PAPER SHALL BE PLAGED BETWEEN ALL PLYWOOD AND GEMENT PLASTER FOR MOISTURE PROTECTION OF THE PLYWOOD. (8) NAILHEADS SHALL NOT PENETRATE THE OUTER PLY OF PLYWOOD MORE THAN WOULD


BE NORMAL FOR A HAND-HAMMER. (9) THE USE OF MACHINE NAILING IS SUBJECT TO A SATISFACTORY JUBSITE DEMONSTRATION AND THE APPROVAL BY THE PROJECT ARCHITECT OR STRUCTURAL ENGINEER AND THE OFFICE OF THE STATE ARCHITECT. THE APPROVAL IS SUBJECT

MINIMUM ALLOWABLE EDGE DISTANCES ARE NOT MAINTAINED, THE PERFORMANCE WILL BE DEEMED UNSATISFACTORY. SPAN/3 MAX

DMIT THIS SECTION

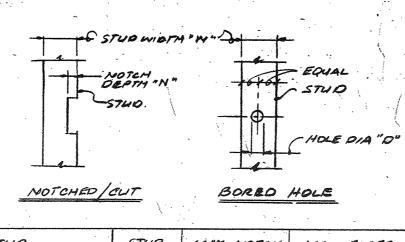

STUD	STUD	MAX. NOTCH	MAX BOREL
LOCATION.	WIDTH	DEPTH.	HOLE DIA.
EXTERIOR & BEARING WALLS.	3'2" 5'2" 74"	-0-	/'s" "178" 238"
NON- BEARING PARTITIONS.	3½"	/ ³ 8*	/'8"
	5½"	2'8"	/'3"
	7¼"	2 ⁷ 8"	'23g"

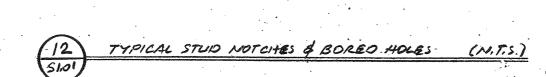

-2-2x CONT. RS

HOLE OR NOTCH

EXCEEDING DIS

-2×516L

NAILED SPLICE

4'0" MIN. STAGGER NAILS 3-16d EA END (12-16d FOTAL)


4> & VAMBSTUD

2= TRIMMER

EANCHORAGE

OPNES GO WIDE \$1855 USE 1-2x 7

13 WALL FRAMING DETAILS

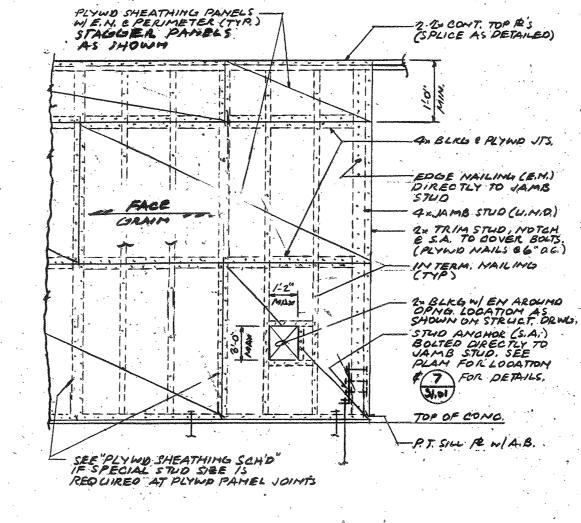

(4x. U.N.O. ON PLAN)

1. BOLT DIA.

PLY:WD S.P. W/ E.N

NOTE: SEE PLAN FOR LOCATION & SIZE

STUD ANCHOR (S.A.)

OF S.A. & JAMB STUD.

ASTUD ANCHOR (S.A.)


- 16de6

S.A. TYPE

"HOZA" W/ 2-56"

"4084" W/3.78"

PLYWO EN. | BOLTS TO JAME 4 78 4 18 16"

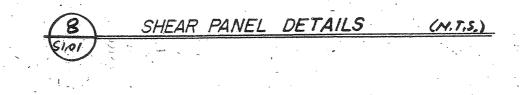

FOUNDATION CONCRETE MAY BE PLACED DIRECTLY INTO NEAT

EXCAVATIONS PROVIDED THE FOUNDATION TRENCH WALLS ARE

STABLE AS DETERMINED BY THE ARCHITECT (STRUCTURAL

ENGINEER) SUBJECT TO THE APPROVAL OF THE OFFICE OF

FORMWORK SHOWN ON THE DRAWINGS IS MANDA TORY TO

SEE PLAN

UNFORMED FOOTING

APPLICA BLE

er PLANKING

PERMITTED WIN

FOOTING SECTION.

CURB OR STARTER WALL

THE STATE ARCHITECT. IN SUCH CASE THE MINIMUM

INSURE CLEAN EXCAVATIONS IMMEDIATELY PRIOR TO AND DURING THE PLACING OF CONCRETE.

AFTER SET - REMOVE -LAITANCE & SCUM

BELOW GRADE UNLESS


FULLY FORMED


CONTINUOUS MIN. CLEAN OUT.

3'2" STARTER WALL


REQ'O FOR FTGS. BELOW GRADE & FOR


FORMWORK NOT PERMITTED

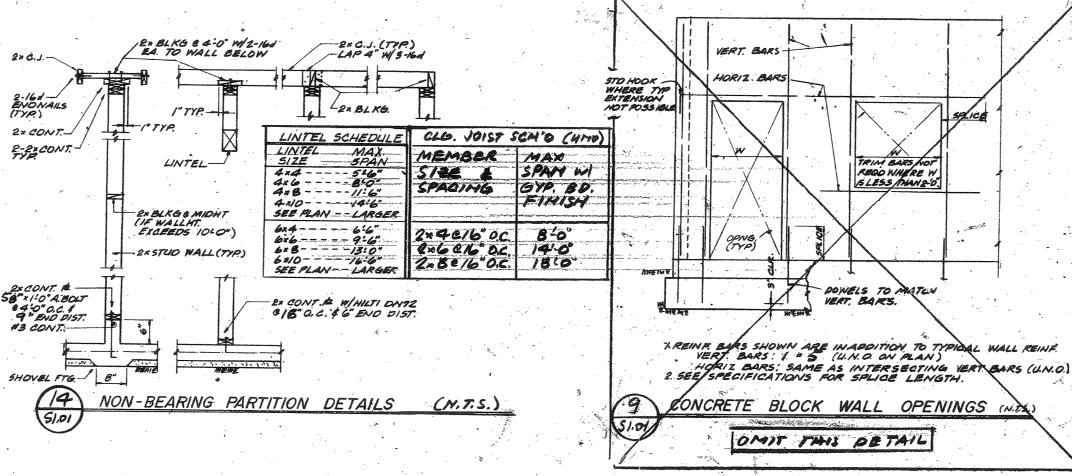

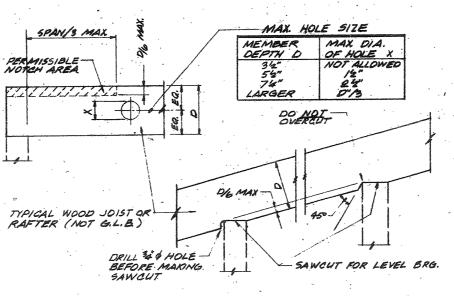





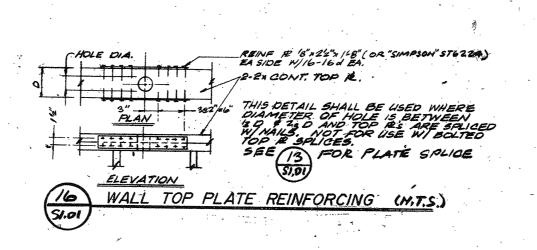


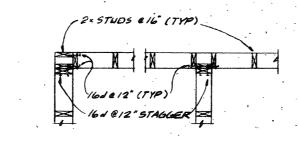


INTERSECTION

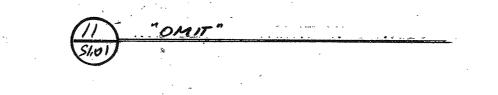


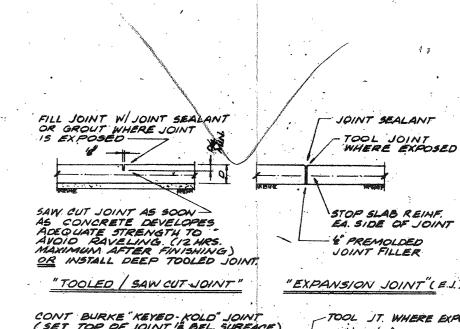


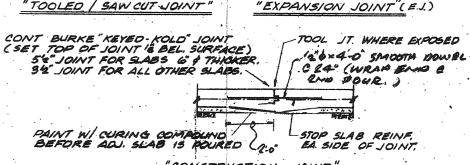



WHERE DRAWINGS INDICATE C.J. (CONTROL JOINT CONTRACTOR SHALL USE TOOLED SAW CUTTOR "CONSTRUCTION JOINT" AS SHOWN ABOVE SPACED & 16" O.C. EA. WAY, MAK. (U.N.O.). 2. WHERE DRAWINGS INDICATE E.J., CONTRACTOR SHALL USE EXPANSION JOINT AS SHOWN ABOVE. SEE FOUNDATION PLAN FOR SLAB & SUBGRADE DETAILS CONCRETE SLAB JOINT

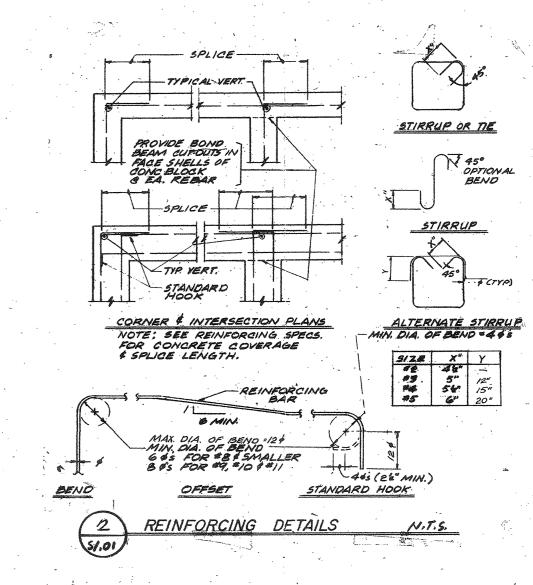


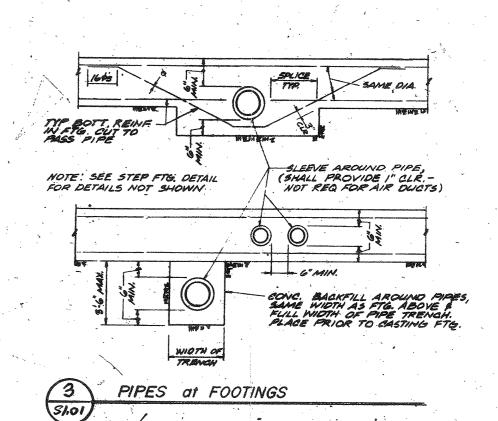

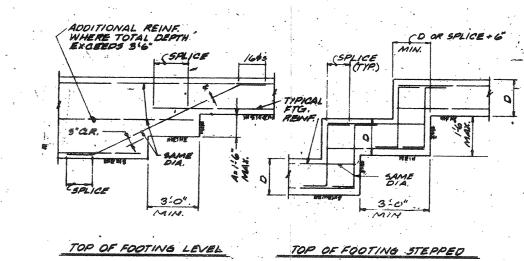


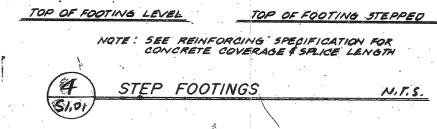

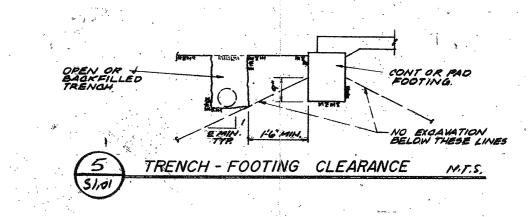

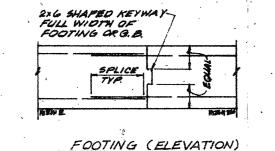

WALL (PLAN SECTION)

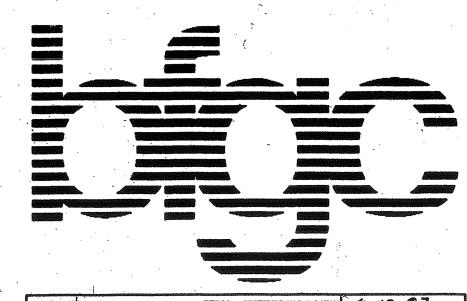

A ADDEHOUM #5



bfgc architects planners inc. bakersfield

5500 ming avenue, suite 450, bakersfield ca. 93309-4631 805 836-4300 fax 805 836-4311

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805 546-0433

principal architects

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san jose, california 95113 403 924-0841

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34TH STREET **COMMUNITY SCHOOL EXPANSION**

222 34TH STREET BAKERSFIELD, CA

KERN COUNTY SUPERINTENDENT OF SCHOOLS

STRUCTURAL


ISSUED FOR B.P. #17, #20, #24


97-120


GENERAL NOTES

05-28-97 date drawn by chk'd by JOF copyright

497026B PLOT, DATE: 5-28-97 PATH\NAME: DRAWING\97-118\848RST11.dc5

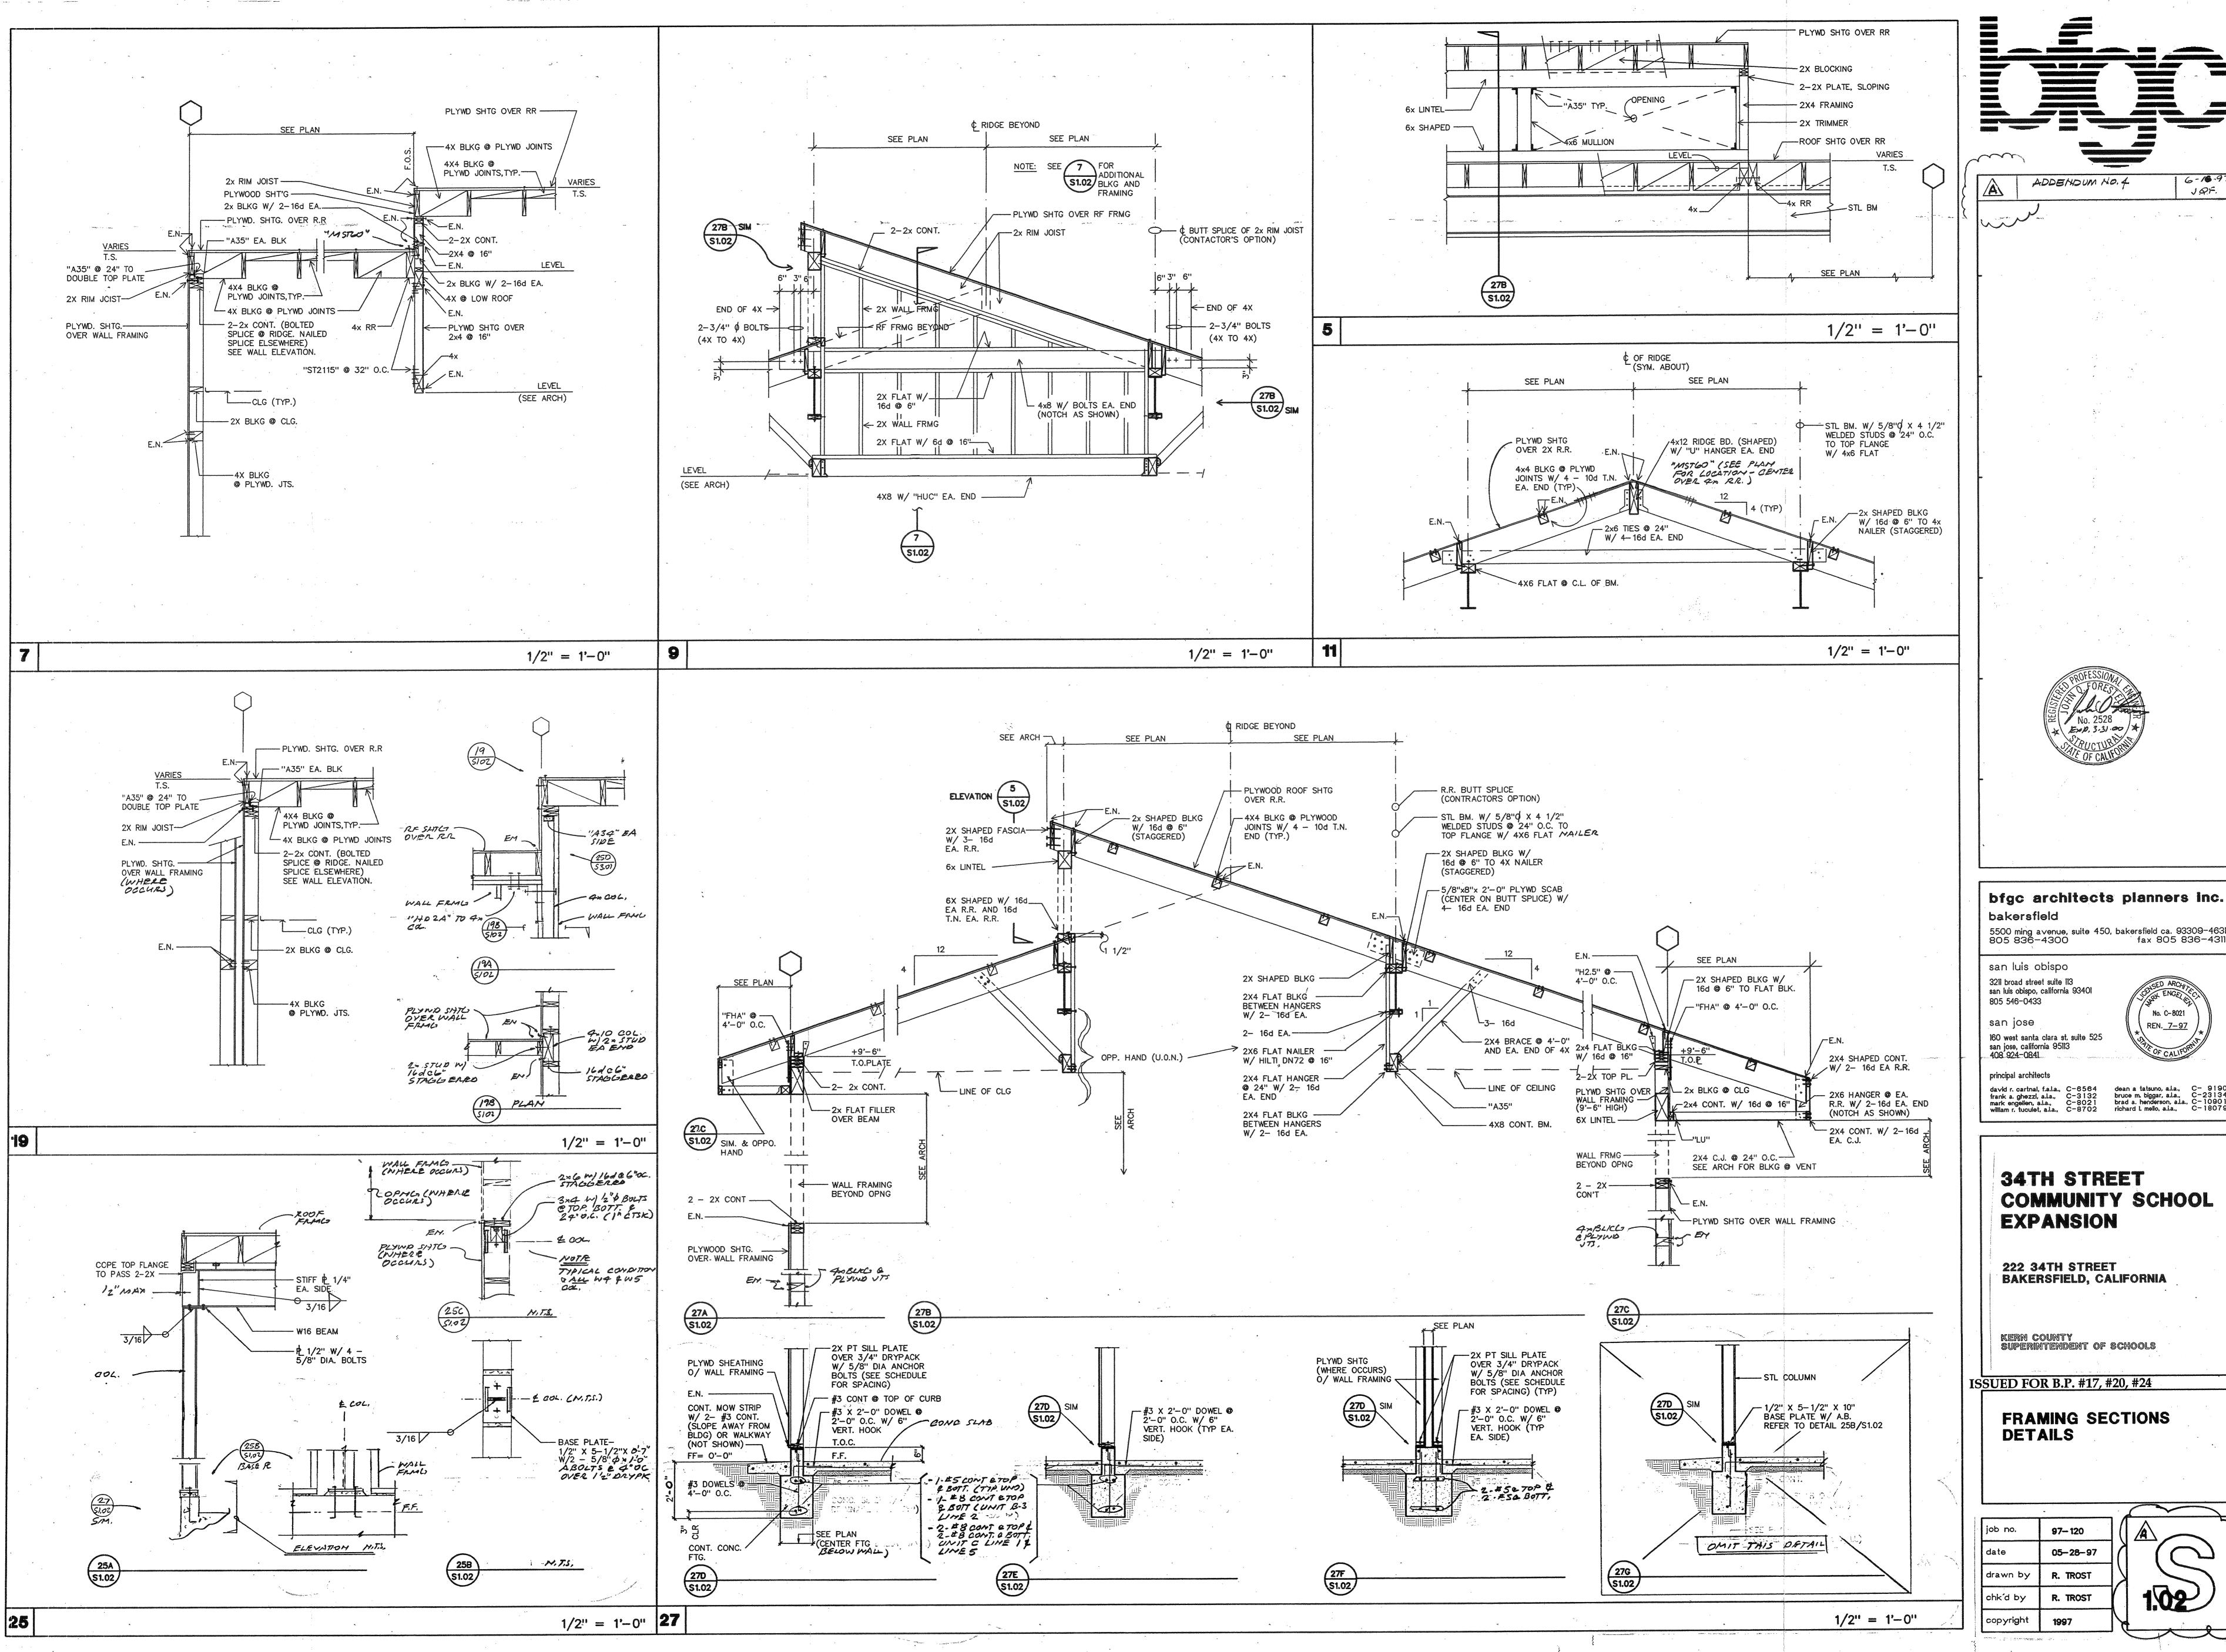

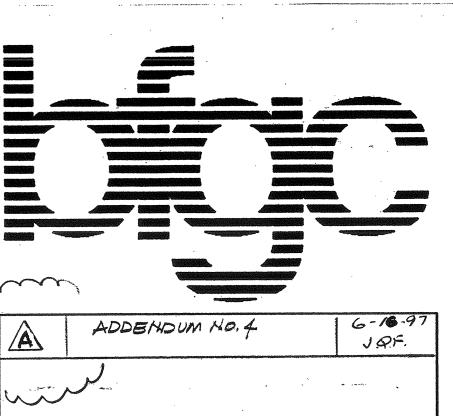

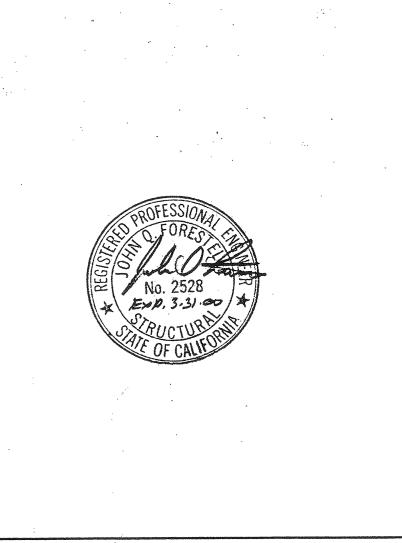

5500 ming avenue, suite 450, bakersfield ca. 93309-4631 805 836-4300 fax 805 836-4311

No. C-8021

REN. 7-97

dean a tatsuno, a.l.a., C- 9190 bruce m. biggar, a.l.a., C-23134 brad a. henderson, a.l.a., C-10901 richard l. mello, a.l.a., C-18079


34TH STREET COMMUNITY SCHOOL **EXPANSION**


222 34TH STREET BAKERSFIELD, CALIFORNIA

KERN COUNTY SUPERINTENDENT OF SCHOOLS

ISSUED FOR B.P. #17, #20, #24


FRAMING SECTIONS

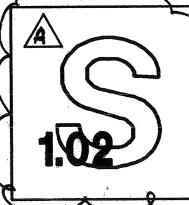

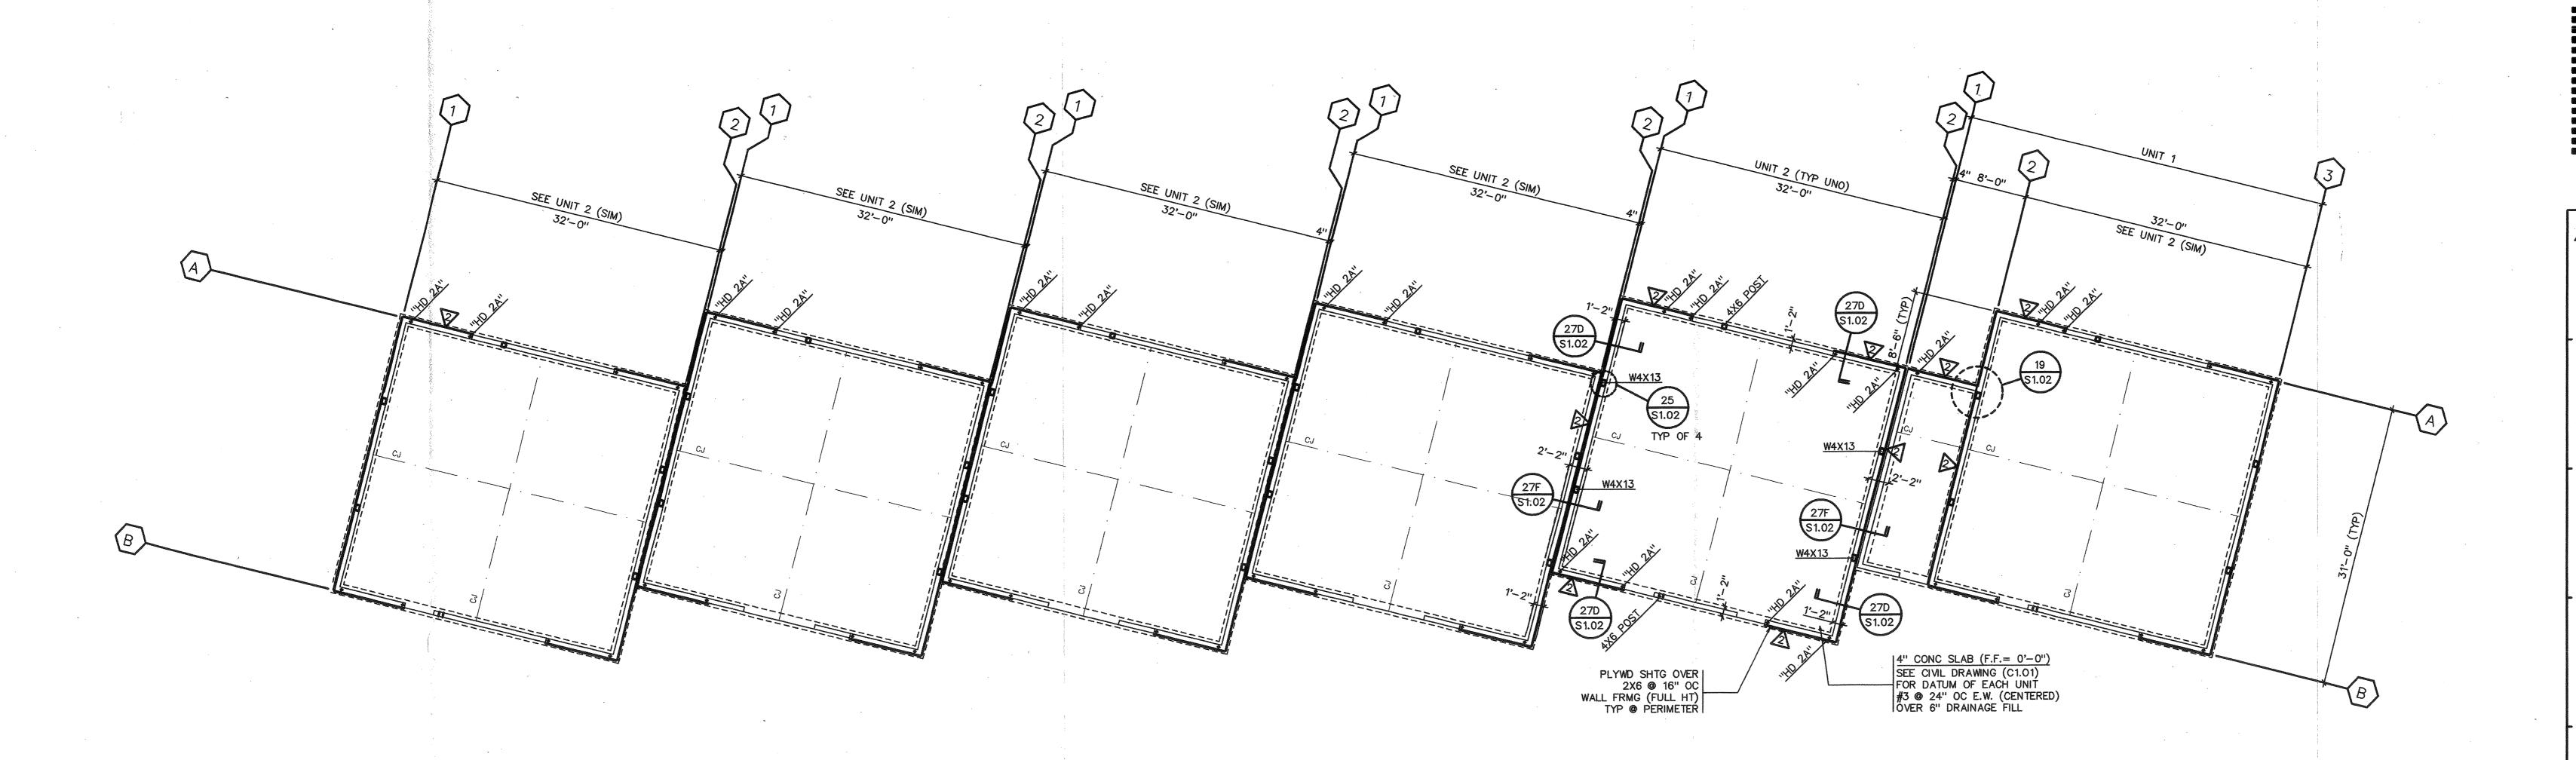


FOUNDATION PLAN

1/8"=1'-0" ≥

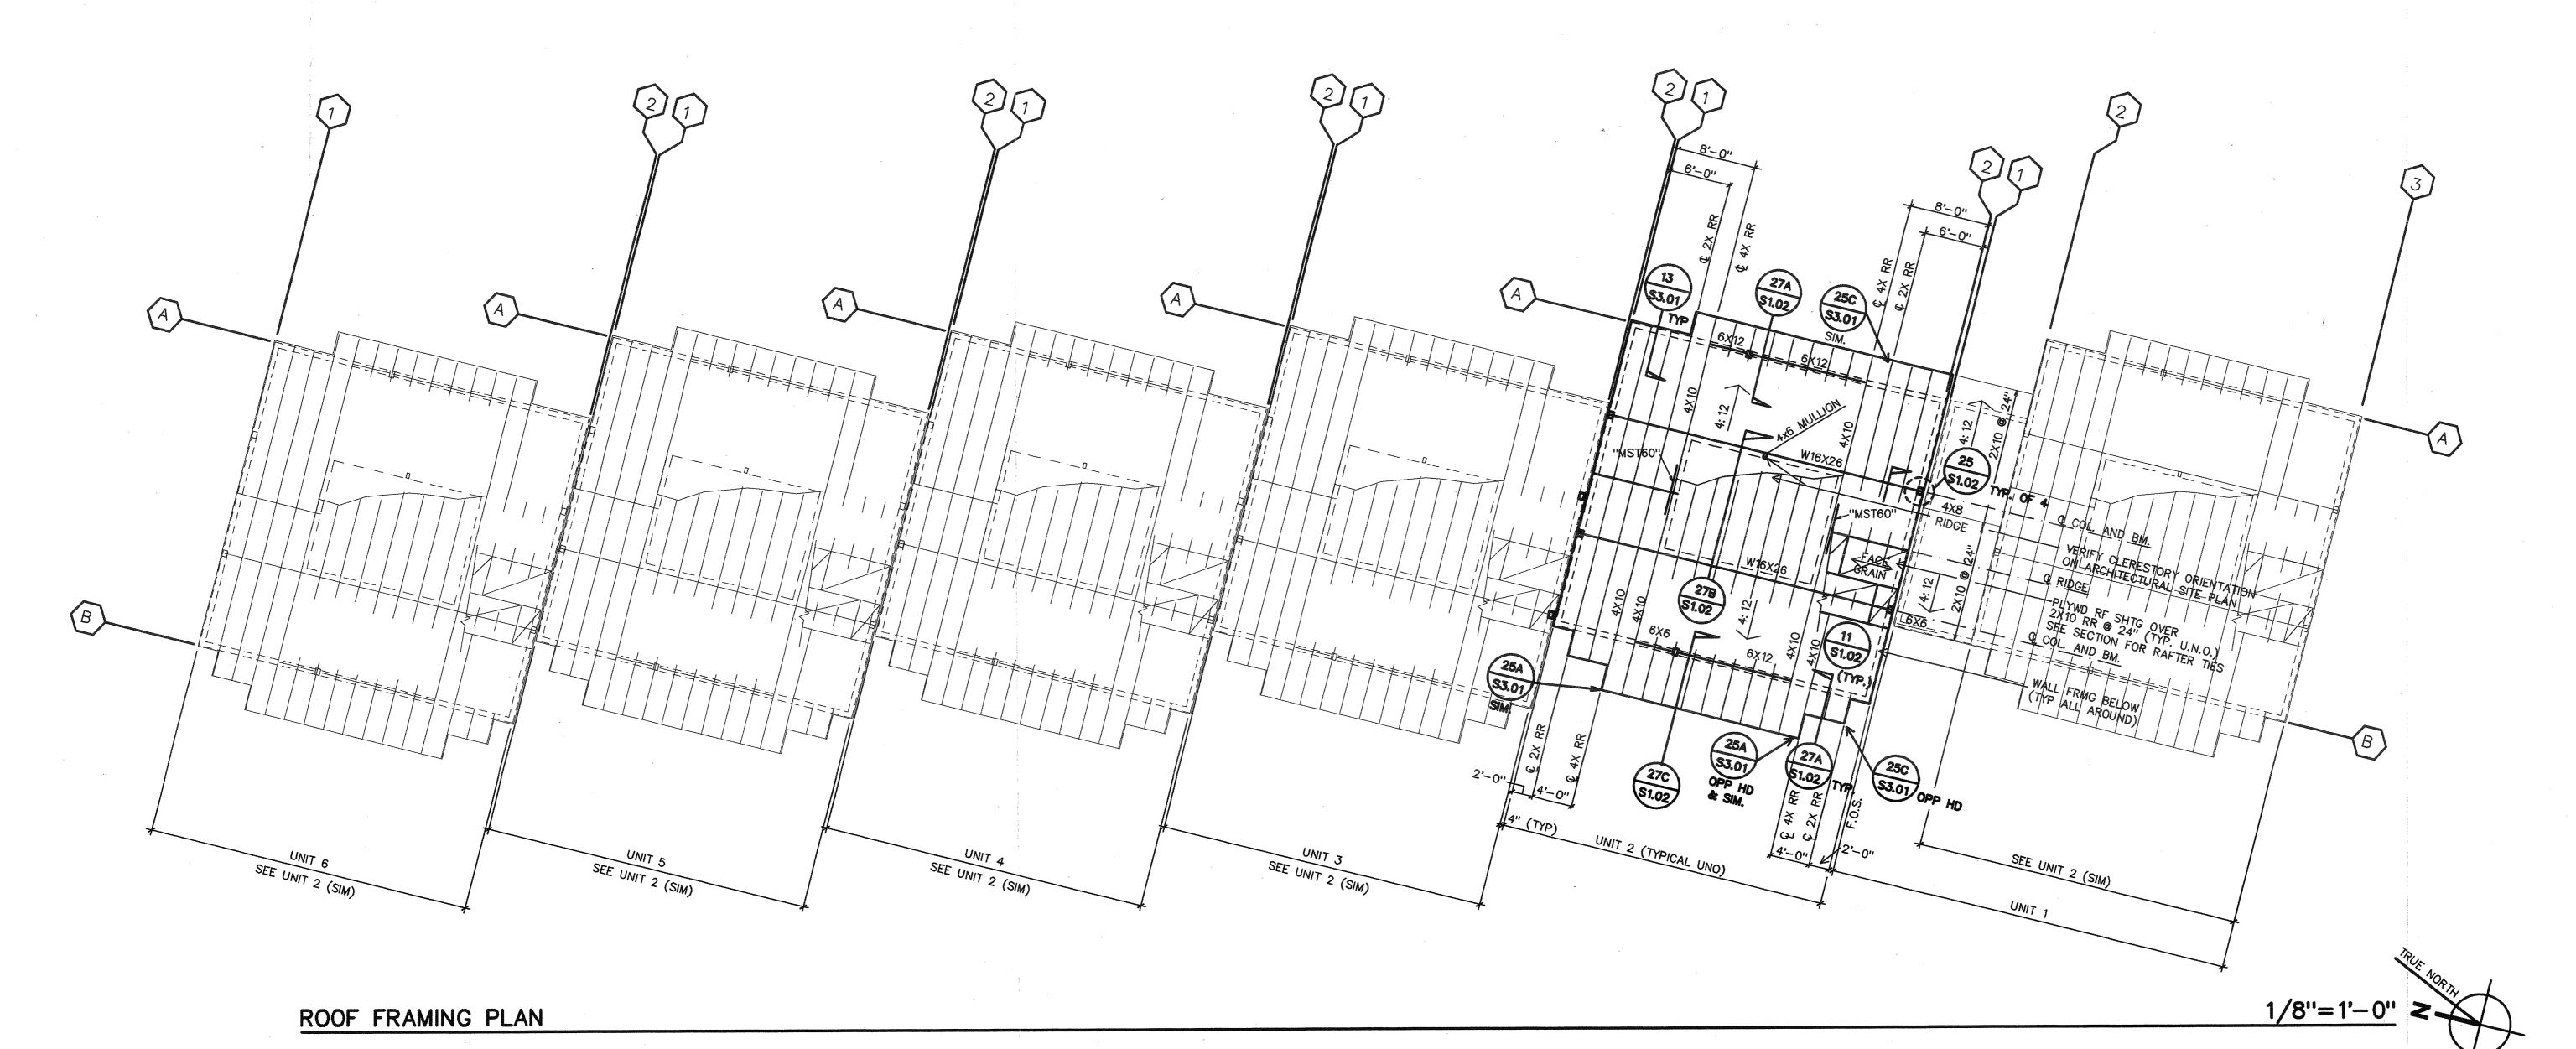

NOTES: 1. SEE SHEET S1.01 FOR GENERAL NOTES & TYPICAL DETAILS.

SEE SITE PLAN (A1.01) FOR ORIENTATION AND DATUM.
 NOTE THAT PLANS MAY BE PARTIALLY OR ENTIRELY
 OPPOSITE HAND FROM THAT SHOWN ON THE STRUCTURAL
 DRAWINGS.

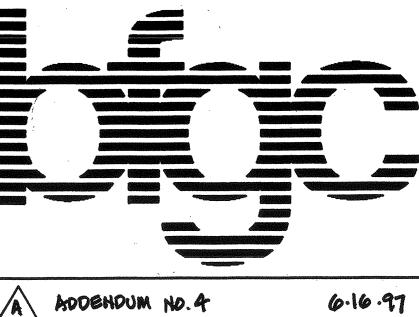

A ADDENDUM NO.4

bfgc architects planners inc. bakersfield

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34TH STREET COMMUNITY SCHOOL **EXPANSION**

222 34TH STREET BAKERSFIELD, CALIFORNIA


Kern County Superintendent of Schools


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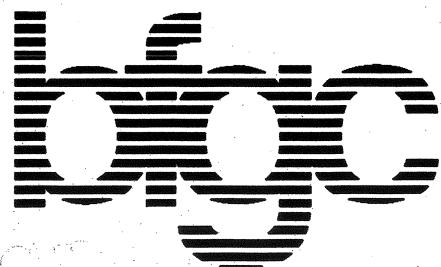
FOUNDATION PLANS ROOF FRAMING PLANS


job no.	97-120
date	05-28-97
drawn by	R. TROST
chk'd by	R. TROST
copyright	1997

PLOT DATE: 6-17-97
PATH\NAME: DRAWING\97-120\7120ST21.dc5



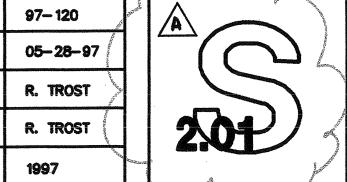

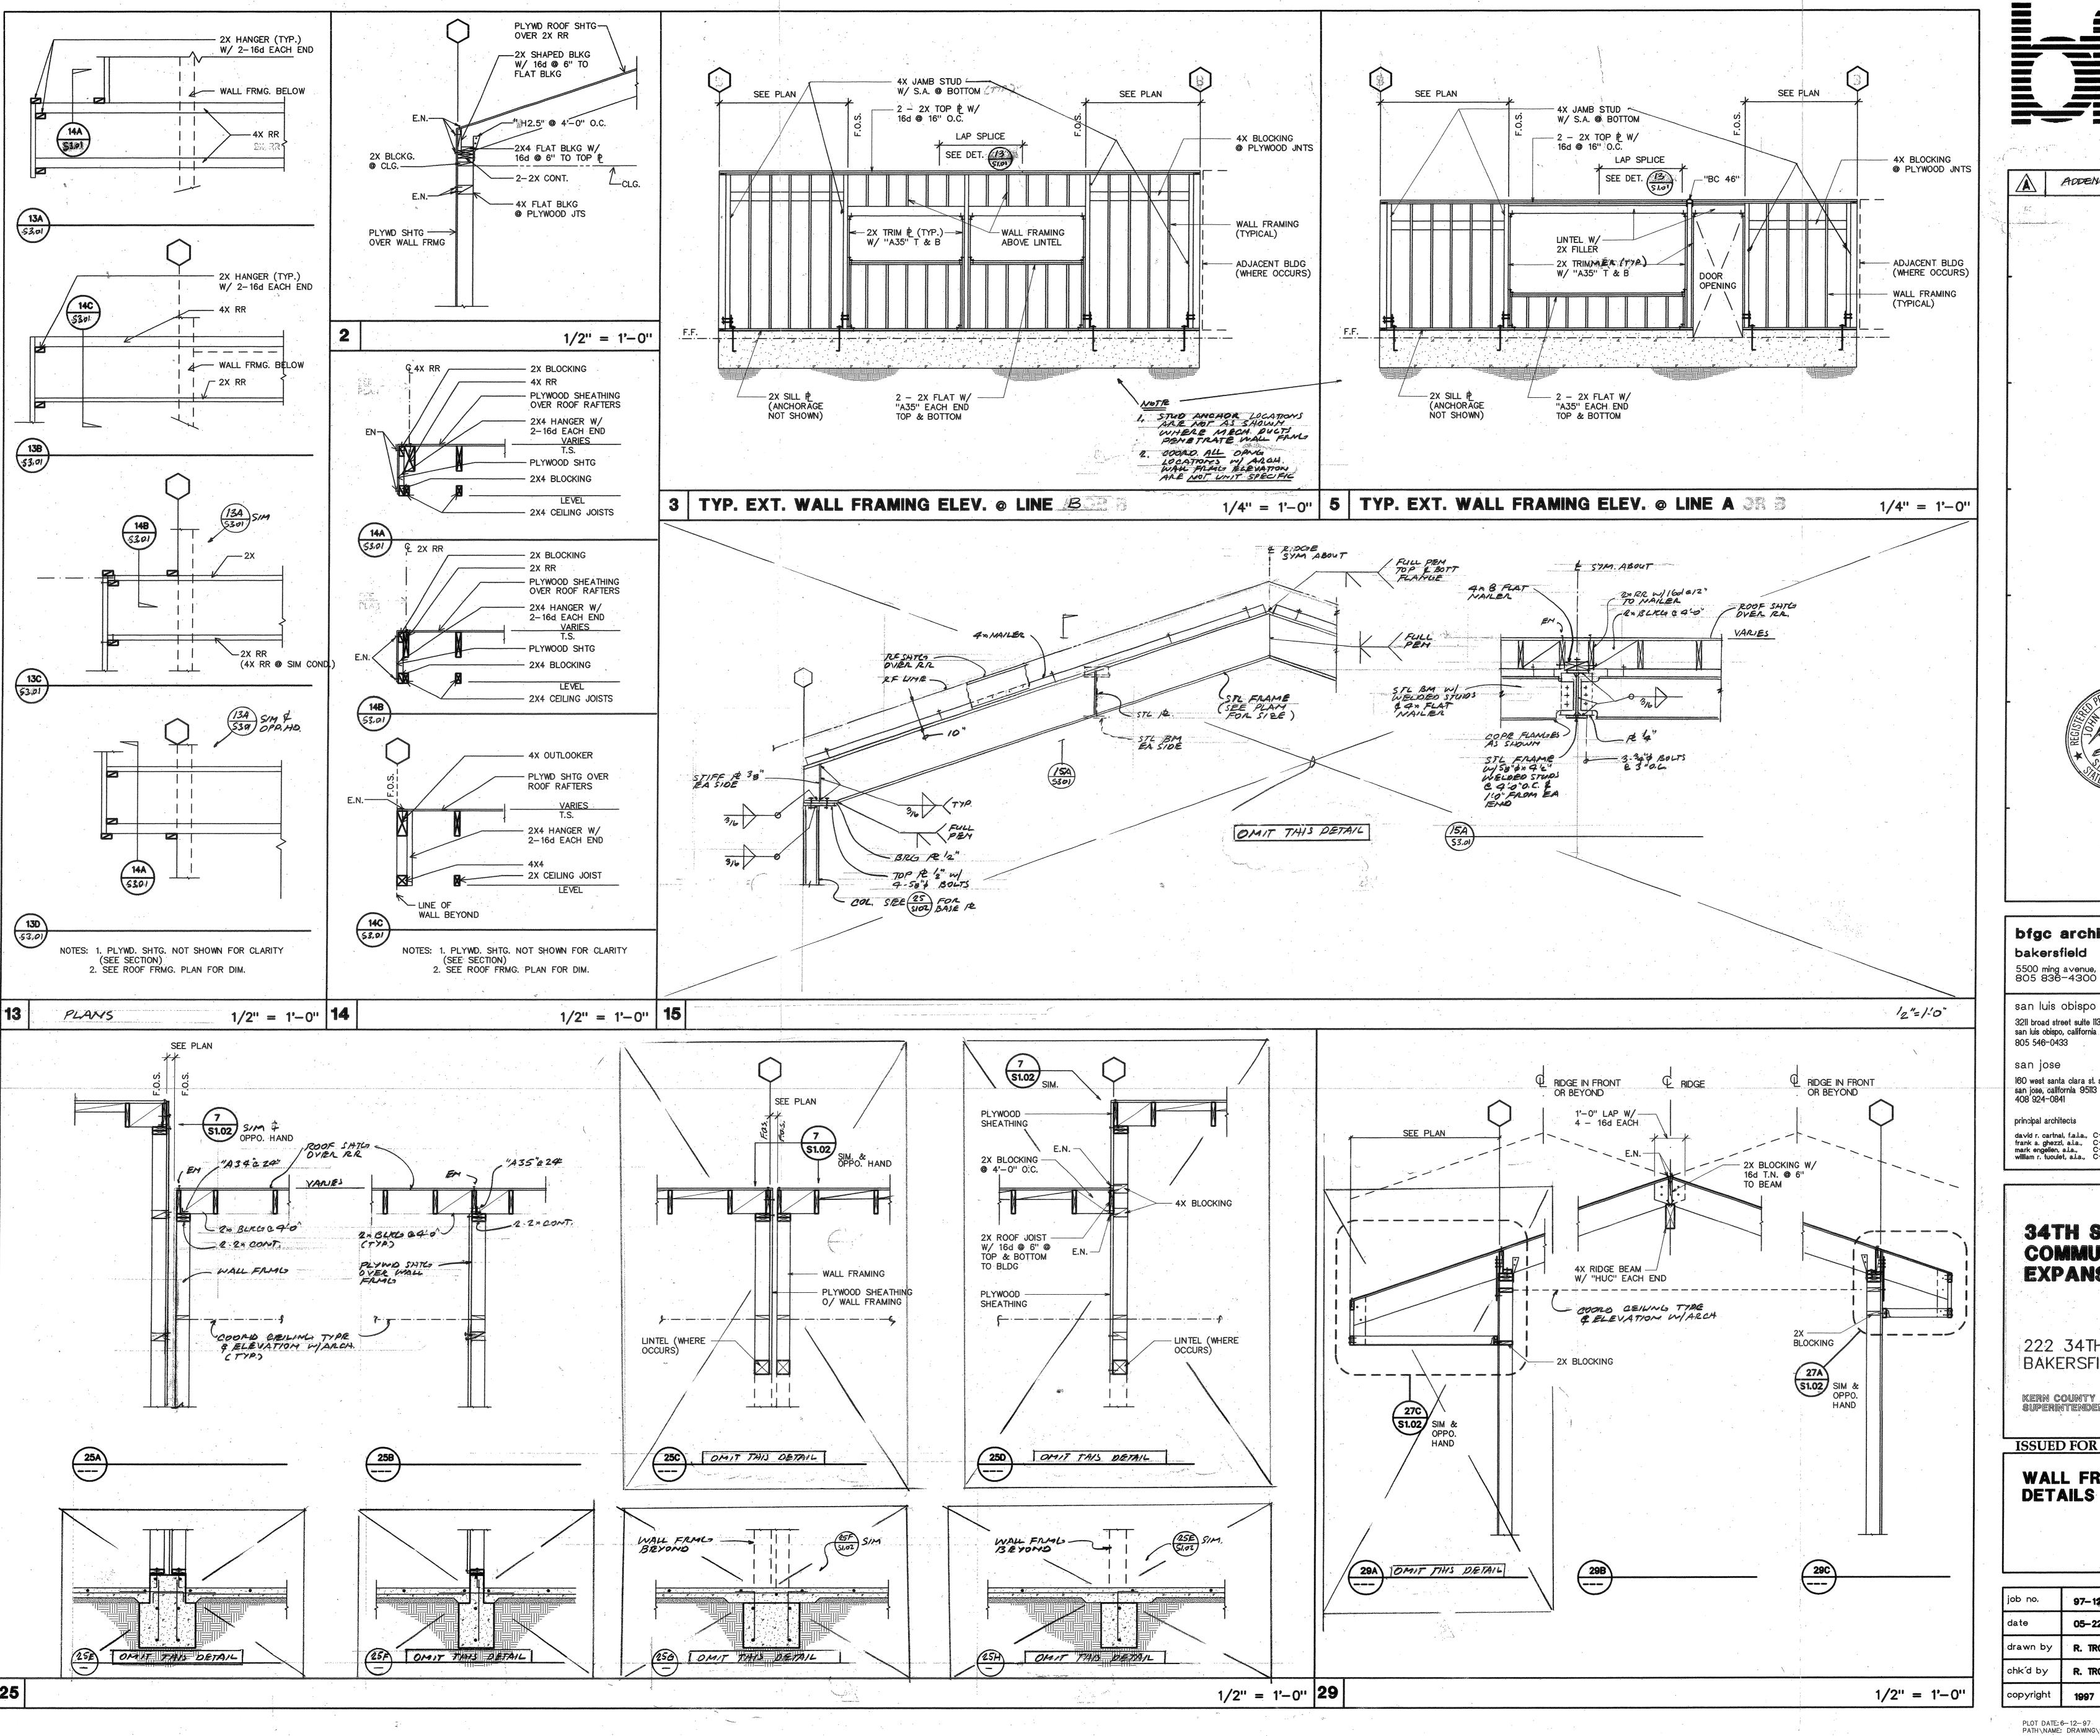

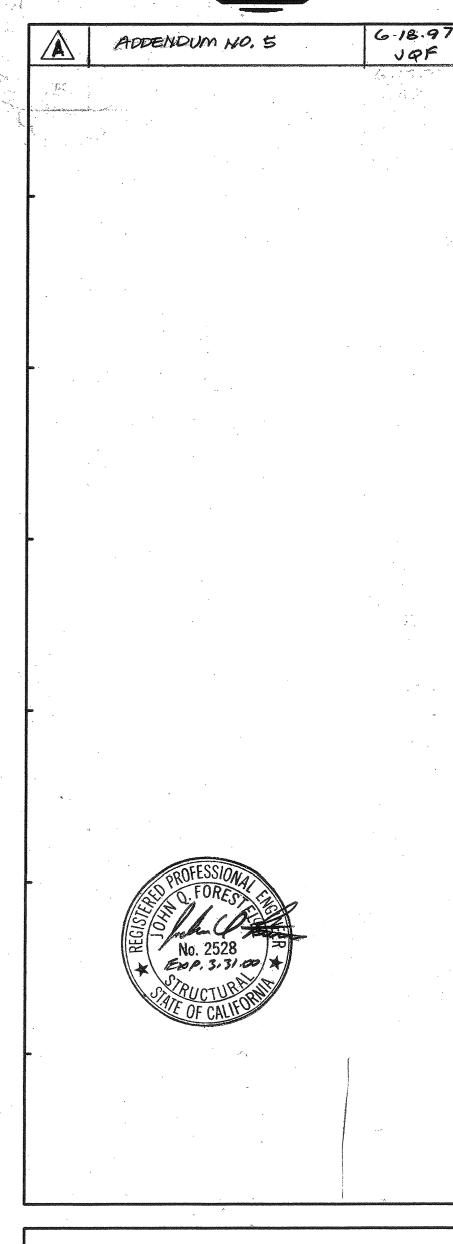

bfgc architects planners inc. bakersfield

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3211 broad street suite 113 san luis obispo, california 93401 805 546-0433

san jose 160 west santa clara st. suite 525 san jose, california 95113 408 924-0841

principal architects david r. cartnal, f.a.l.a., C-6564 frank a. ghezzi, a.l.a., C-3132 mark engelien, a.i.a., C-8021 william r. tuculet, a.l.a., C-8702 dean a tatsuno, a.i.a., C- 9190 bruce m. biggar, a.i.a., C-23134 brad a. henderson, a.i.a., C-10901 richard i. mello, a.i.a., C-18079

34TH STREET COMMUNITY SCHOOL **EXPANSION**

222 34TH STREET BAKERSFIELD, CA

Kern county Superintendent of schools

ISSUED FOR B.P. #17, #20, #24

WALL FRAMING DETAILS

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chk'd by	R. TROST
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