


**1 SITE ELECTRICAL PLAN**  
SCALE: 1"=60'-0"

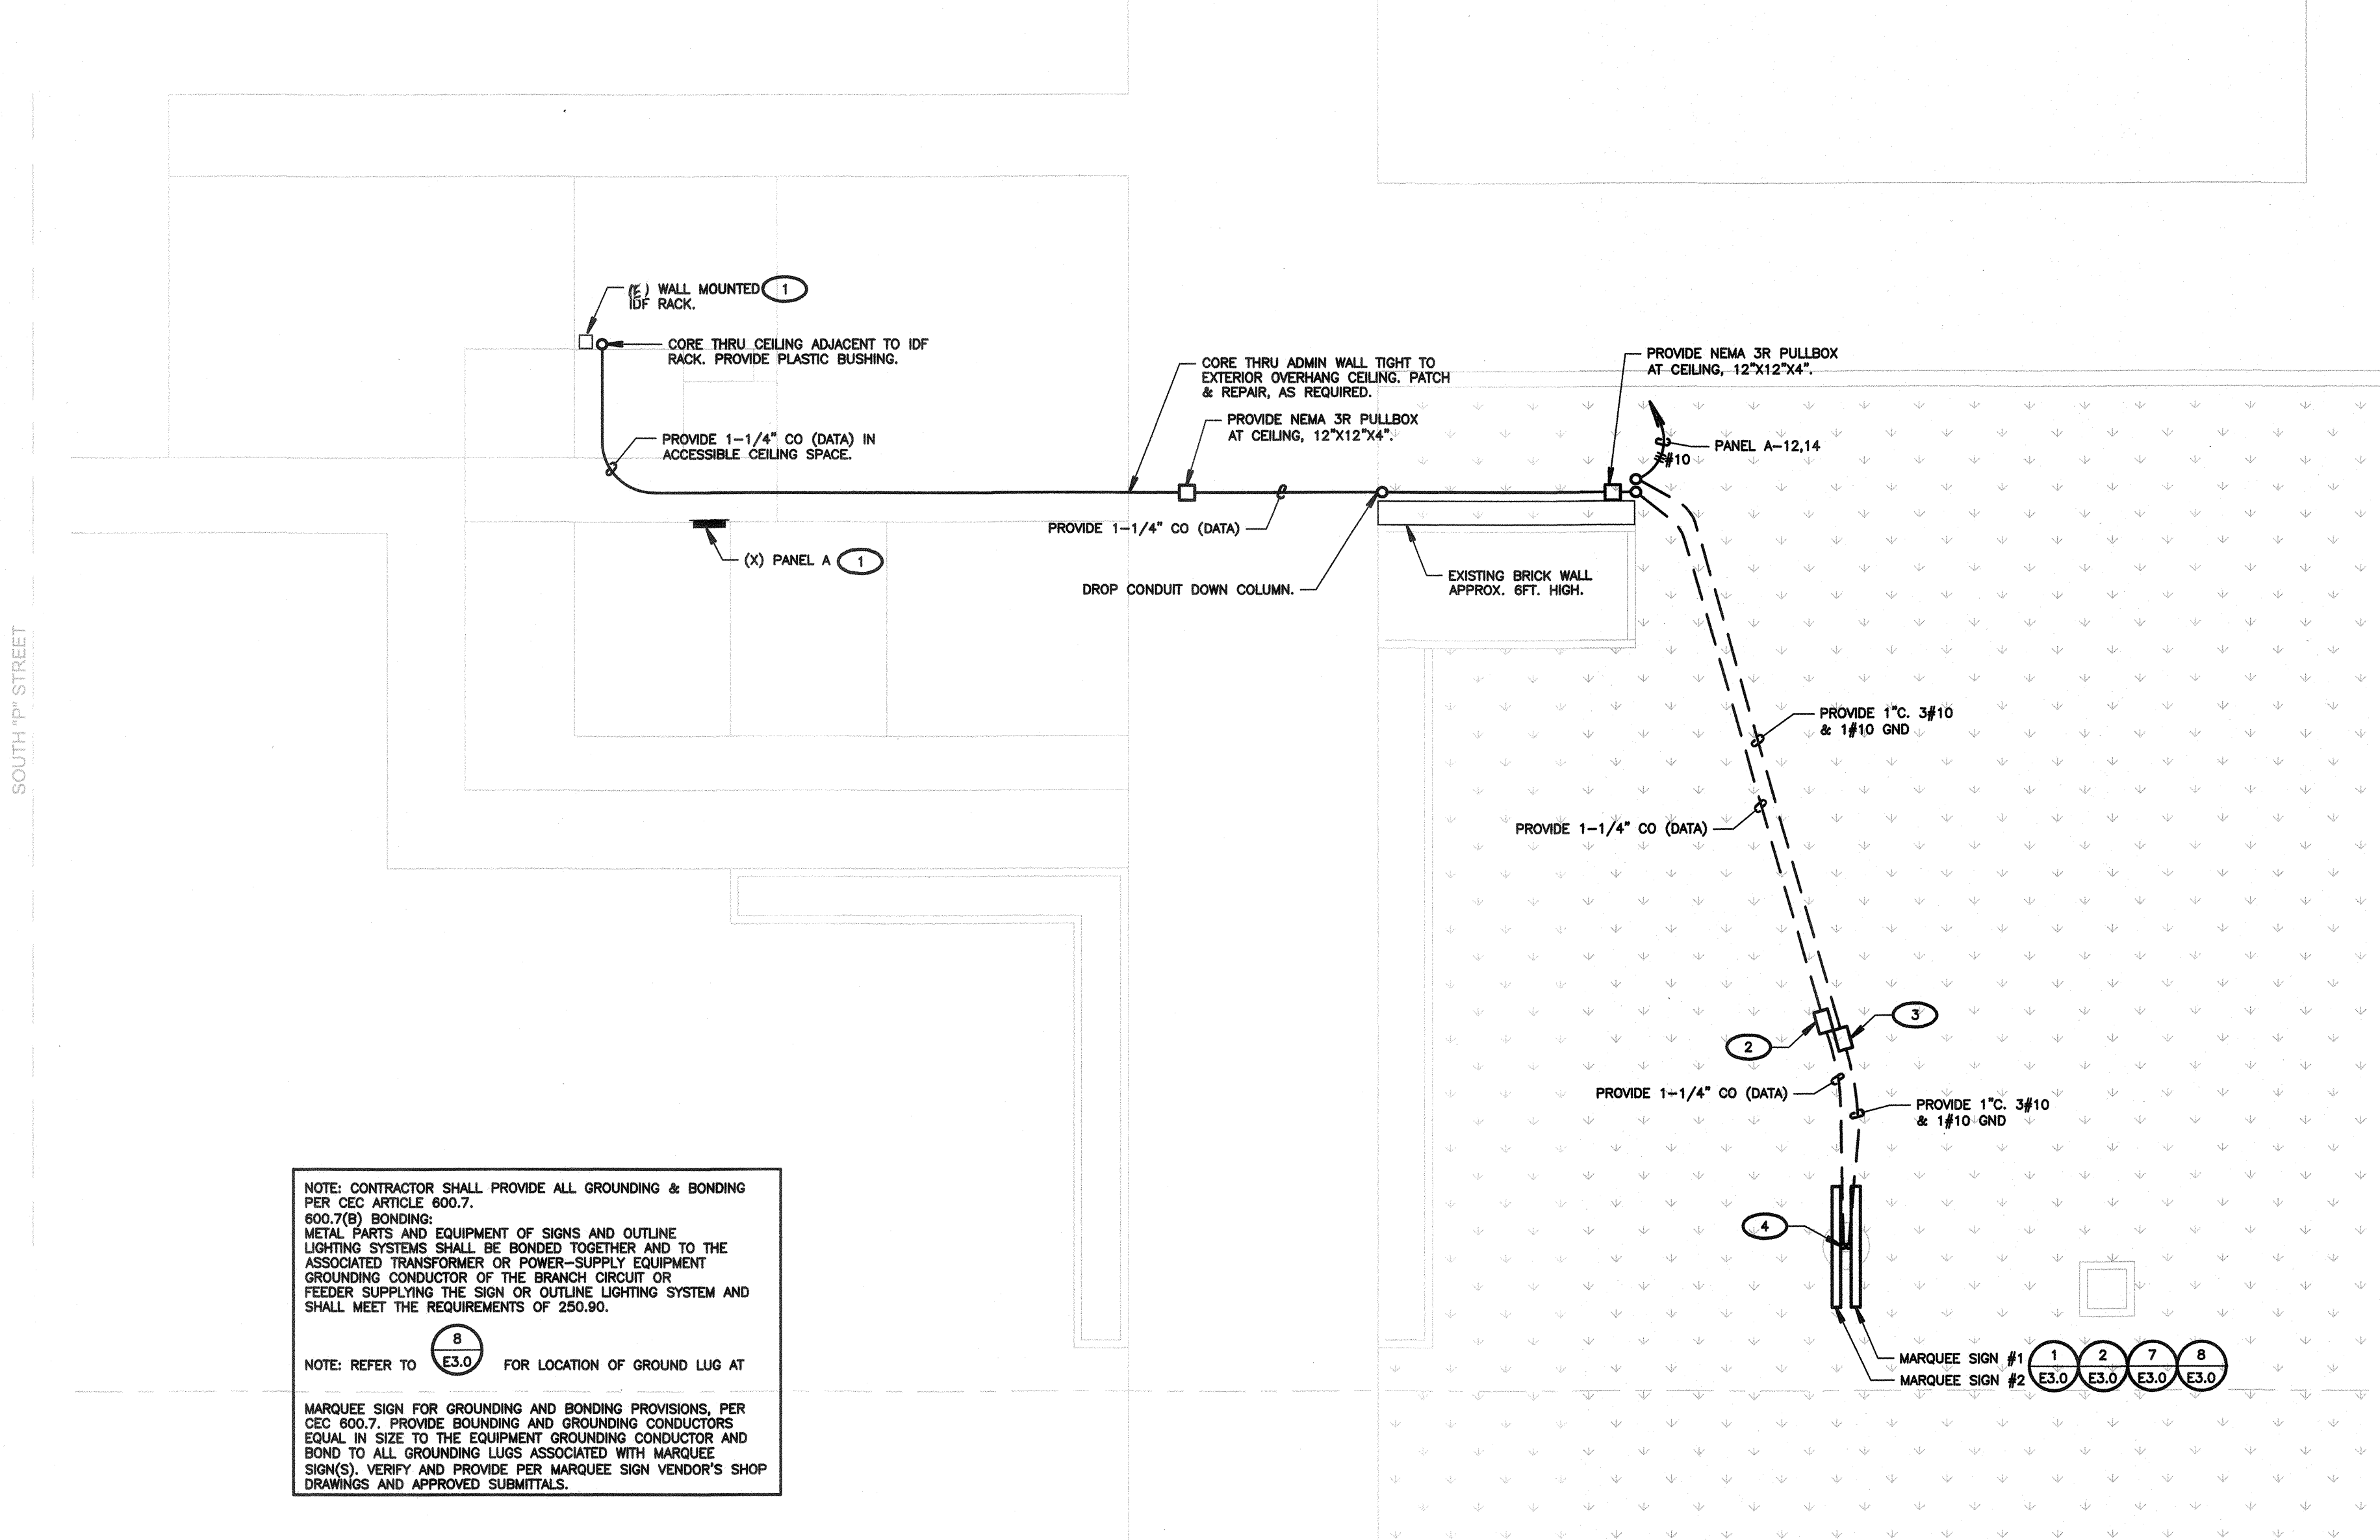

**2 MARQUEE SIGN ELECTRICAL PLAN**  
SCALE: 1/8"=1'-0"

**SHEET NOTES**

- CONTRACTOR SHALL CALL UNDERGROUND SERVICE ALERT AT 811 TO LOCATE UNDERGROUND UTILITIES AT LEAST 2 WORKING DAYS PRIOR TO DIGGING. CONTRACTOR SHALL FIELD VERIFY LOCATION AND DEPTH OF EXISTING IMPROVEMENTS PRIOR TO START OF CONSTRUCTION.
- VERIFY LOCATION OF ALL BUILDINGS AND APPENDICES ON ARCHITECTURAL AND CIVIL PLANS.
- FIELD VERIFY LOCATION ON ALL UNDERGROUND UTILITIES PRIOR TO TRENCHING. SCHEDULE AND COORDINATE ALL SITE WORK WITH OWNER PRIOR TO ANY TRENCHING.
- CONTRACTOR SHALL VERIFY LOCATION & REQUIREMENTS OF ALL DEVICES/EQUIPMENT REQUIRING ELECTRICAL CONNECTION PRIOR TO BID PROPOSAL, ROUGH-IN, AND FINISH.
- CONTRACTOR SHALL, IN ROUTING ALL CIRCUITS, INCREASE CONDUIT SIZE TO ALLOW FOR VOLTAGE DROP SHOULD THE CONTRACTOR EXCEED ROUTING INDICATED ON DRAWINGS. ENGINEER OF RECORD MUST BE NOTIFIED PRIOR TO ANY DEVIATIONS FROM APPROVED PLAN CHECK (PERMIT SET) DRAWINGS.
- ALL 90 DEGREE CONDUIT BENDS AND RISERS SHALL BE PVC COATED RIGID STEEL.
- CONTRACTOR SHALL COORDINATE AND PROVIDE ALL SITE ELECTRICAL SERVICE REQUIREMENTS WITH SERVING UTILITY.
- ALL SERVICE ENTRANCE EQUIPMENT SHOP DRAWINGS SHALL BE SUBMITTED TO THE LOCAL UTILITY COMPANY FOR APPROVAL, WITH WRITTEN APPROVAL RECEIVED PRIOR TO SUBMISSION TO ELECTRICAL ENGINEER FOR APPROVAL.
- VERIFY LOCATION OF ALL EQUIPMENT ON ARCHITECTURAL AND CIVIL PLANS.
- MINIMUM CONDUIT BURIAL DEPTH IS 24", 36" MINIMUM BELOW STREETS AND PARKING LOTS. FOR 0-600 VOLT SYSTEMS.
- PROVIDE CODE SIZED EQUIPMENT GROUNDING CONDUCTORS IN ALL OCCUPIED CONDUITS.
- 1" CONDUIT MINIMUM UNDERGROUND.
- COORDINATE WORK WITH OTHER TRADES. OBTAIN ALL DRAWINGS THAT WILL REQUIRE COORDINATION AND PROVIDE ALL ELECTRICAL CONNECTIONS, DEVICES, AND WIRING REQUIRED, WHETHER SHOWN ON THE ELECTRICAL DRAWINGS OR NOT.
- CONTRACTOR SHALL FURNISH AND INSTALL PULL BOXES AS REQUIRED TO INSTALL CONDUCTORS PER CONDUCTOR MANUFACTURERS RECOMMENDATIONS, PER THE NATIONAL ELECTRICAL CODE, AND PER LOCAL AUTHORITIES HAVING JURISDICTION.
- FIELD CONDITIONS GOVERN DEMOLITION AND NEW CONSTRUCTION. CONTRACTOR SHALL VERIFY ACTUAL CONDITIONS PRIOR TO START OF WORK. THE ARCHITECT/ENGINEER SHALL BE NOTIFIED OF POSSIBLE FIELD PROBLEMS PRIOR TO DEMOLITION. CONTRACTOR SHALL NOTIFY DISTRICT REPRESENTATIVE OF WORK BEING PERFORMED. COORDINATE WITH DISTRICT REPRESENTATIVE.
- ALL EMPTY CONDUITS SHALL BE PROVIDED WITH DIMENSIONED NYLON PULL STRING.
- CONTRACTOR SHALL FIELD VERIFY LOCATION OF ALL UNDERGROUND UTILITIES PRIOR TO ANY EXCAVATION OR TRENCHING. CONTRACTOR SHALL PROTECT ALL EXISTING/REMAINING UTILITIES IN PLACE. CONTRACTOR, AT HIS SOLE EXPENSE, SHALL REPAIR ANY UTILITY SYSTEMS DAMAGED DURING CONSTRUCTION.

**KEY NOTES**


- (NOTE: THESE NOTES MAY NOT APPEAR ON ALL SHEETS)
- APPROXIMATE LOCATION. CONTRACTOR SHALL FIELD VERIFY EXACT LOCATION.
  - PROVIDE COMMUNICATIONS PULLBOX. PROVIDE 11"x17" TRAFFIC RATED PULLBOX WITH STEEL CHECKER PLATE COVER ENGRAVED WITH "COMMUNICATIONS". #B1017BOX WITH #B1017-51JH COVER, BY CHRISTY CONCRETE.
  - PROVIDE POWER PULLBOX. PROVIDE 11"x17" TRAFFIC RATED PULLBOX WITH STEEL CHECKER PLATE COVER ENGRAVED WITH "ELECTRIC". #B1017BOX WITH #B1017-51JH COVER, BY CHRISTY CONCRETE.
  - COMMUNICATIONS CABLES SHALL BE PROVIDED IN SEPARATE RACEWAY WITHIN METAL POLE. PROVIDE 1-1/4" LIQUID TITE FLEXIBLE NONMETALLIC CONDUIT FOR COMMUNICATIONS CABLES. VERIFY & PROVIDE PER MARQUEE SIGN VENDOR'S SHOP DRAWINGS & APPROVED SUBMITTALS.

NOTE: CONTRACTOR SHALL PROVIDE ALL GROUNDING & BONDING PER CEC ARTICLE 600.7, 600.7(B) BONDING. METAL PARTS AND EQUIPMENT OF SIGNS AND OUTLINE LIGHTING SYSTEMS SHALL BE BONDED TOGETHER AND TO THE ASSOCIATED TRANSFORMER OR POWER-SUPPLY EQUIPMENT GROUNDING CONDUCTOR OF THE BRANCH CIRCUIT OR FEEDER SUPPLYING THE SIGN OR OUTLINE LIGHTING SYSTEM AND SHALL MEET THE REQUIREMENTS OF 250.80.

NOTE: REFER TO **E3.0** FOR LOCATION OF GROUND LUG AT MARQUEE SIGN FOR GROUNDING AND BONDING PROVISIONS, PER CEC 600.7. PROVIDE BONDING AND GROUNDING CONDUCTORS EQUAL IN SIZE TO THE EQUIPMENT GROUNDING CONDUCTOR AND BOND TO ALL GROUNDING LUGS ASSOCIATED WITH MARQUEE SIGN(S). VERIFY AND PROVIDE PER MARQUEE SIGN VENDOR'S SHOP DRAWINGS AND APPROVED SUBMITTALS.

NOTE: CONTRACTOR SHALL PROVIDE ALL REQUIRED LOW VOLTAGE CABLING TO MARQUEE SIGN. VERIFY & PROVIDE PER MARQUEE SIGN SHOP DRAWINGS & APPROVED SUBMITTALS.

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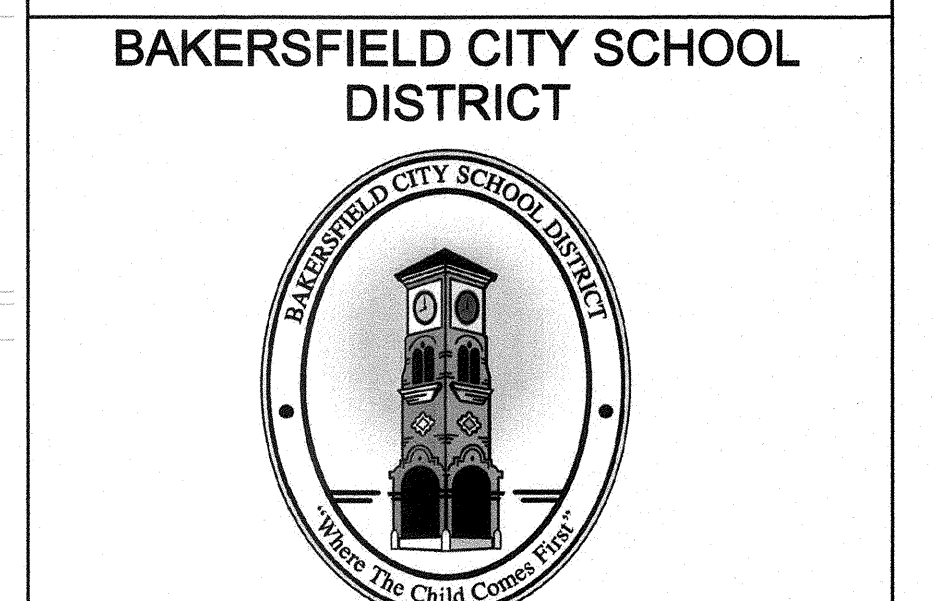

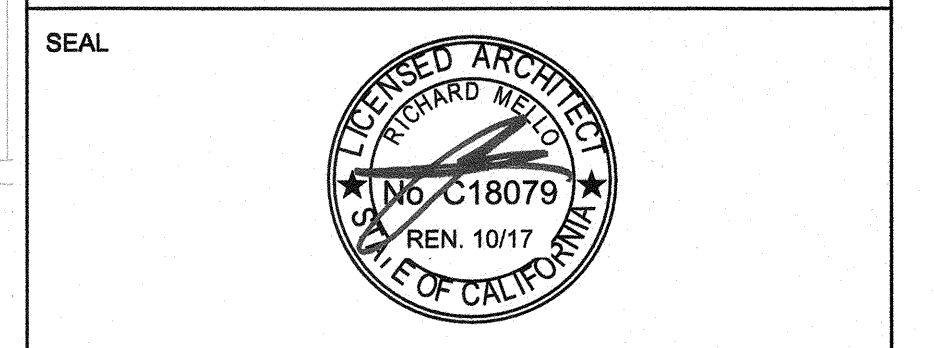
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AGENCY INFORMATION:  
AGENCY TRACKING NO. 63321-273  
FILE NO. 15-6  
IDENTIFICATION STAMP  
DIV. OF THE STATE ARCHITECT  
OFFICE OF REGULATION SERVICES  
**03-118201**  
AC *FLS* *SS* *CL*  
DATE **OCT 25 2017**



**WAYSIDE E.S. - MARQUEE SIGN**

1000 MING AVE., BAKERSFIELD, CA 93307  
OPSC or OSHPD PROJ. NO.:  
PROJECT NO.:  
DRAWN BY: VZ  
CHKD BY: DF  
ISSUE DATE: 10/19/2017  
SHEET TITLE

**SITE ELECTRICAL PLAN**

SHEET NUMBER  
**E2.0**



Know what's below.  
Call before you dig.

CONSTRUCTION DOCUMENTS