




① FRONT ELEVATION

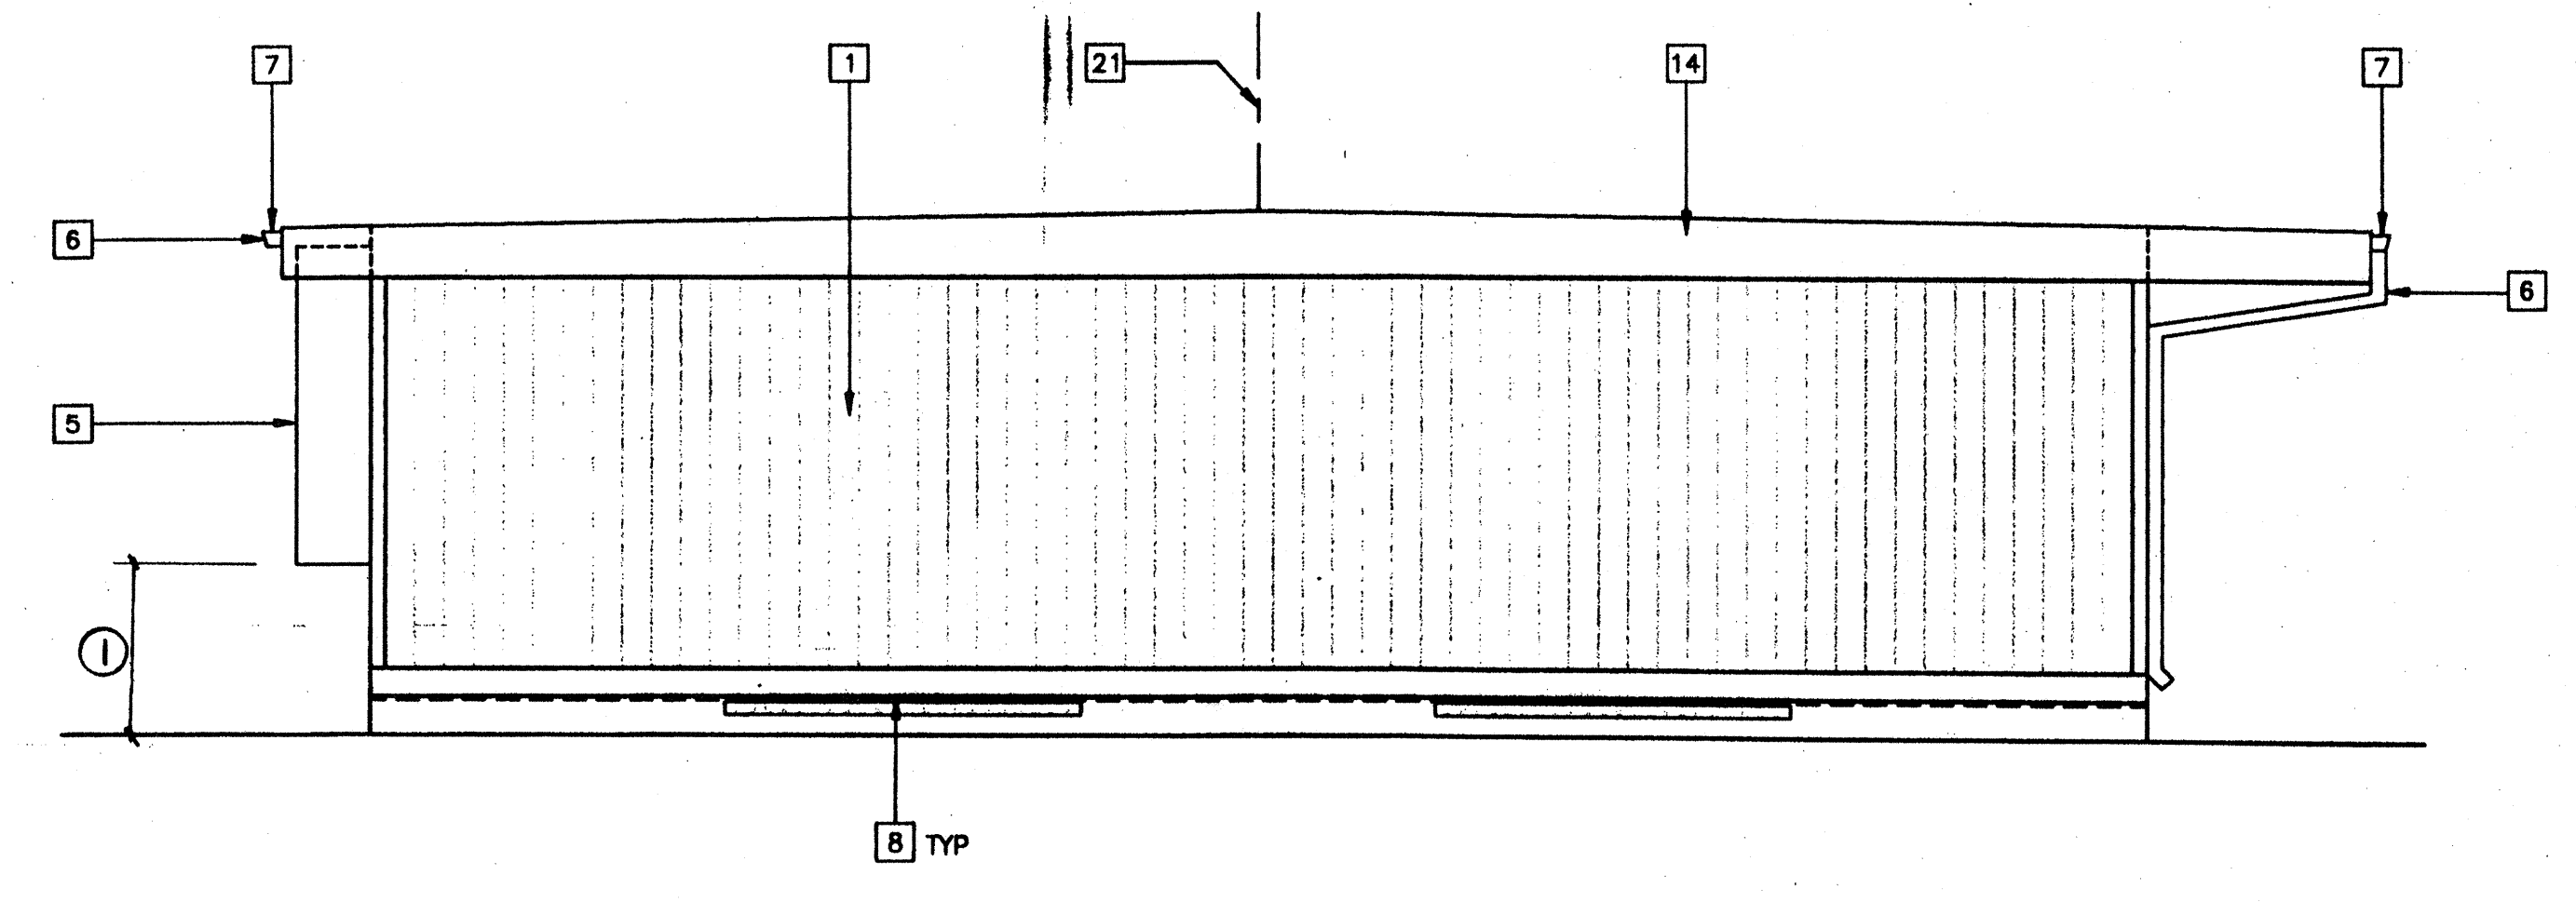

② LEFT SIDE ELEVATION

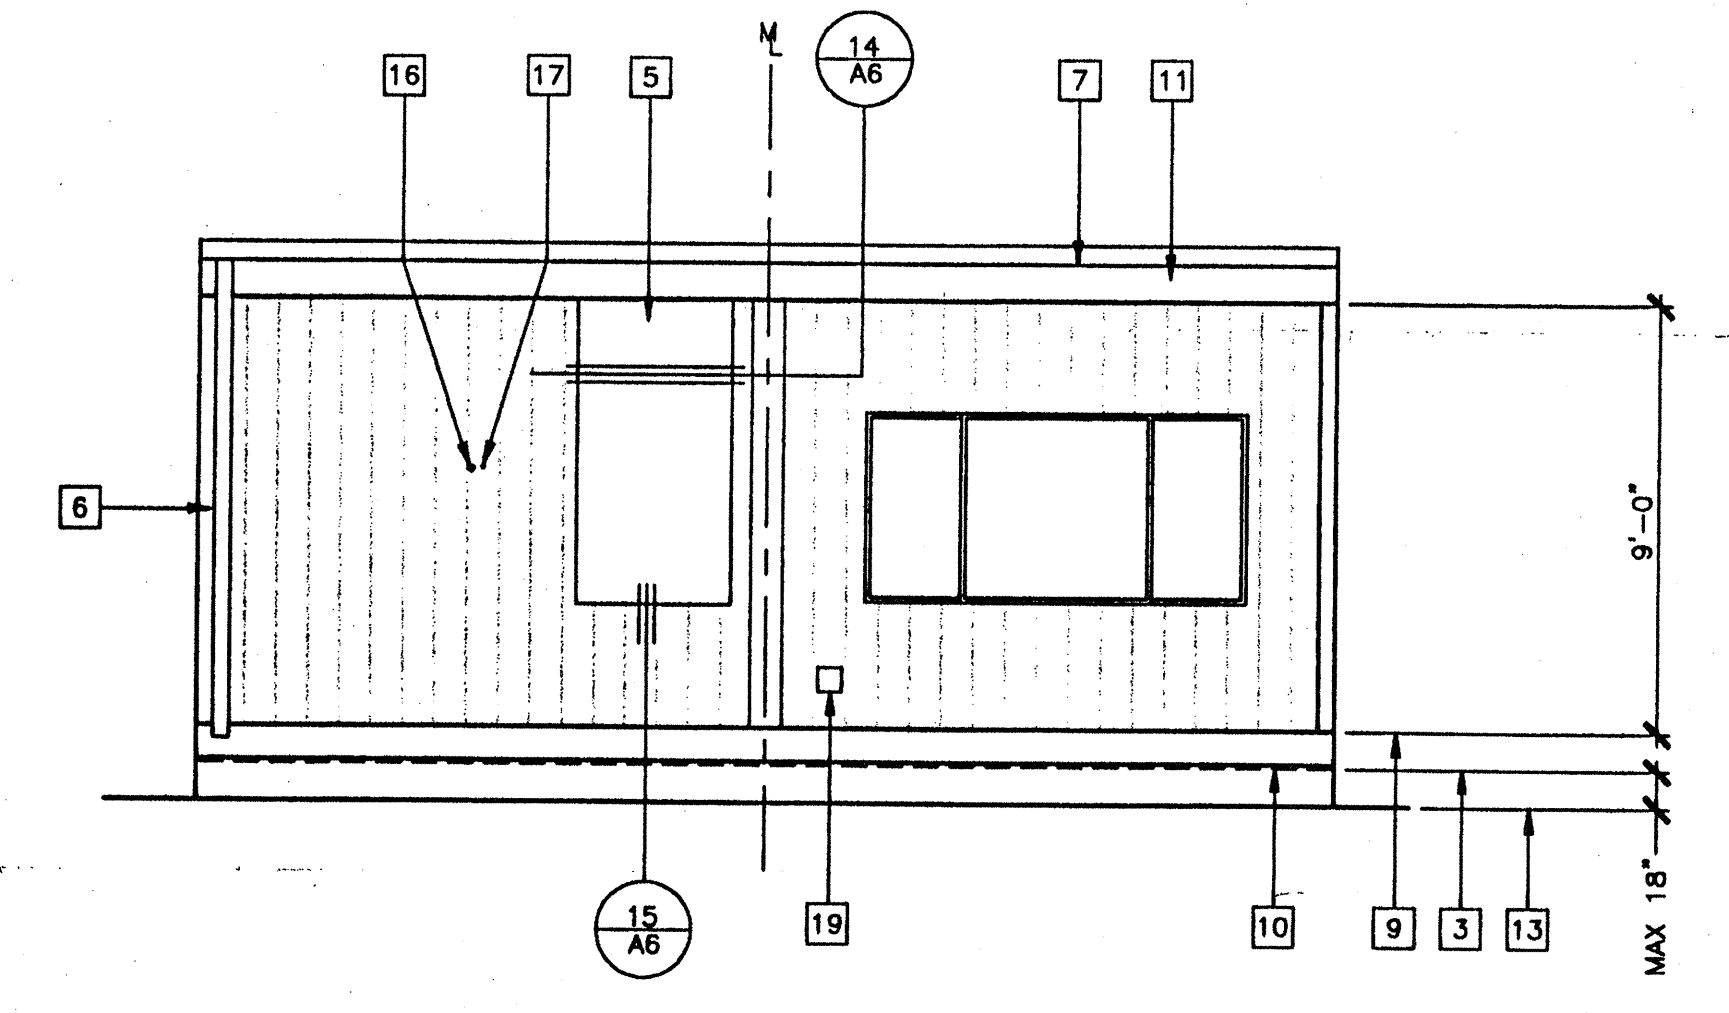

③ REAR ELEVATION

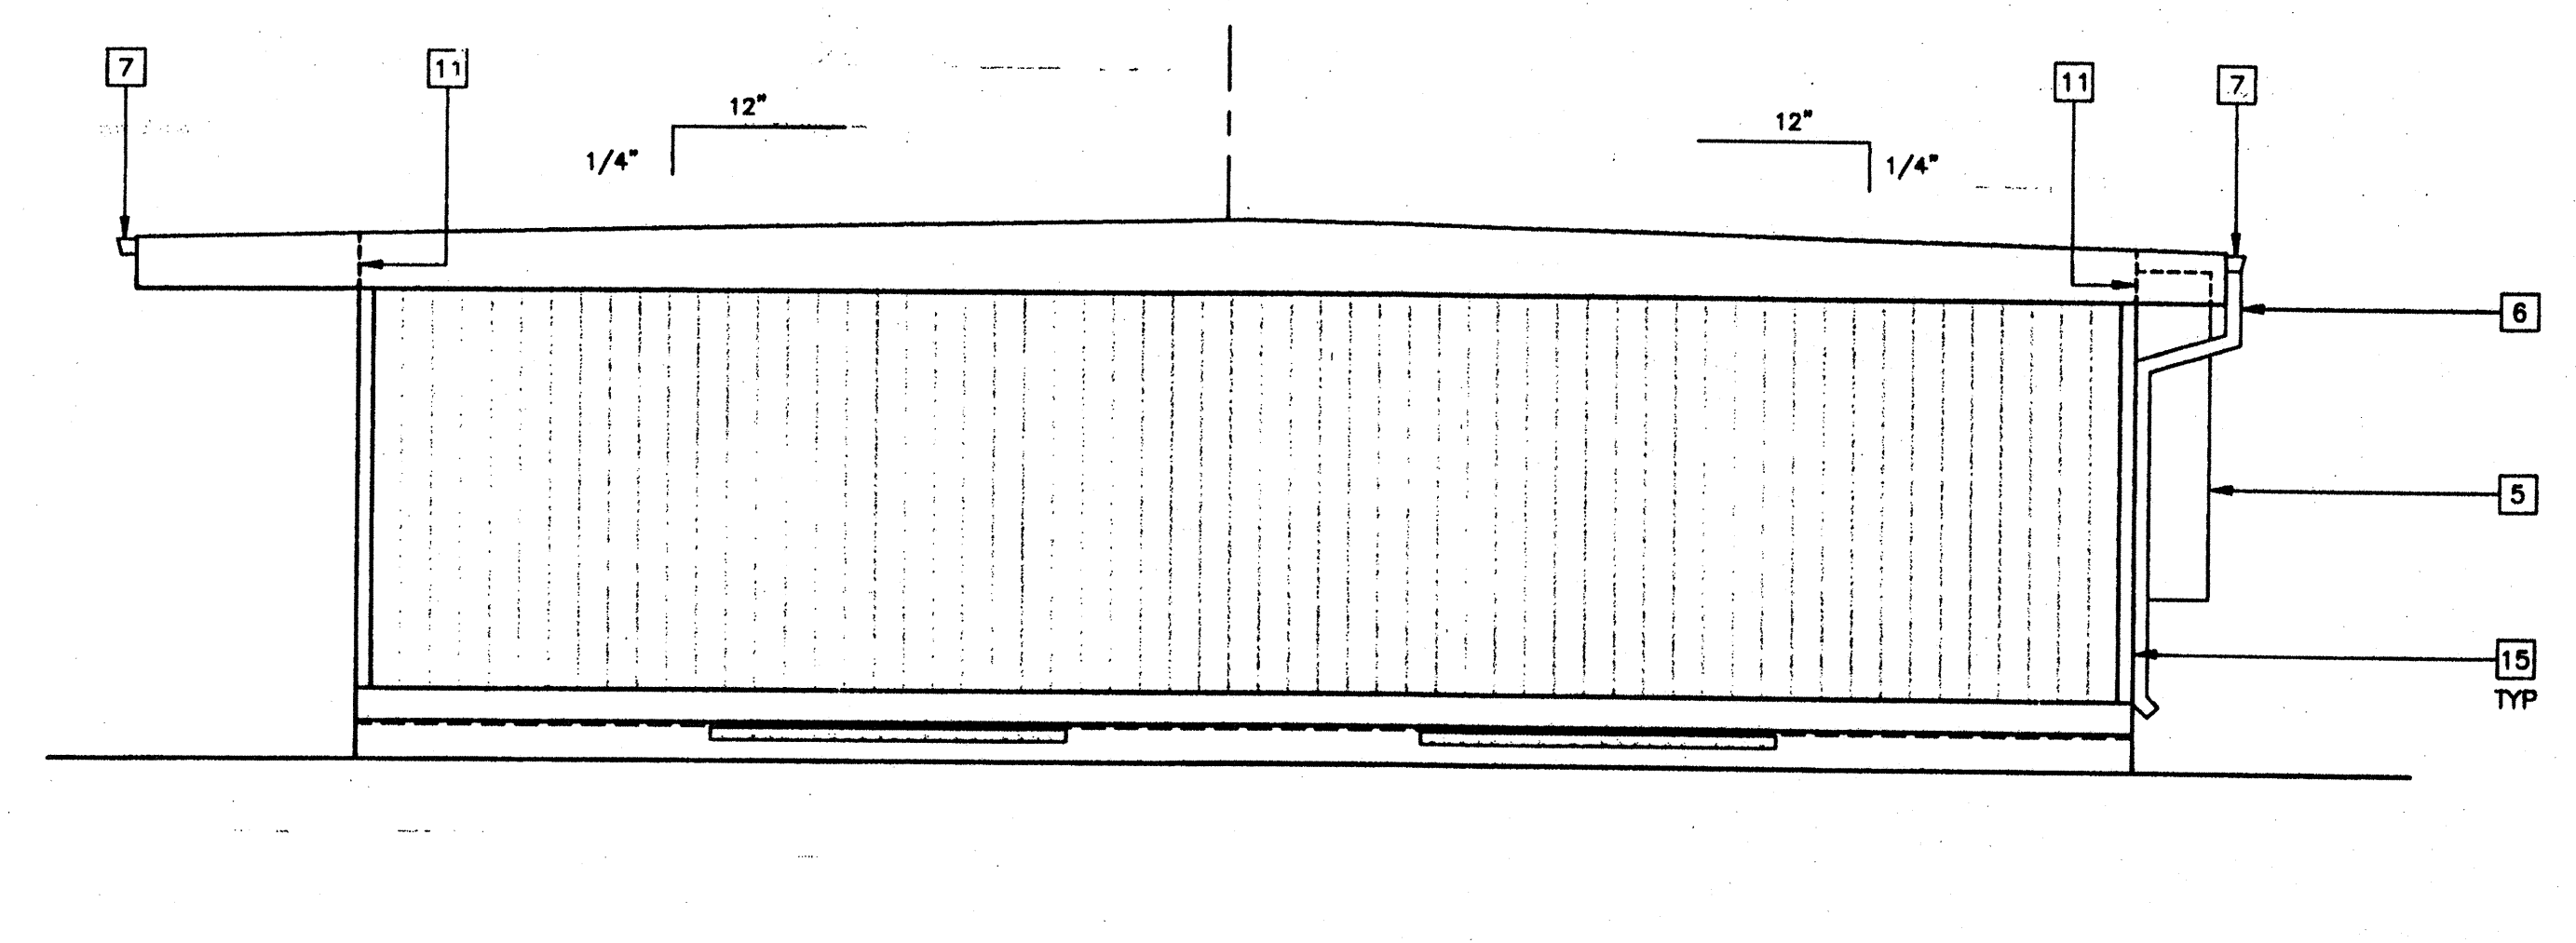

④ RIGHT SIDE ELEVATION

### KEY NOTES

- 1 TYPICAL EXTERIOR FINISH SEE EXTERIOR FINISH SCHEDULE BELOW.
- 2 EXTERIOR LIGHT FIXTURE (EL)
- 3 TOP OF SKIRTING
- 4 RAMP AND LANDING - R1.01
- 5 HVAC UNIT (HV)
- 6 DOWNSPOUT FASTEN TO BUILDING TYPICAL (3) PLACES - 16/A2.03
- 7 CONTINUOUS GUTTER WITH DOWNSPOUT (LOCATION OF DOWNSPOUT SHOWN ON ROOF PLAN)
- 8 FOUNDATION VENT (SEE FOUNDATION PLAN)
- 9 FINISH FLOOR LINE
- 10 FLOOR BEAM (STR)
- 11 ROOF HEADER (STR)
- 12 TOP OF COLUMN
- 13 FINISH GRADE
- 14 ROOF BEAM (STR)
- 15 COLUMN (STR)
- 16 ELECTRICAL STUB-OUT (EL)
- 17 GROUND STUB-OUT (EL)
- 18 J-BOX FOR EXTERIOR FIRE ALARM HORN (EL)
- 19 GUTTER BOX (EL)
- 20 SIGNAGE PROVIDED AND INSTALLED BY DISTRICT PRIOR TO OCCUPANCY. 5/A5.01
- 21 RIDGE

### NOTES

1. IF HVAC UNIT IS LOCATED IN ANY PATH OF TRAVEL OR CIRCULATION AREA AND HEIGHT FROM GRADE TO BOTTOM OF UNIT EXCEEDS 27" PROTECTION MUST BE PROVIDED

### EXTERIOR FINISH SCHEDULE


NOTE: SEE SPECIFICATIONS FOR DETAILED DESCRIPTION OF FINISH OPTIONS.

STANDARD - 5/8" PLYWOOD SIDING

OPTIONAL - 5/16" GROOVED FIBER CEMENT BOARD

OPTIONAL - 5/16" FIBER CEMENT BOARD WITH TEXTURED ELASTOMERIC COATING SYSTEM

OPTIONAL - EXTERIOR PLASTER OVER LATH

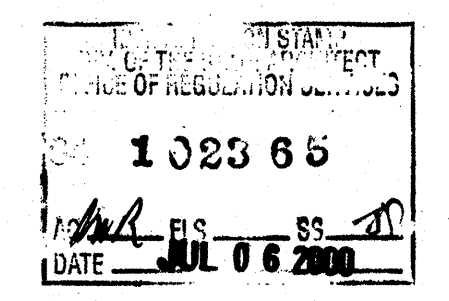

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 DIV. OF THE STATE ARCHITECT  
 APP03 115335  
 AC ME FLS 72 SS 50  
 DATE JUN 08 2014

PC  
 CBC 1998

EXTERIOR ELEVATIONS

26 GA DUAL PITCH (24'x40')  
 SCALE: 1/4" = 1'-0"

REVISIONS	Electrical Engineer's Seal	Mechanical Engineer's Seal	Structural Engineer's Seal	Architect's Seal
1				
2				
3				
4				
5				

Professional Engineer Seal for State of California, No. 102365, dated JUL 06 2000.

Professional Engineer Seal for State of California, No. 102365, dated JUL 06 2000.

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 101268  
 AG: D FLS SS 6\*\*  
 DATE SEP 07 1999

**MODTECH INC.**  
 2830 BARRETT AVENUE  
 PERRIS, CALIF. 92572  
 PH (909) 943-4014  
 FAX (909) 940-0427

PROJECT NUMBER: \_\_\_\_\_

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**STOCKPILE #53**  
 CLASS LEASING INC #3513  
 4012-107 80 MPH  
 100- 24x40 CLASSROOMS

DRAWN BY: 3904  
 DATE: 7/6/00  
 CHECKED BY: 3745  
 DATE: 7/6/00  
 MODTECH Index No. 3513

EXTERIOR ELEVATIONS 26 GA DUAL PITCH 24'x40' **A3.01**

FILE PATH: 21440-A3.01.DWG PROJECT NO. 4032 PC-04-101268