


**SCOPE OF WORK**  
**PURCHASE EQUIPMENT ONLY**

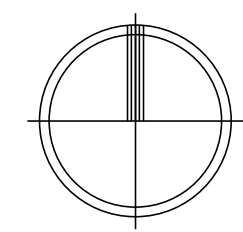

**SITE ELECTRICAL PLAN**  
**CENTRAL PLANT REPLACEMENT**

SCALE: 1" = 30'-0"

DSA APP# 03-122531  
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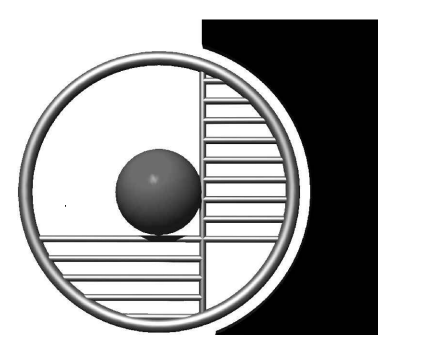


EXHIBIT-1 ALTERNATE BID # 1

Owner:  
**BAKERSFIELD CITY SCHOOL DISTRICT**  
1300 BAKER STREET  
BAKERSFIELD, CA 93309

Project Name:  
**CENTRAL PLANT REPLACEMENT**

Project Address:  
**WAYSIDE ELEMENTARY SCHOOL**  
1000 MING AVENUE  
BAKERSFIELD, CA 93307



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**SITE ELECTRICAL PLAN**




Job No.:  
**5526**

Sheet No.:  
**E1.00**

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**SCOPE OF WORK**  
**PURCHASE EQUIPMENT ONLY**

- NOTES (THIS SHEET ONLY):**
- REFER TO ONE LINE DIAGRAM SHEET #E4.01 FOR REQUIREMENTS.
  - PROVIDE NEW FIRE ALARM CABLES PER RISER DIAGRAM SHEET #E3.21.
  - PROVIDE PULL BOX PER DETAIL #E5.00.
  - ROUTE EXPOSED CONDUITS ALONG COVERED WALKWAY. TYPICAL FOR FIRE ALARM ROUTES. REFER TO DETAILS #11 AND #12/E5.00.
  - REFER TO TRANSFORMER PER DETAIL #E9/E5.00.
  - STUB OUT CONDUIT FOR FUTURE PORTABLE CLASSROOMS, REFER TO ONE LINE DIAGRAM SHEET #E4.01 AND FIRE ALARM SYSTEM RISER DIAGRAM, SHEET #E3.21.
  - REFER TO DETAIL #10/E5.00 FOR REQUIREMENTS.

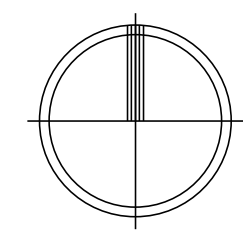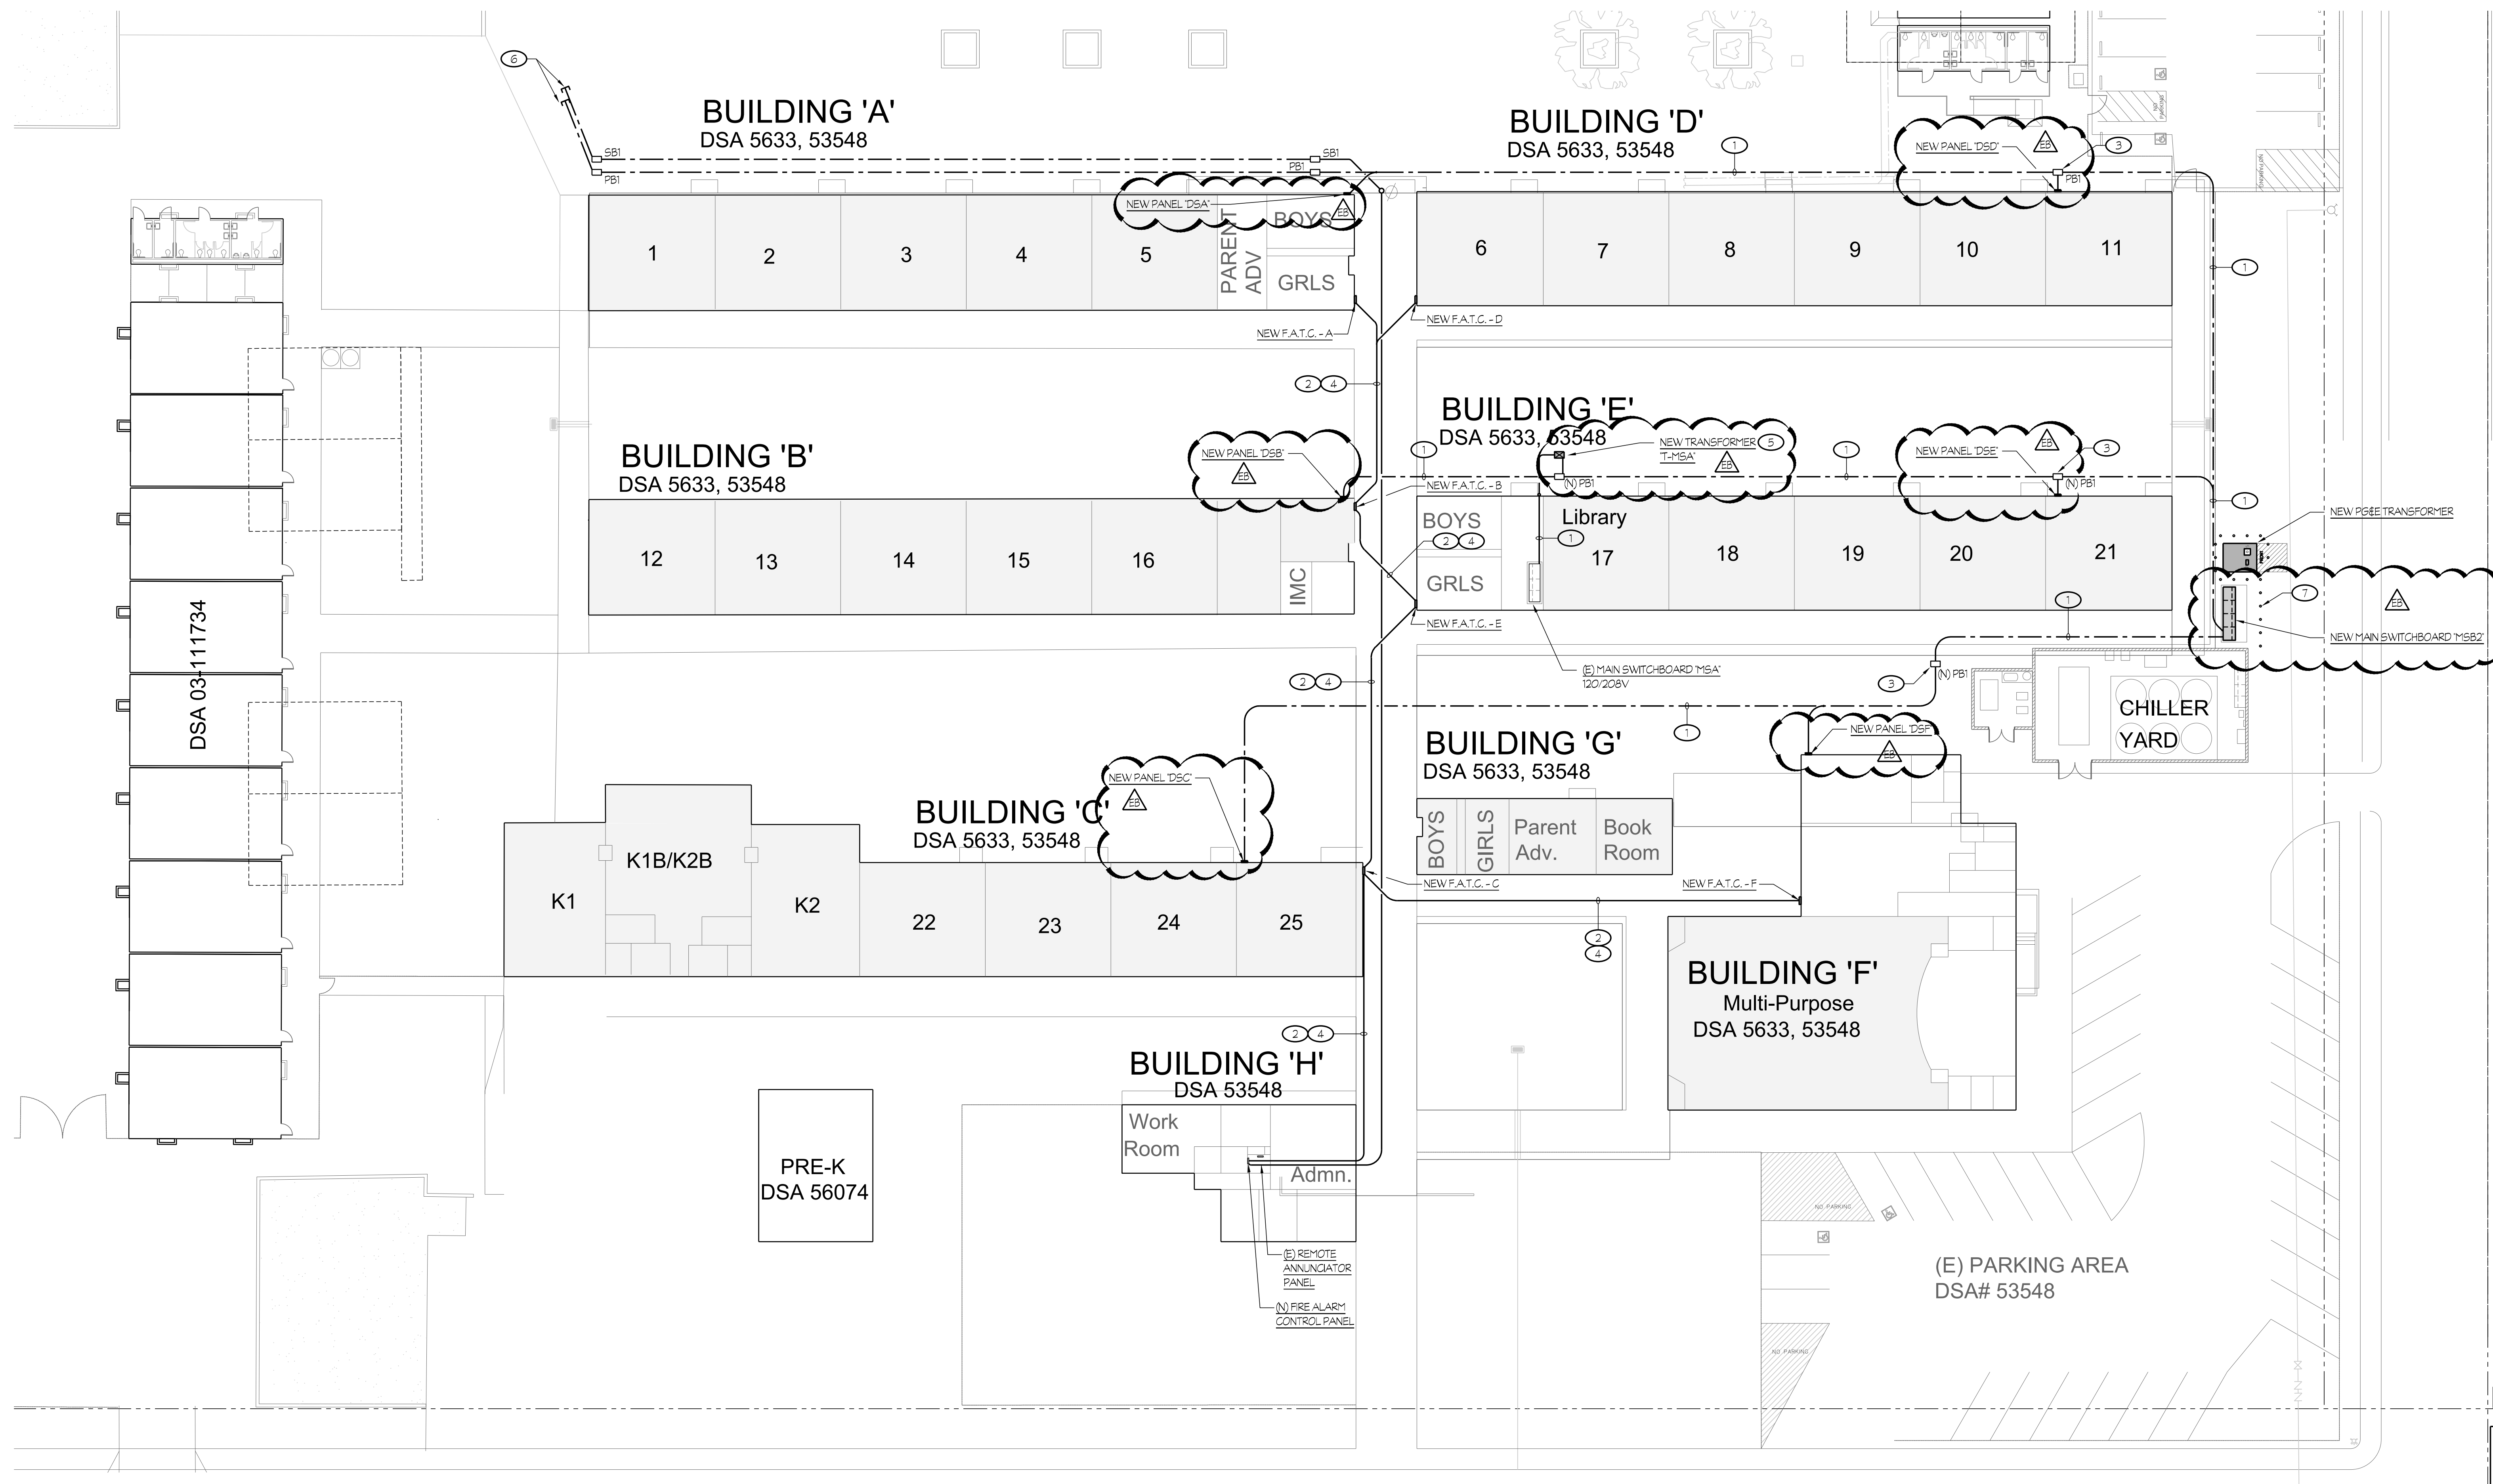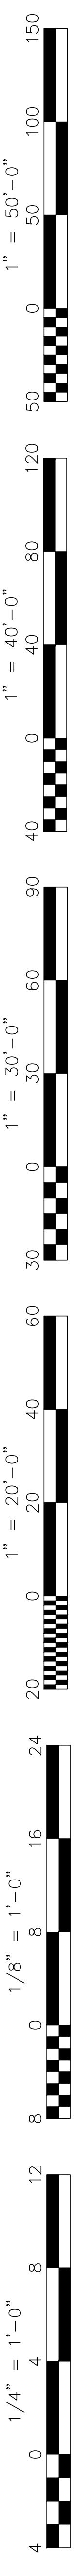

**ENLARGED SITE ELECTRICAL PLAN**  
**CENTRAL PLANT REPLACEMENT**

SCALE: 1" = 20'-0"

DSA APP# 03-122531  
EQUIPMENT BID PACKAGE  
02/17/23




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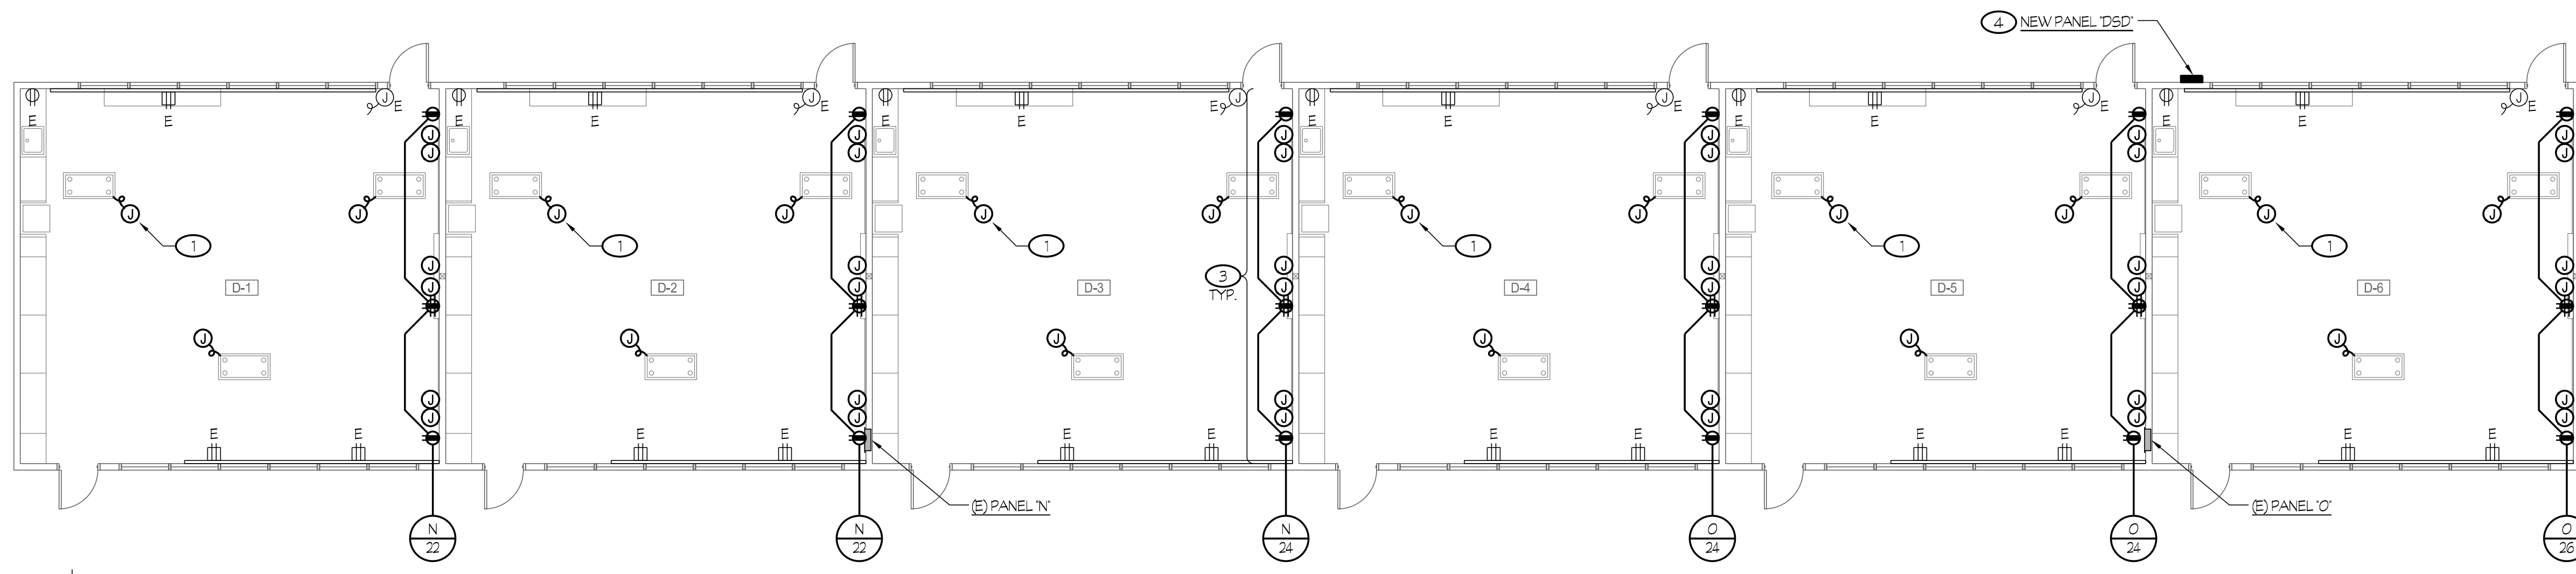
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**ENLARGED SITE ELECTRICAL PLAN**

Job No.:  
**5526**


Sheet No.:  
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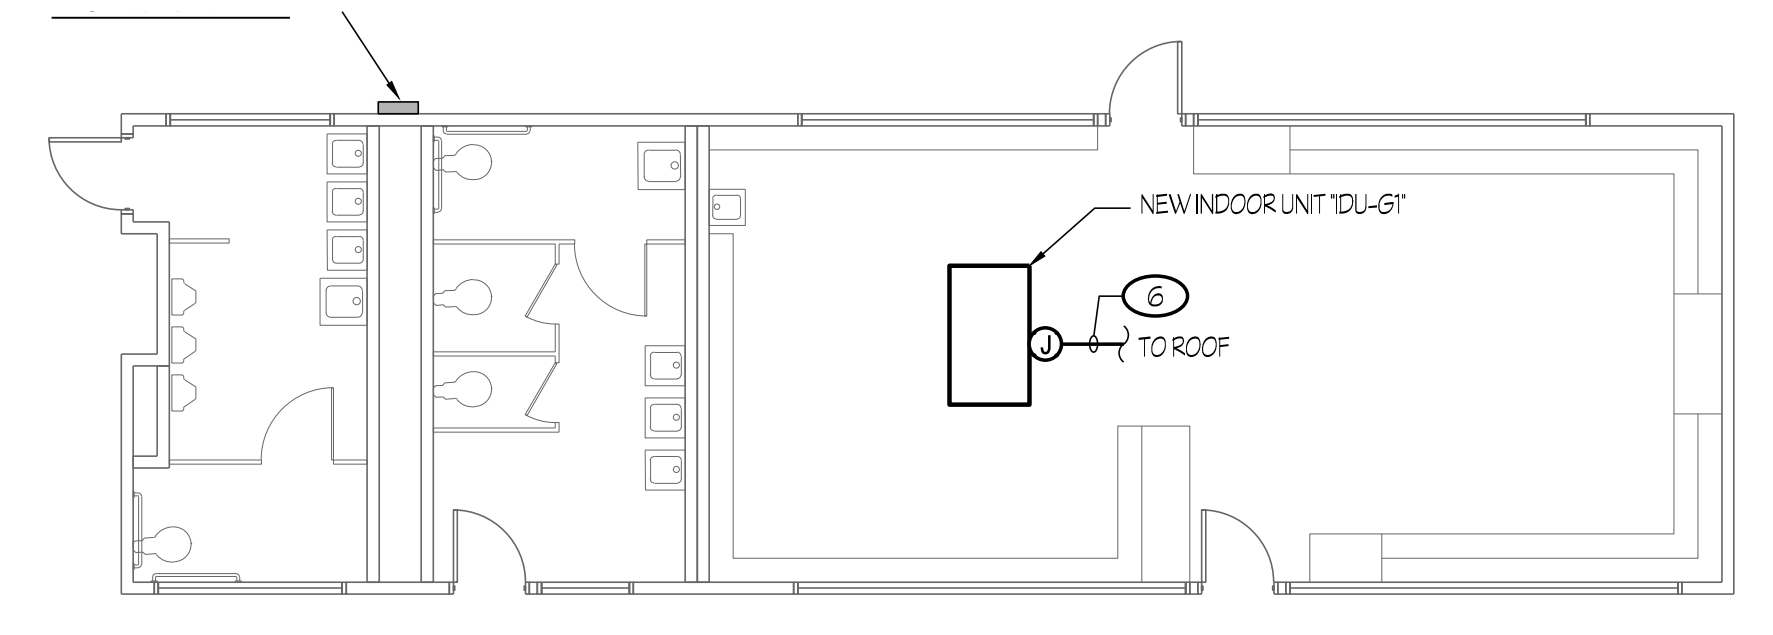
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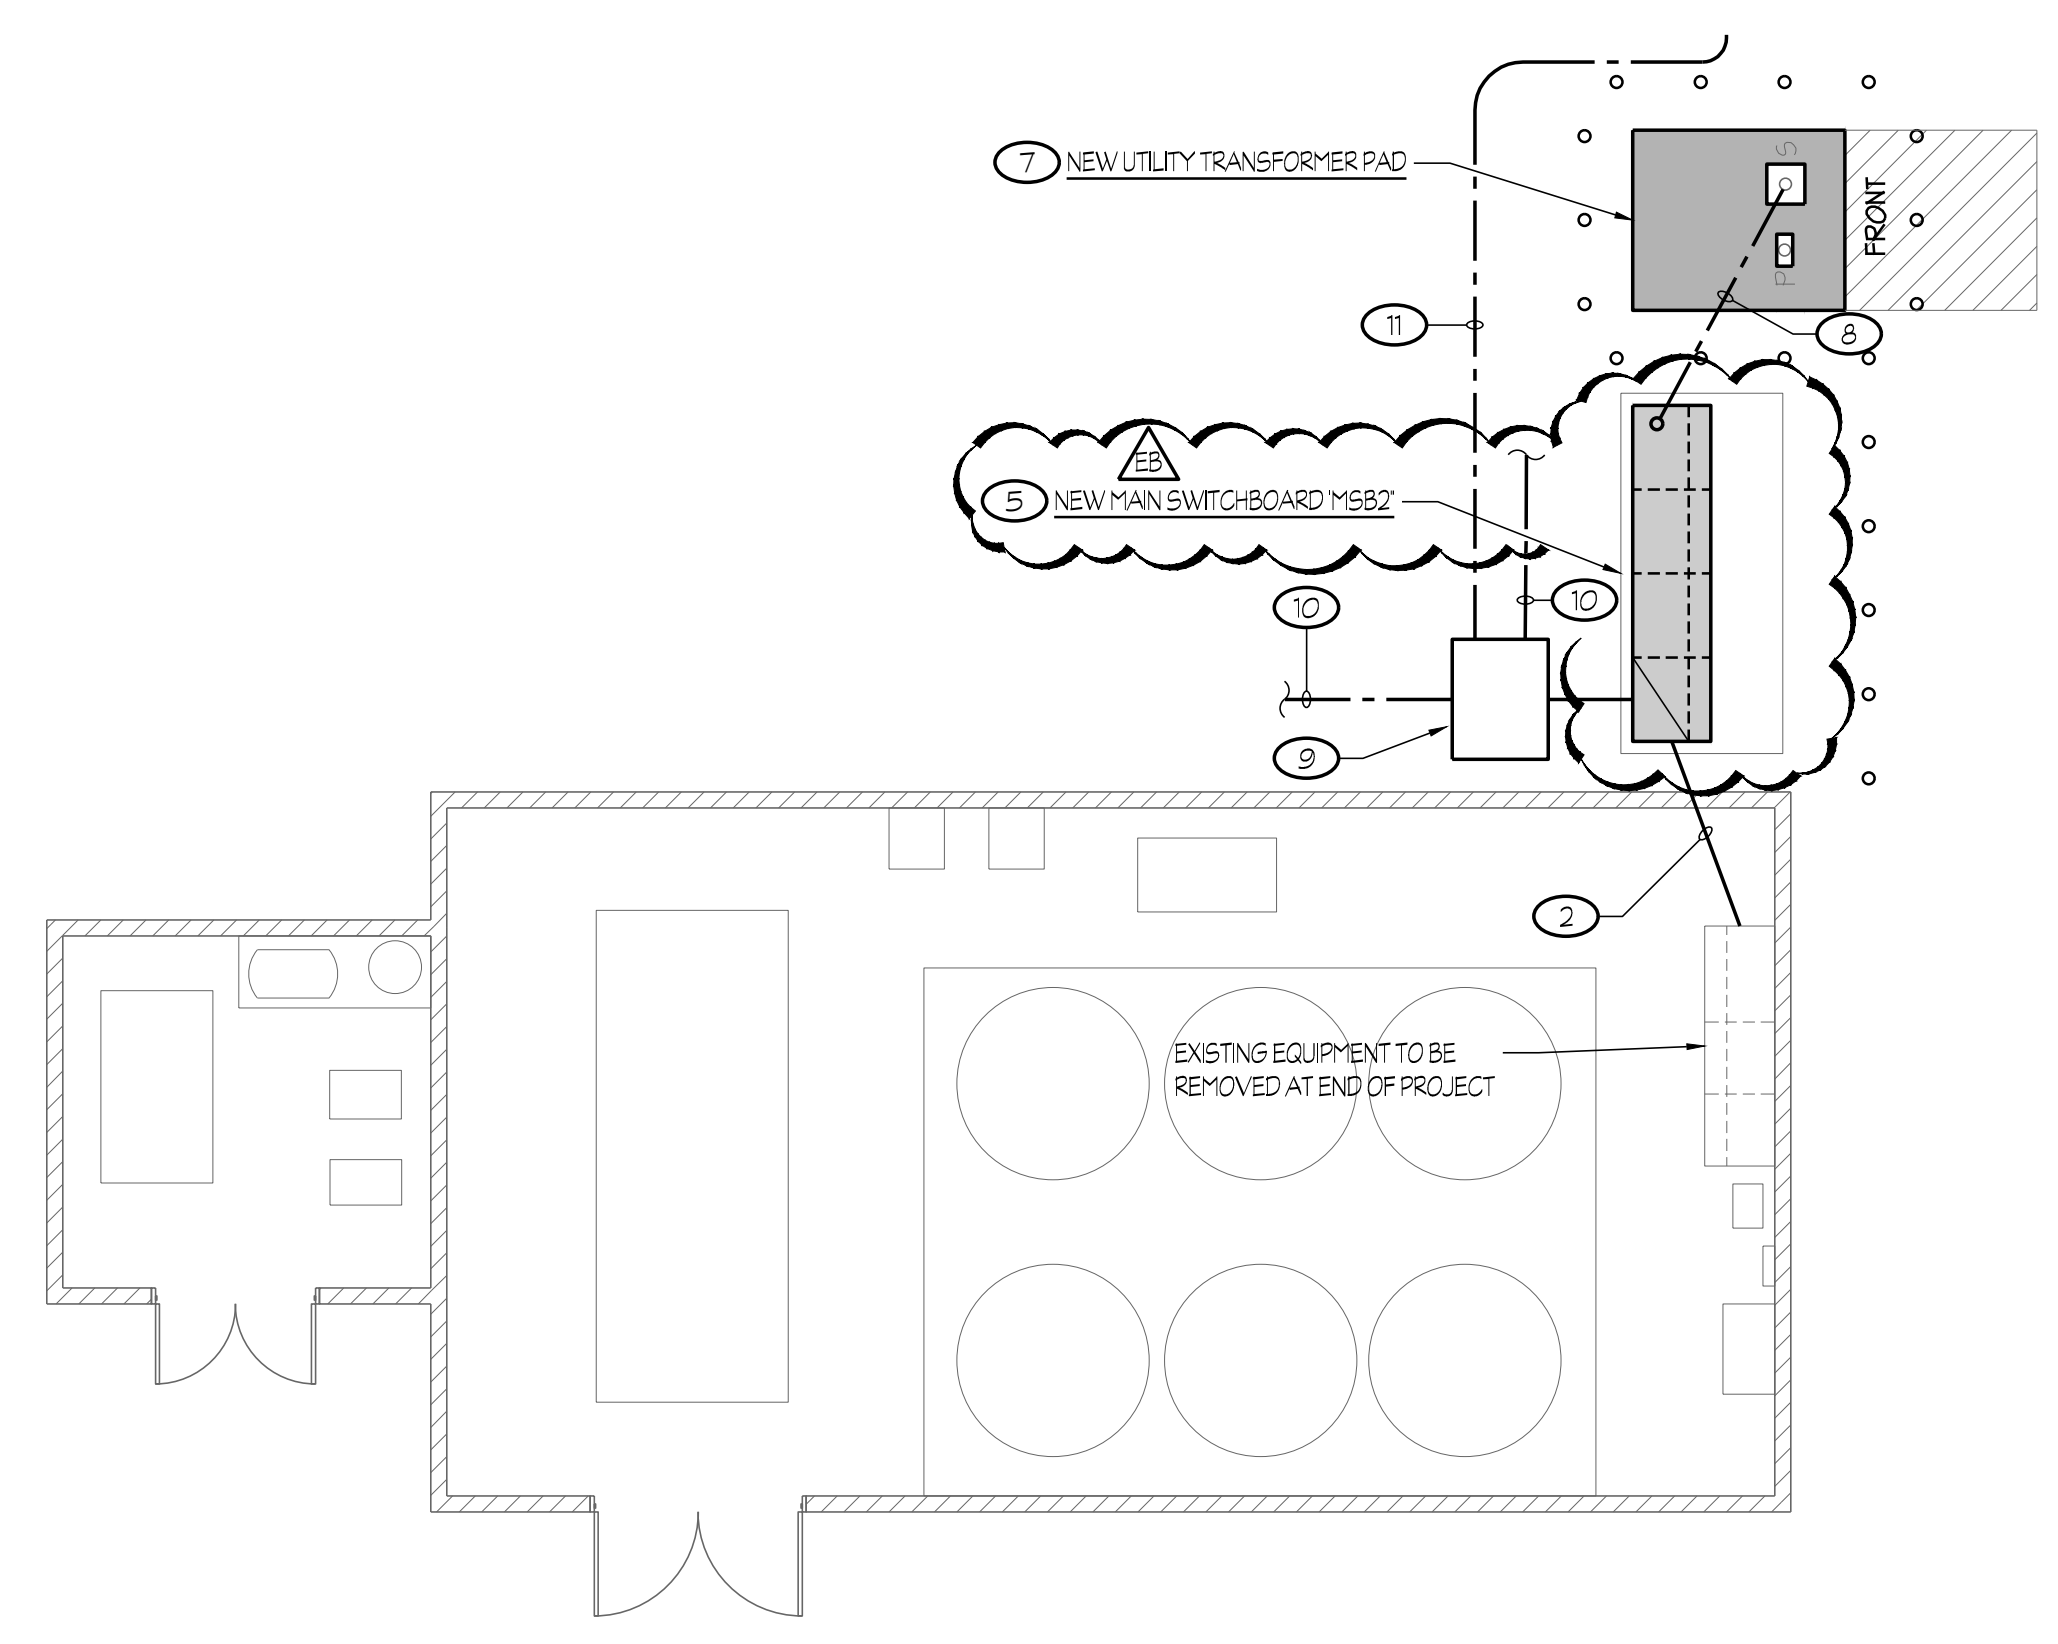
**1 NEW POWER PLAN - BUILDING "D"**  
CENTRAL PLANT REPLACEMENT  
SCALE: 1/8" = 1'-0"




**2 NEW POWER PLAN - BUILDING "E"**  
CENTRAL PLANT REPLACEMENT  
SCALE: 1/8" = 1'-0"

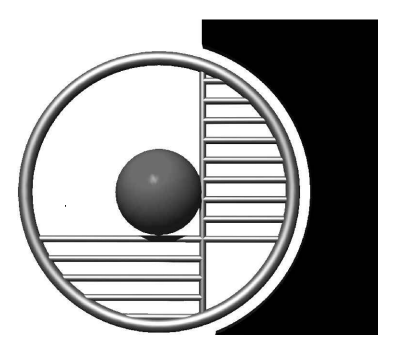

**5 NEW POWER PLAN - BUILDING "G"**  
CENTRAL PLANT REPLACEMENT  
SCALE: 1/8" = 1'-0"

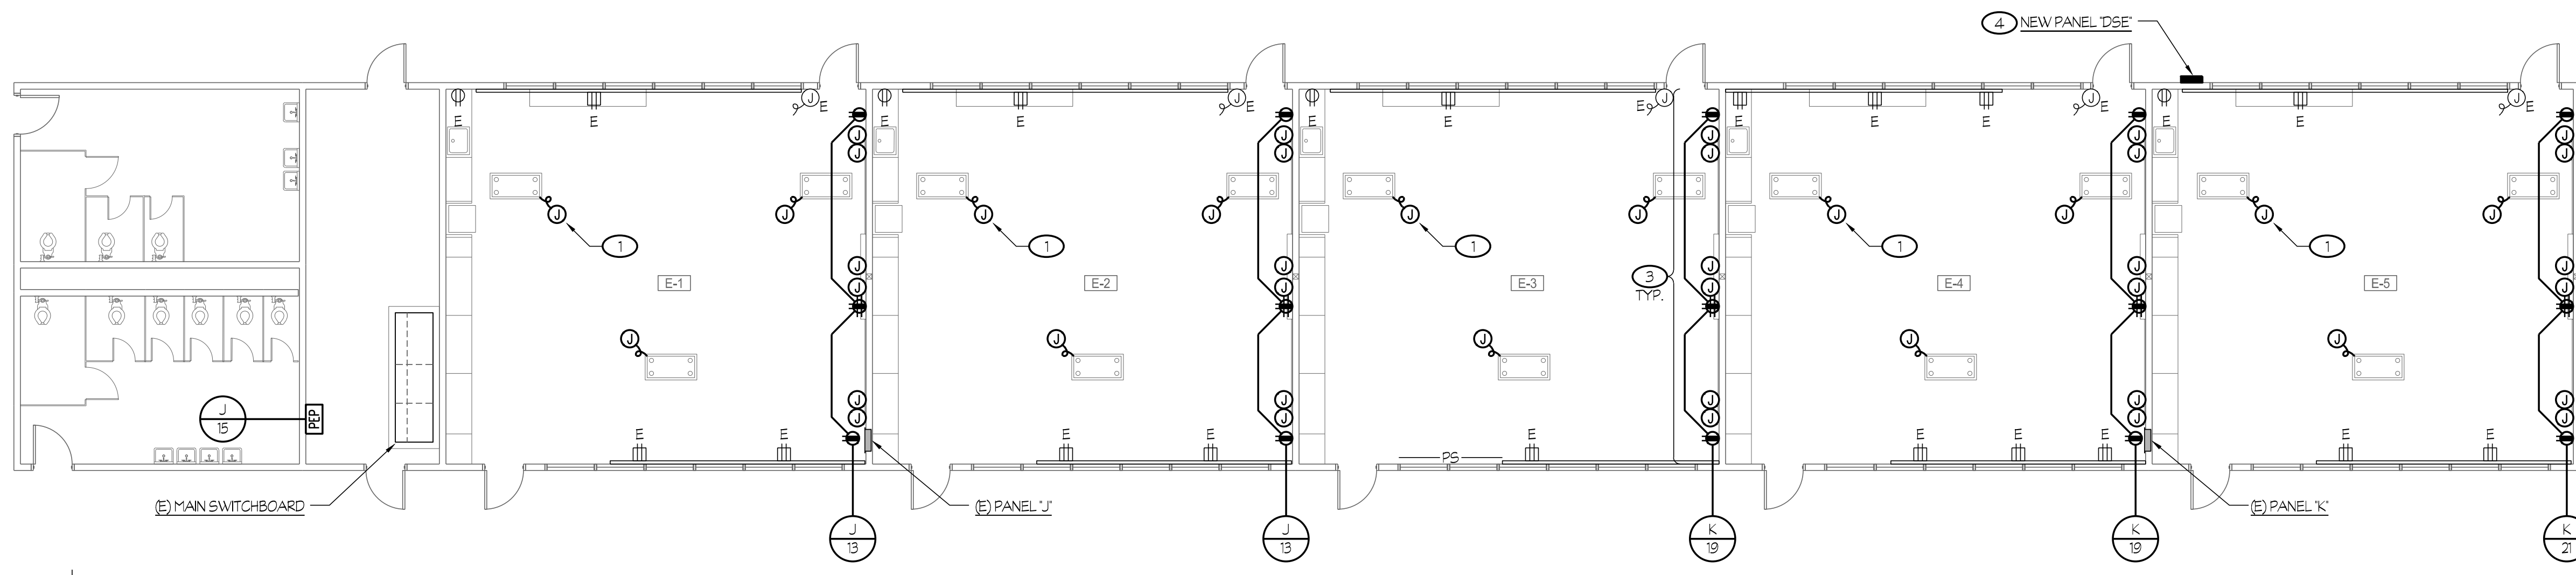

**3 NEW POWER PLAN - CHILLER YARD**  
CENTRAL PLANT REPLACEMENT  
SCALE: 1/8" = 1'-0"

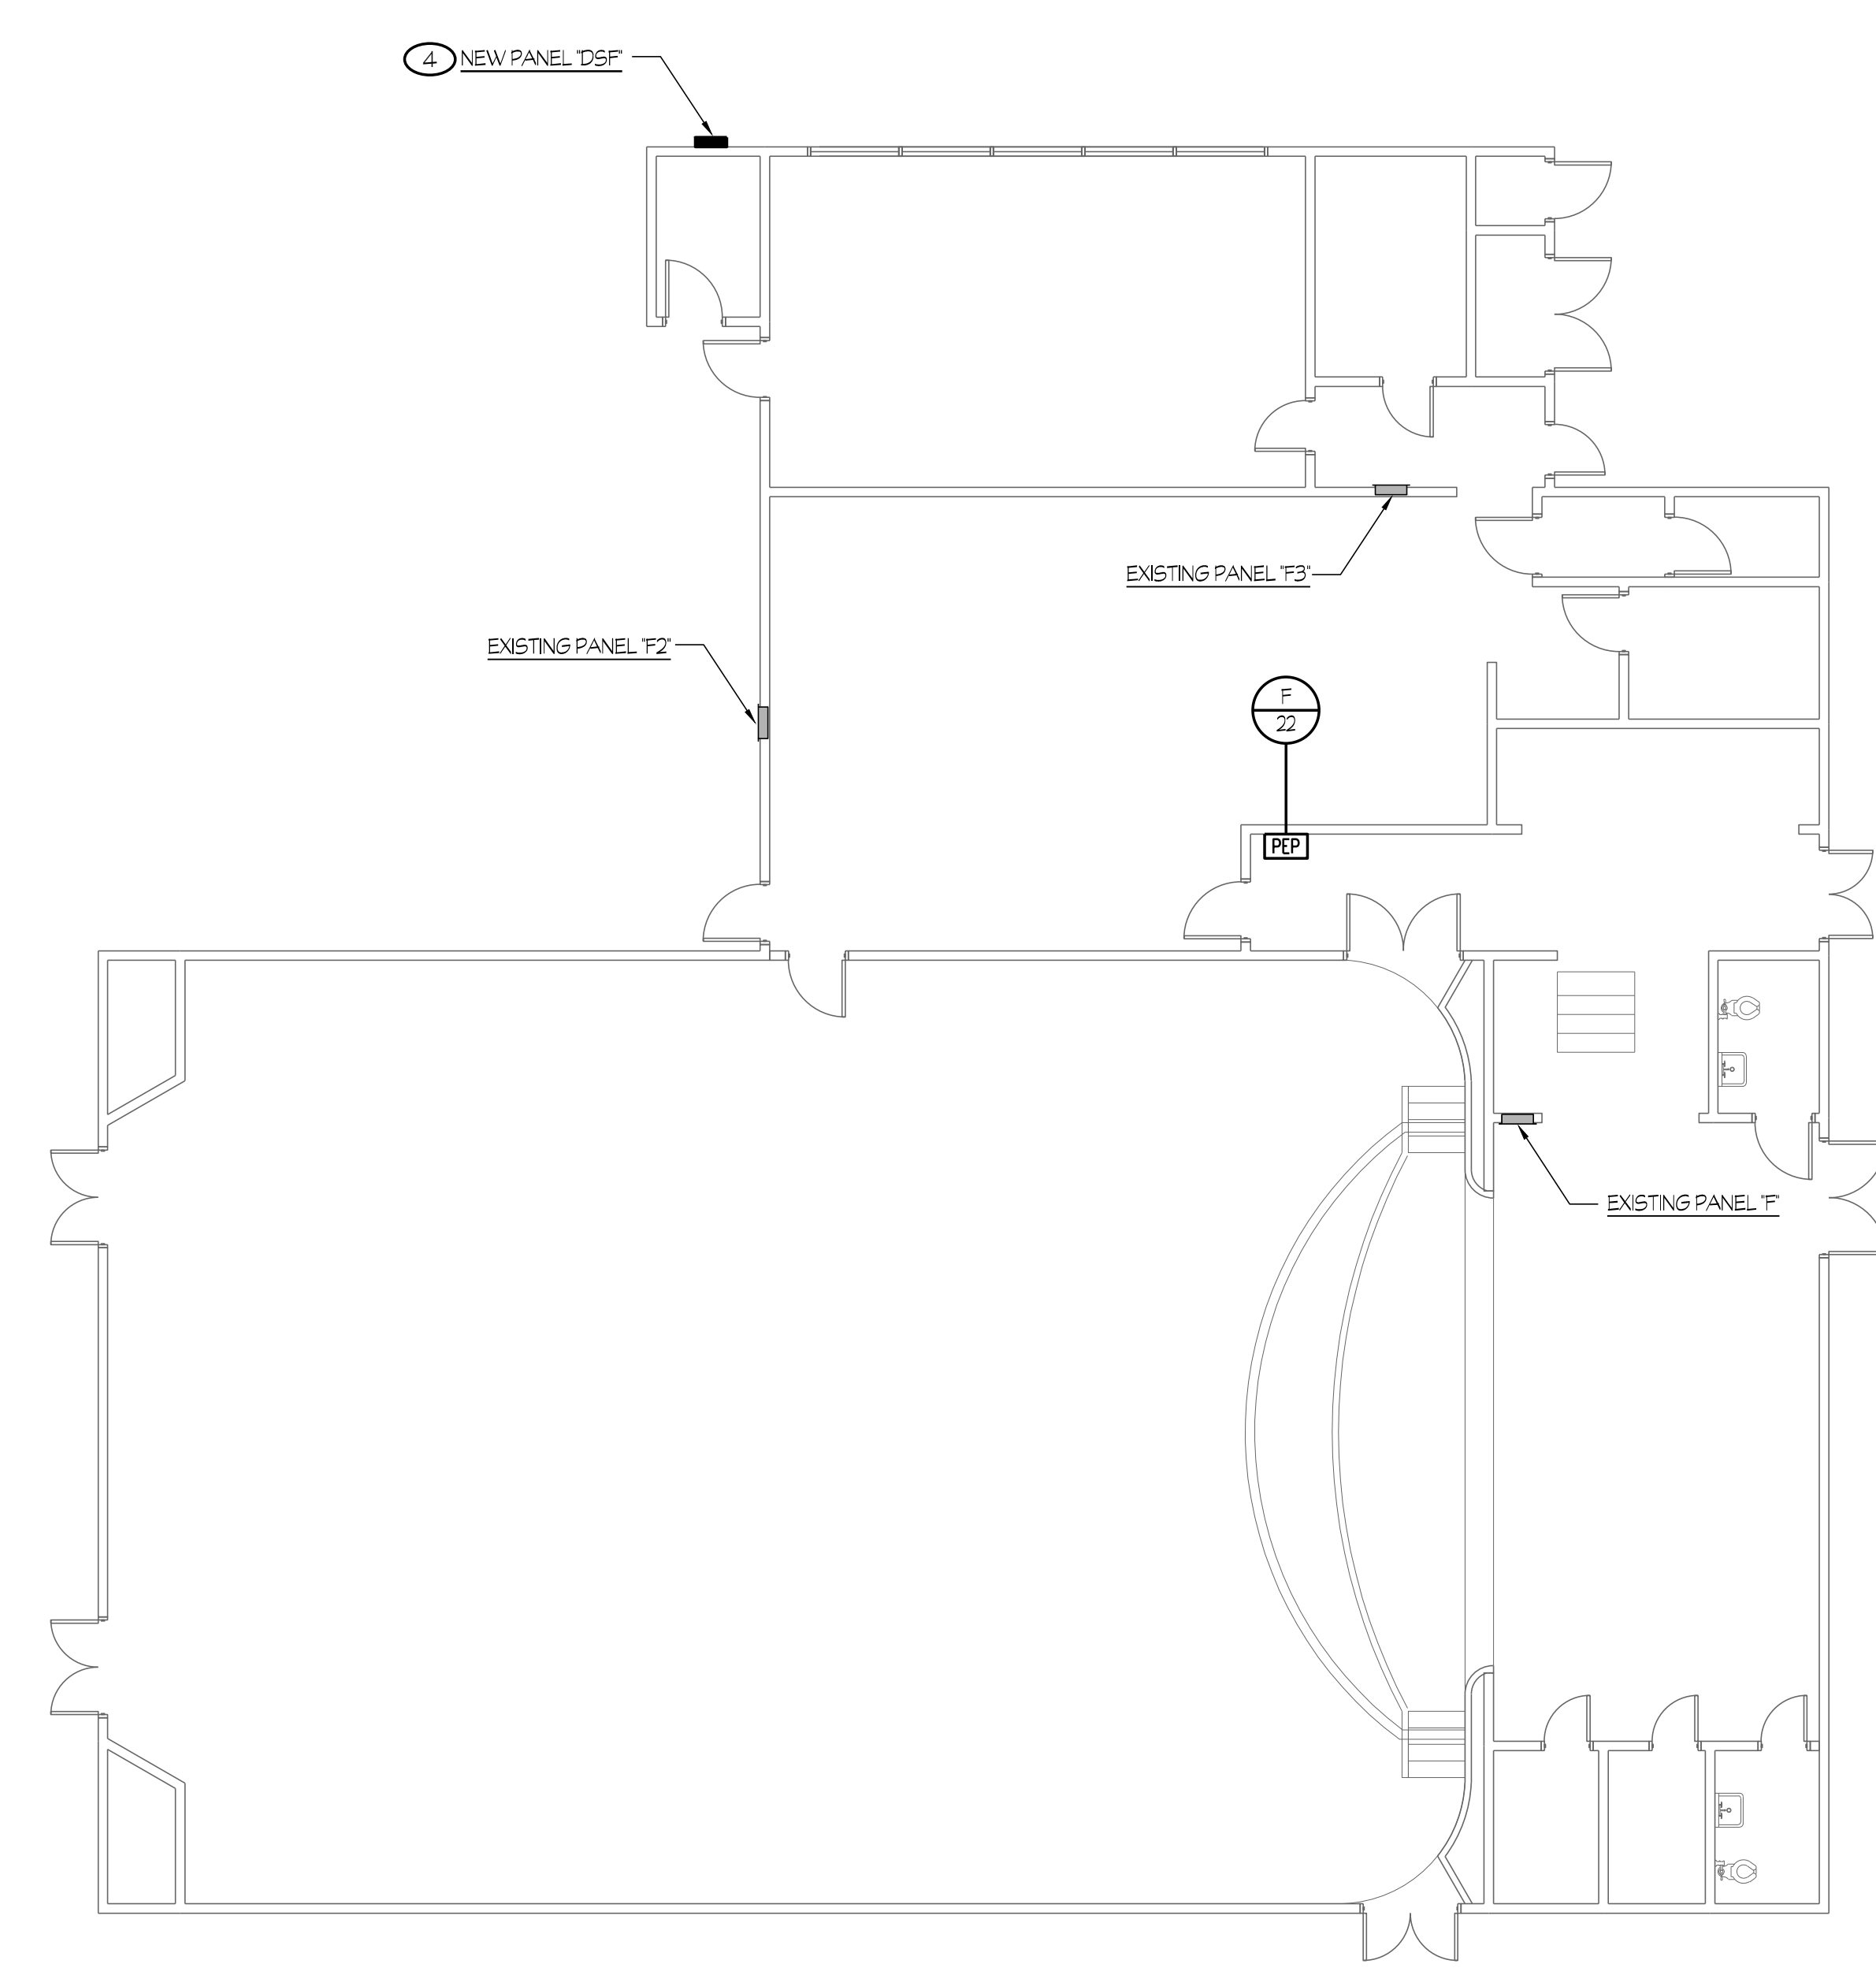

**4 NEW POWER PLAN - BUILDING "F"**  
CENTRAL PLANT REPLACEMENT  
SCALE: 1/8" = 1'-0"

- NOTES (THIS SHEET ONLY):**
- RECONNECT EXISTING MECHANICAL EQUIPMENT. EXTEND EXISTING CIRCUIT AS REQUIRED. TYPICAL.
  - TEMPORARY CONNECTION TO EXISTING EQUIPMENT PER ONE-LINE DIAGRAM.
  - REFER TO DETAIL #2/EQ.01 FOR TYPICAL TEACHER WALL ELEVATION.
  - REFER TO DETAIL #6/ES.00 FOR MOUNTING REQUIREMENTS.
  - REFER TO DETAIL #7/ES.00 FOR MOUNTING REQUIREMENTS.
  - PROVIDE 3/4" - 2 #12 + 1 #12 GND.
  - PROVIDE NEW UTILITY PAD PER APPROVED UTILITY DRAWINGS AND P66E STANDARDS 045292.
  - PROVIDE SECONDARY CONDUCTORS PER APPROVED UTILITY DRAWINGS (EXPECTED TO BE (6) 4' CONDUITS).
  - PROVIDE NEW VAULT STYLE PULL BOX FOR ROUTING OF CONDUITS. REFER TO DETAIL #5/ES.00.
  - NEW CONDUITS AND CONDUCTORS PER ONE LINE DIAGRAM ON SHEET #E4.01. REFER TO SITE PLAN #E1.01 FOR CONTINUATION.
  - NEW CONDUIT AND CONDUCTORS FOR RECONNECTION OF EXISTING FEEDS PER ONE LINE DIAGRAM ON SHEET #E4.01.
  - FIELD VERIFY PICK-UP POINT FOR EXISTING FEEDERS AND ROUTE AROUND NEW CONSTRUCTION AS REQUIRED.

**GENERAL NOTES**

- EXISTING RECEPTACLES SHALL REMAIN INCLUDING RESPECTIVE CIRCUITS.

**SCOPE OF WORK**  
**PURCHASE EQUIPMENT ONLY**

ROOM LEGEND	
#	ROOM NAME
D-1	CLASSROOM
D-2	CLASSROOM
D-3	CLASSROOM
D-4	CLASSROOM
D-5	CLASSROOM
D-6	LIBRARY

ROOM LEGEND	
#	ROOM NAME
E-1	CLASSROOM
E-2	CLASSROOM
E-3	CLASSROOM
E-4	CLASSROOM
E-5	CLASSROOM

ROOM LEGEND	
#	ROOM NAME
F-1	ASSEMBLY CAFETERIA
F-2	STAGE
F-3	KITCHEN
F-4	FACULTY DINING

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Owner:  
**BCSD**  
BAKERSFIELD CITY SCHOOL DISTRICT

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**NEW POWER PLANS - BLDGS D, E & CHILLER YARD**


Job No.: **5526**

Sheet No.: **E2.11**

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1" = 50'-0"  
1" = 40'-0"  
1" = 30'-0"  
1" = 20'-0"  
1" = 15'-0"  
1" = 12'-0"  
1" = 10'-0"  
1" = 8'-0"  
1" = 6'-0"  
1" = 4'-0"  
1" = 3'-0"  
1" = 2'-0"  
1" = 1'-0"


Z:\Drawing\Jobs\2023\03\03\Bakersfield\Bakersfield City School District\Wayside Elementary - NAC\21.1.dwg DATE: 02/05/23 BY: Adam Dine DATE: 02/17/23 JOB #: 21-18-55

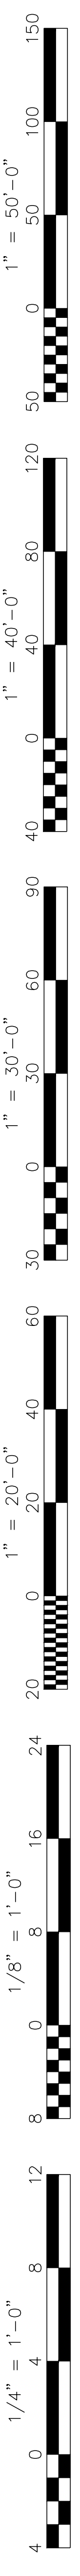

**SCOPE OF WORK**

**PURCHASE EQUIPMENT ONLY**

- NOTES (THIS SHEET ONLY):**
- 1 EXISTING UTILITY FEED SHALL BE DISCONNECTED. PROVIDE NEW CONNECTION FROM NEW XPRR TMSA TO FEED EXISTING BOARD MSA, AS SHOWN ON SHEET EA-01.
  - 2 EXISTING UTILITY FEED SHALL BE DISCONNECTED. PROVIDE NEW CONNECTION FROM NEW BOARD MMS2 TO FEED EXISTING BOARD MEB DURING CONSTRUCTION, AS SHOWN ON SHEET EA-01.
  - 3 EXISTING CHILLER EQUIPMENT SHALL REMAIN IN SERVICE DURING CONSTRUCTION ACTIVITIES. EQUIPMENT SHALL BE DISCONNECTED AND REMOVED AT THE END OF NEW CONSTRUCTION.
  - 4 RETURN UTILITY METER EQUIPMENT TO UTILITY COMPANY AND PROVIDE CONNECTION TO POWER DISTRIBUTION BOARDS.
  - 5 EP DENOTES EXISTING FEEDER AND/OR SPARE CONDUIT(S) SHALL REMAIN, UNLESS OTHERWISE NOTED.

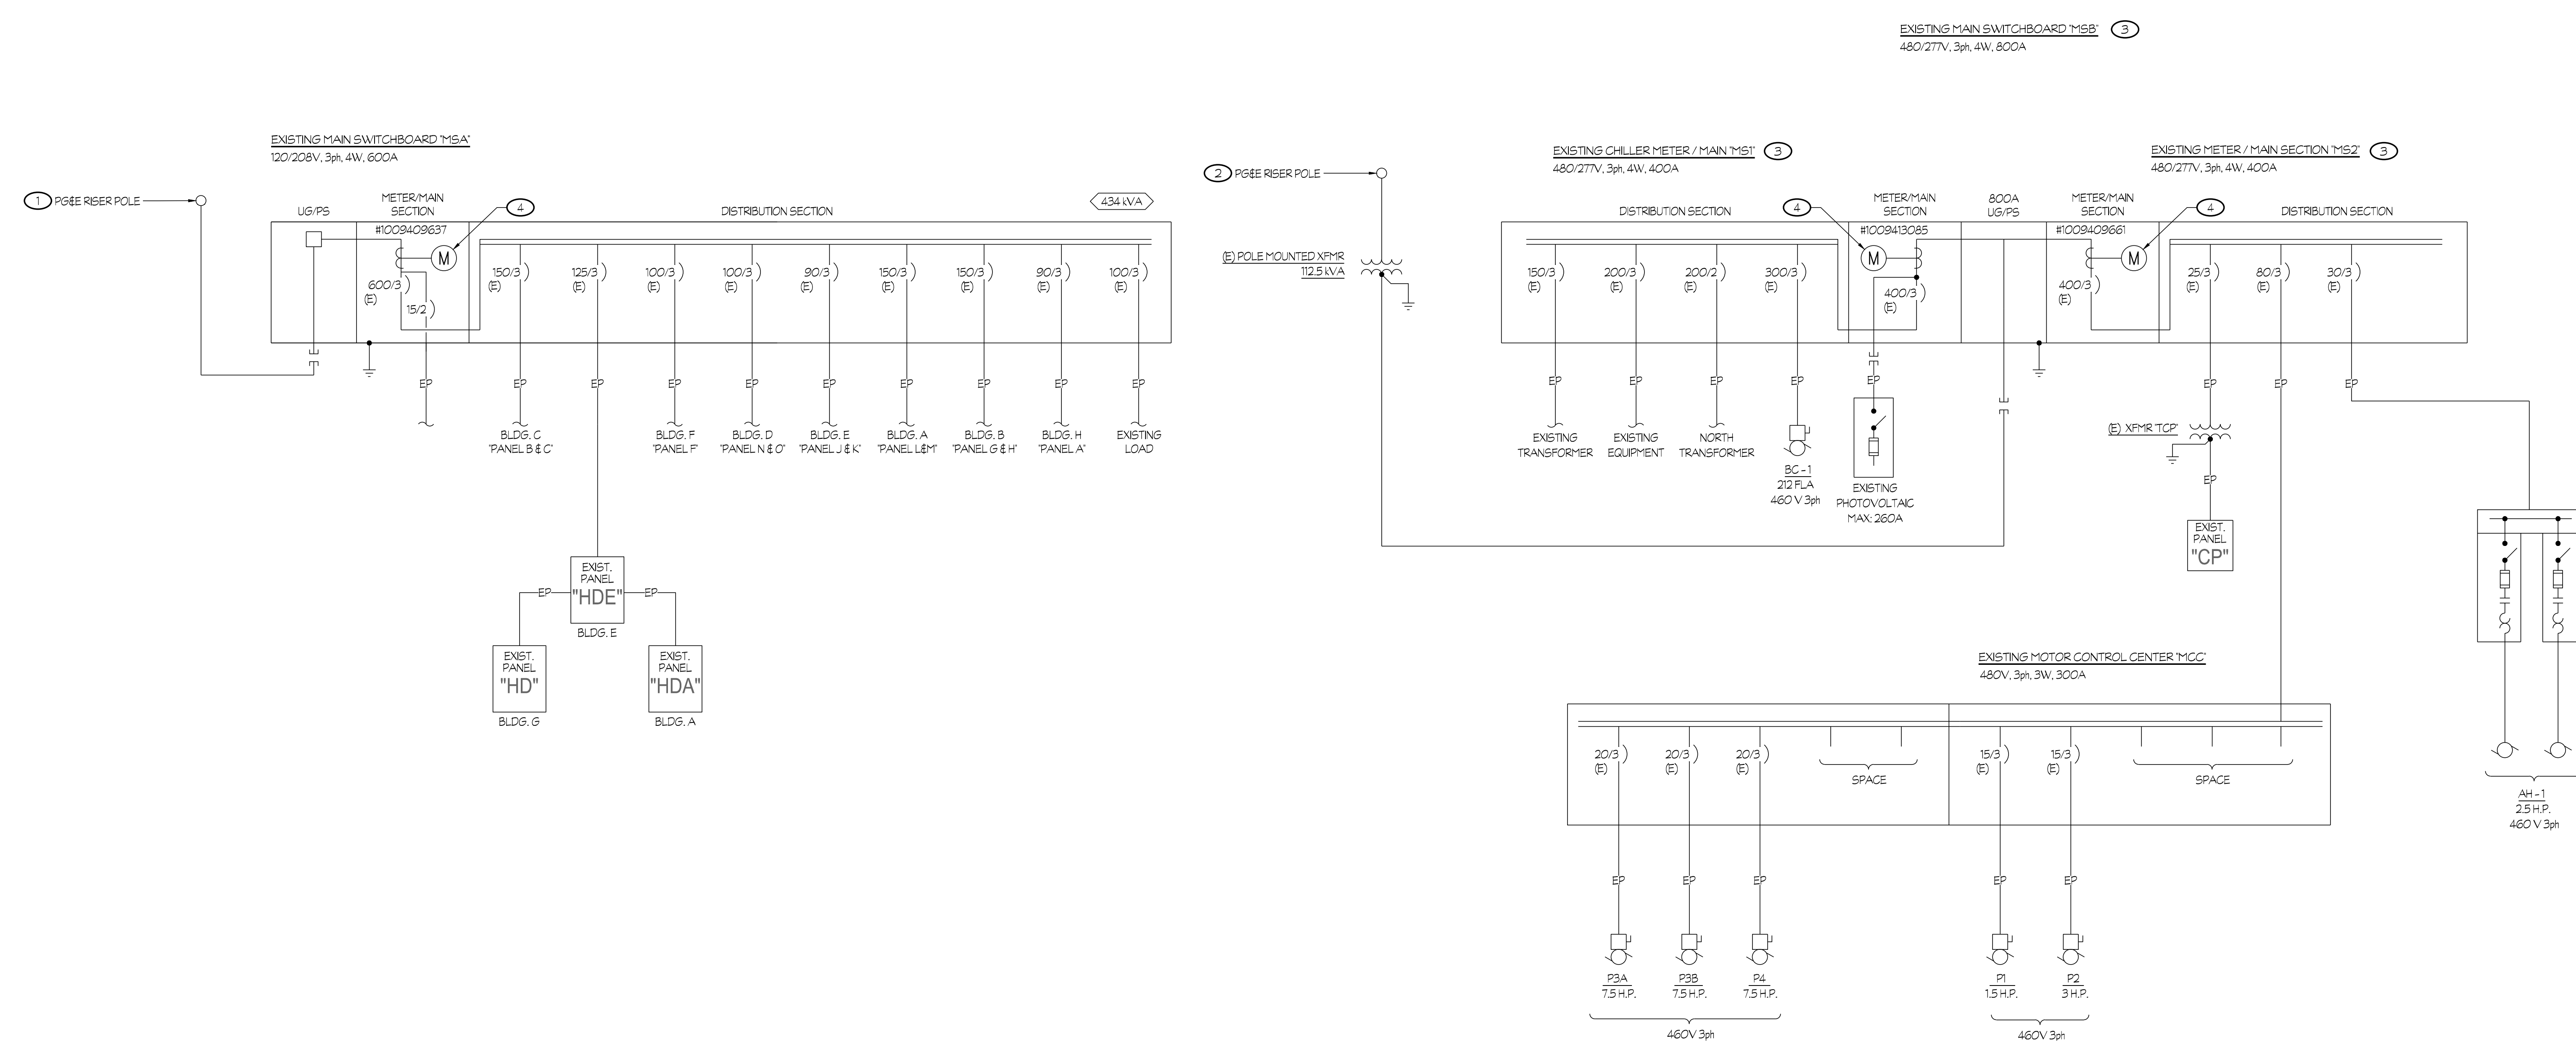


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**ONE LINE DIAGRAM - DEMO**  
**CENTRAL PLANT REPLACEMENT**

DSA APP# 03-122531  
EQUIPMENT BID PACKAGE  
02/17/23




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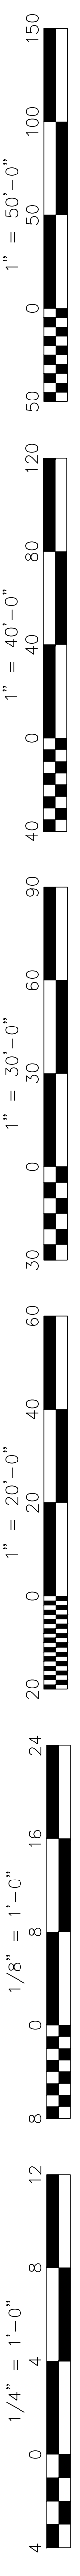
Sheet Title:  
**ONE LINE DIAGRAM - DEMO**

Job No.:  
**5526**

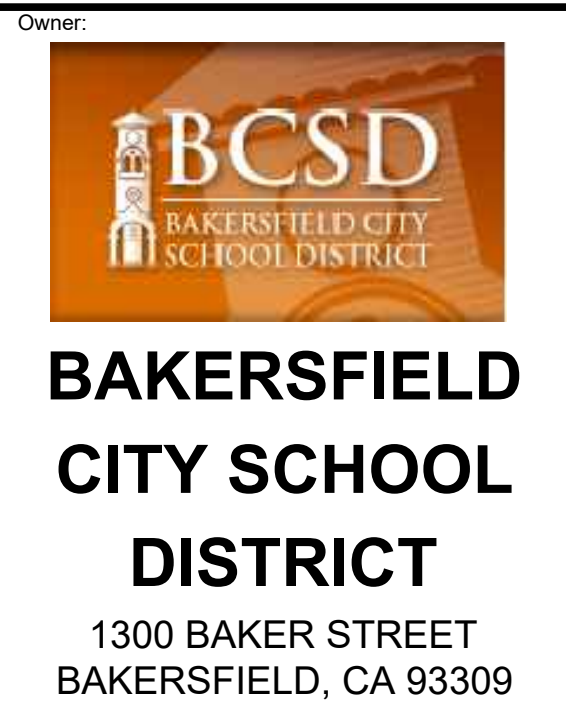Sheet No.:  
**E4.00**

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**NEW MAIN SWBD 'MSB' LOAD CALCULATION:**


MAXIMUM DEMAND PER P.G. & E. RECORDS	332.2 kVA
FOR MAIN SWBD 'MSB' (METER 1009409637)	332.2 kVA
FOR MAIN SWBD 'MSB1' (METER 1009413085)	216.2 kVA
FOR MAIN SWBD 'MSB2' (METER 1009409661)	32.8 kVA
PLUS DEMAND FACTOR PER C.E.C. 220.35	83.1 kVA
SUB-TOTAL	485.3 kVA
NEW 'CONNECTED' LOAD BEING ADDED	588.3 kVA
H.V.A.C. x 125%	588.3 kVA
TOTAL	1073.6 kVA
FUTURE CLASSROOM BUILDING	150 kVA
TOTAL	1223.6 kVA
AT 480/277V 3ph 4W	1388 AMP'S

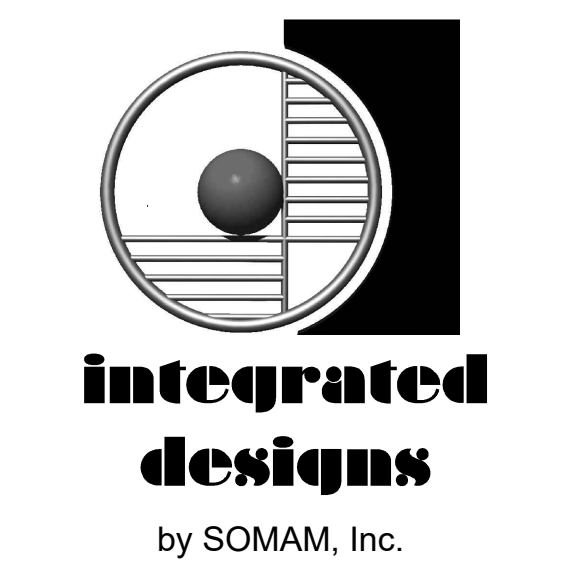THEREFORE, THE EXISTING/NEW 1600 AMP MAIN SWITCHBOARD IS SUFFICIENT.

- NOTES (THIS SHEET ONLY):**
- EXISTING P.G. & E. POWER POLE. VERIFY EXACT LOCATION AND RISER QUADRANT WITH P.G. & E. PRIOR TO ROUGH-IN.
  - PROVIDE A 106" x 30" CONCRETE PAD (STYLE 111 E) AND GROUNDING FOR P.G. & E. PAD MOUNTED TRANSFORMER PER P.G. & E. REQUIREMENTS.
  - PROVIDE LANDING LUGS PER P.G. & E. REQUIREMENTS.
  - PROVIDE METERING FACILITIES PER P.G. & E. REQUIREMENTS.
  - MAIN CIRCUIT BREAKER SHALL BE 100% RATED ELECTRONIC TYPE, EQUIPPED WITH LONG-TIME, SHORT-TIME, INSTANTANEOUS-OFF TYPE AND GROUND FAULT TYPE CONFIGURATIONS. MAIN CIRCUIT BREAKER SHALL ALSO BE EQUIPPED WITH A TRIP INDICATOR AND LOCAL CURRENT METER. SQUARE D HRX SERIES OR EQUAL.
  - 1#3/0 TO GROUNDING ELECTRODE SYSTEM PER DETAIL #15/ES.00.
  - PROVIDE WITH SPACE AND MOUNTING HARDWARE FOR MINIMUM (4) 400A FRAMES.
  - EP DENOTES EXISTING FEEDER AND/OR 'SPARE' CONDUIT(S) SHALL REMAIN, UNLESS OTHERWISE NOTED.
  - COORDINATE WITH P.G. & E. TO REMOVE METER SOCKET AND PROVIDE BLANK METER SOCKET COVER.
  - RETURN UTILITY METER EQUIPMENT TO UTILITY COMPANY AND PROVIDE CONNECTION TO POWER DISTRIBUTION BOARDS.
  - 1#2 TO GROUNDING ELECTRODE SYSTEM PER DETAIL #16/ES.00.
  - (2) 3" CONDUITS FOR FUTURE USE.

- NEW FEEDER SCHEDULE:**  
(ALL UNDERGROUND CONDUCTORS, OF A 480/277V POWER SYSTEM, SHALL BE TYPE CU-XHHW-2. ALL OTHER CONDUCTORS, INCLUDING THE EQUIPMENT GROUNDING CONDUCTOR, SHALL BE CU-THWN-2 FOR #8 AWG OR LARGER AND CU-THWN FOR #10 AWG OR SMALLER.)
- 1500SN 1 1/2" C - 4 #1 + 1 #6 GND.
  - 2000SN 2 1/2" C - 4 #4/0 + 1 #4 GND.
  - 3000SN 3" C - 4 #350 kcmil + 1 #2 GND.
  - 4000SN 3" C - 3 #500 + 1 #1/0 GND.
  - 5000SN (2) 3" C - 4 #3/0 + 1 #2 GND EACH.
  - 6000SN (2) 3 1/2" C - 4 #350 kcmil + 1 #1 GND EACH.

**SCOPE OF WORK**  
**PURCHASE**  
**EQUIPMENT ONLY**

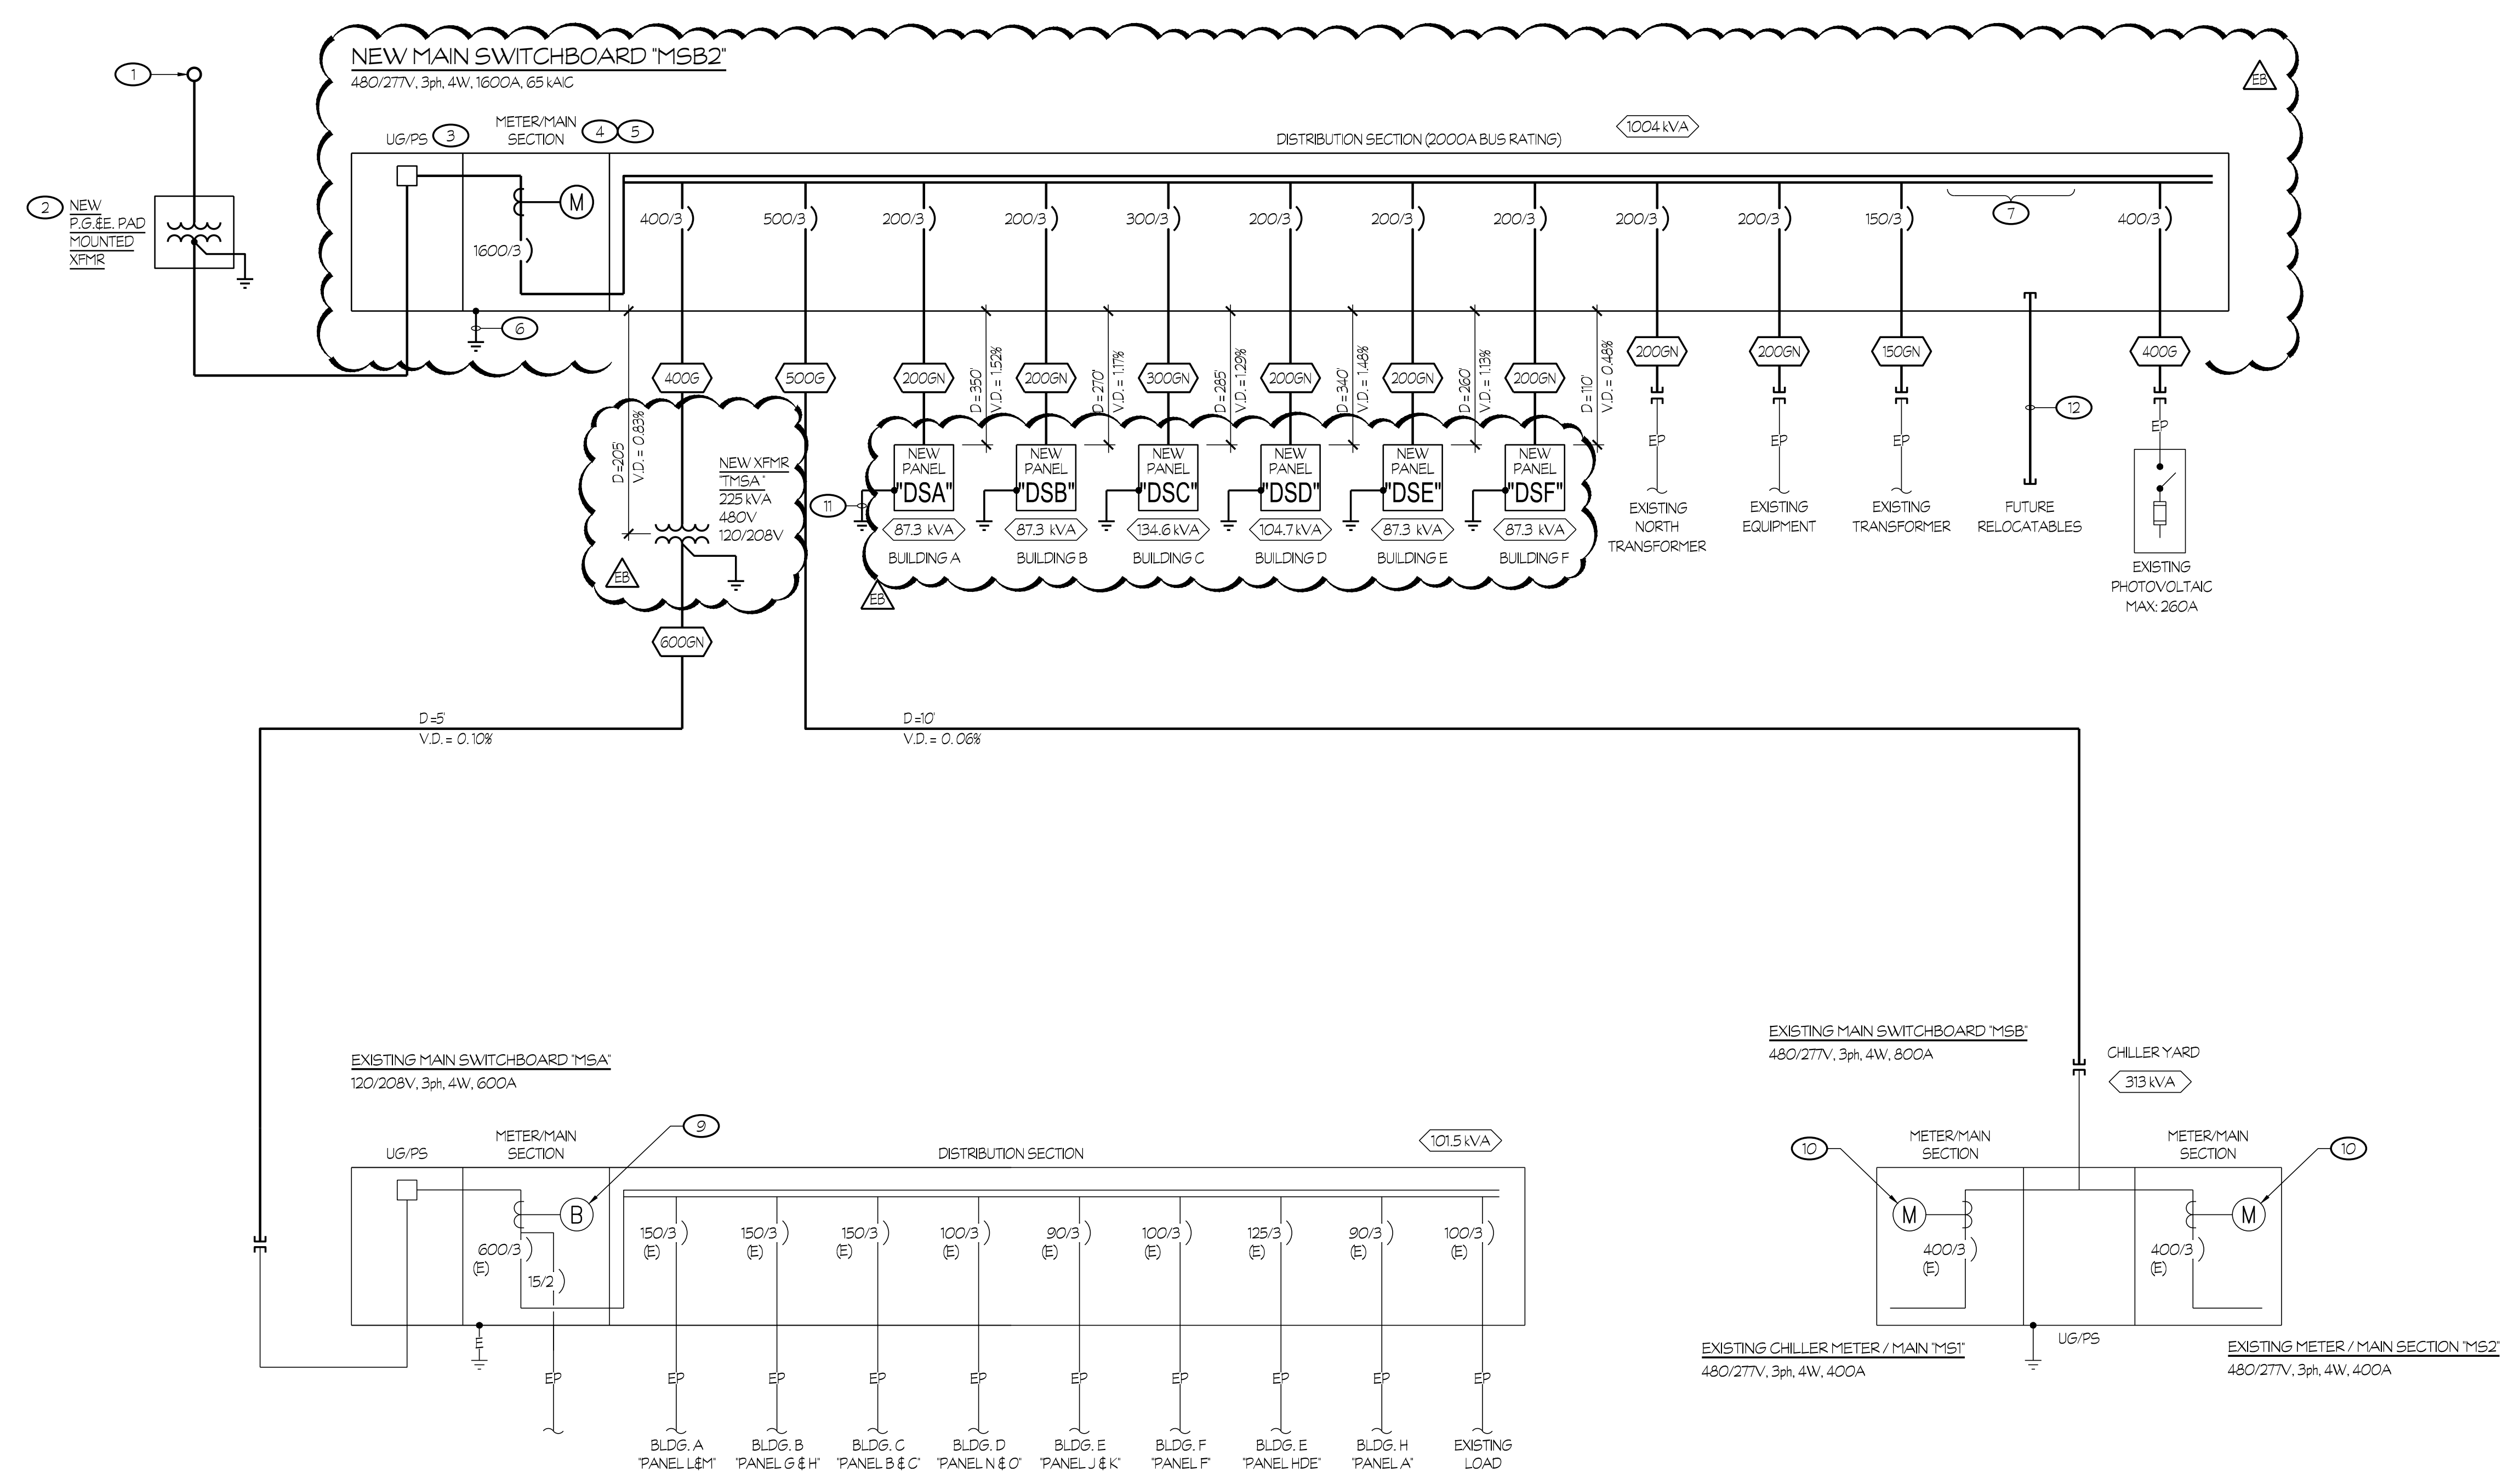

**1 ONE LINE DIAGRAM**  
**CENTRAL PLANT REPLACEMENT**

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**ONE LINE DIAGRAM**

Sheet No.:  
**E4.01**

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