



DETAIL FOR LARGE DUCT RISER
NO SCALE

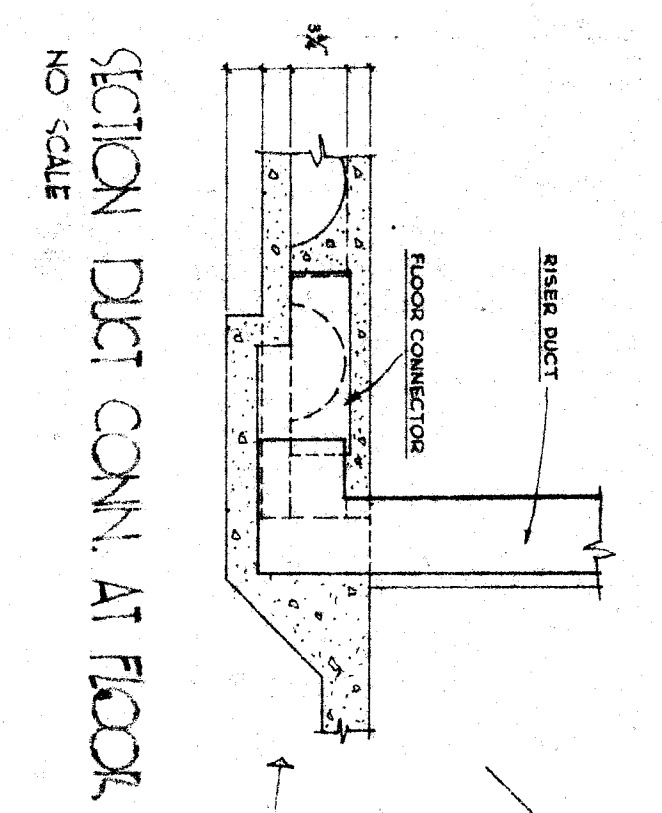


SECTION DUCT CONN. AT FLOOR
NO SCALE

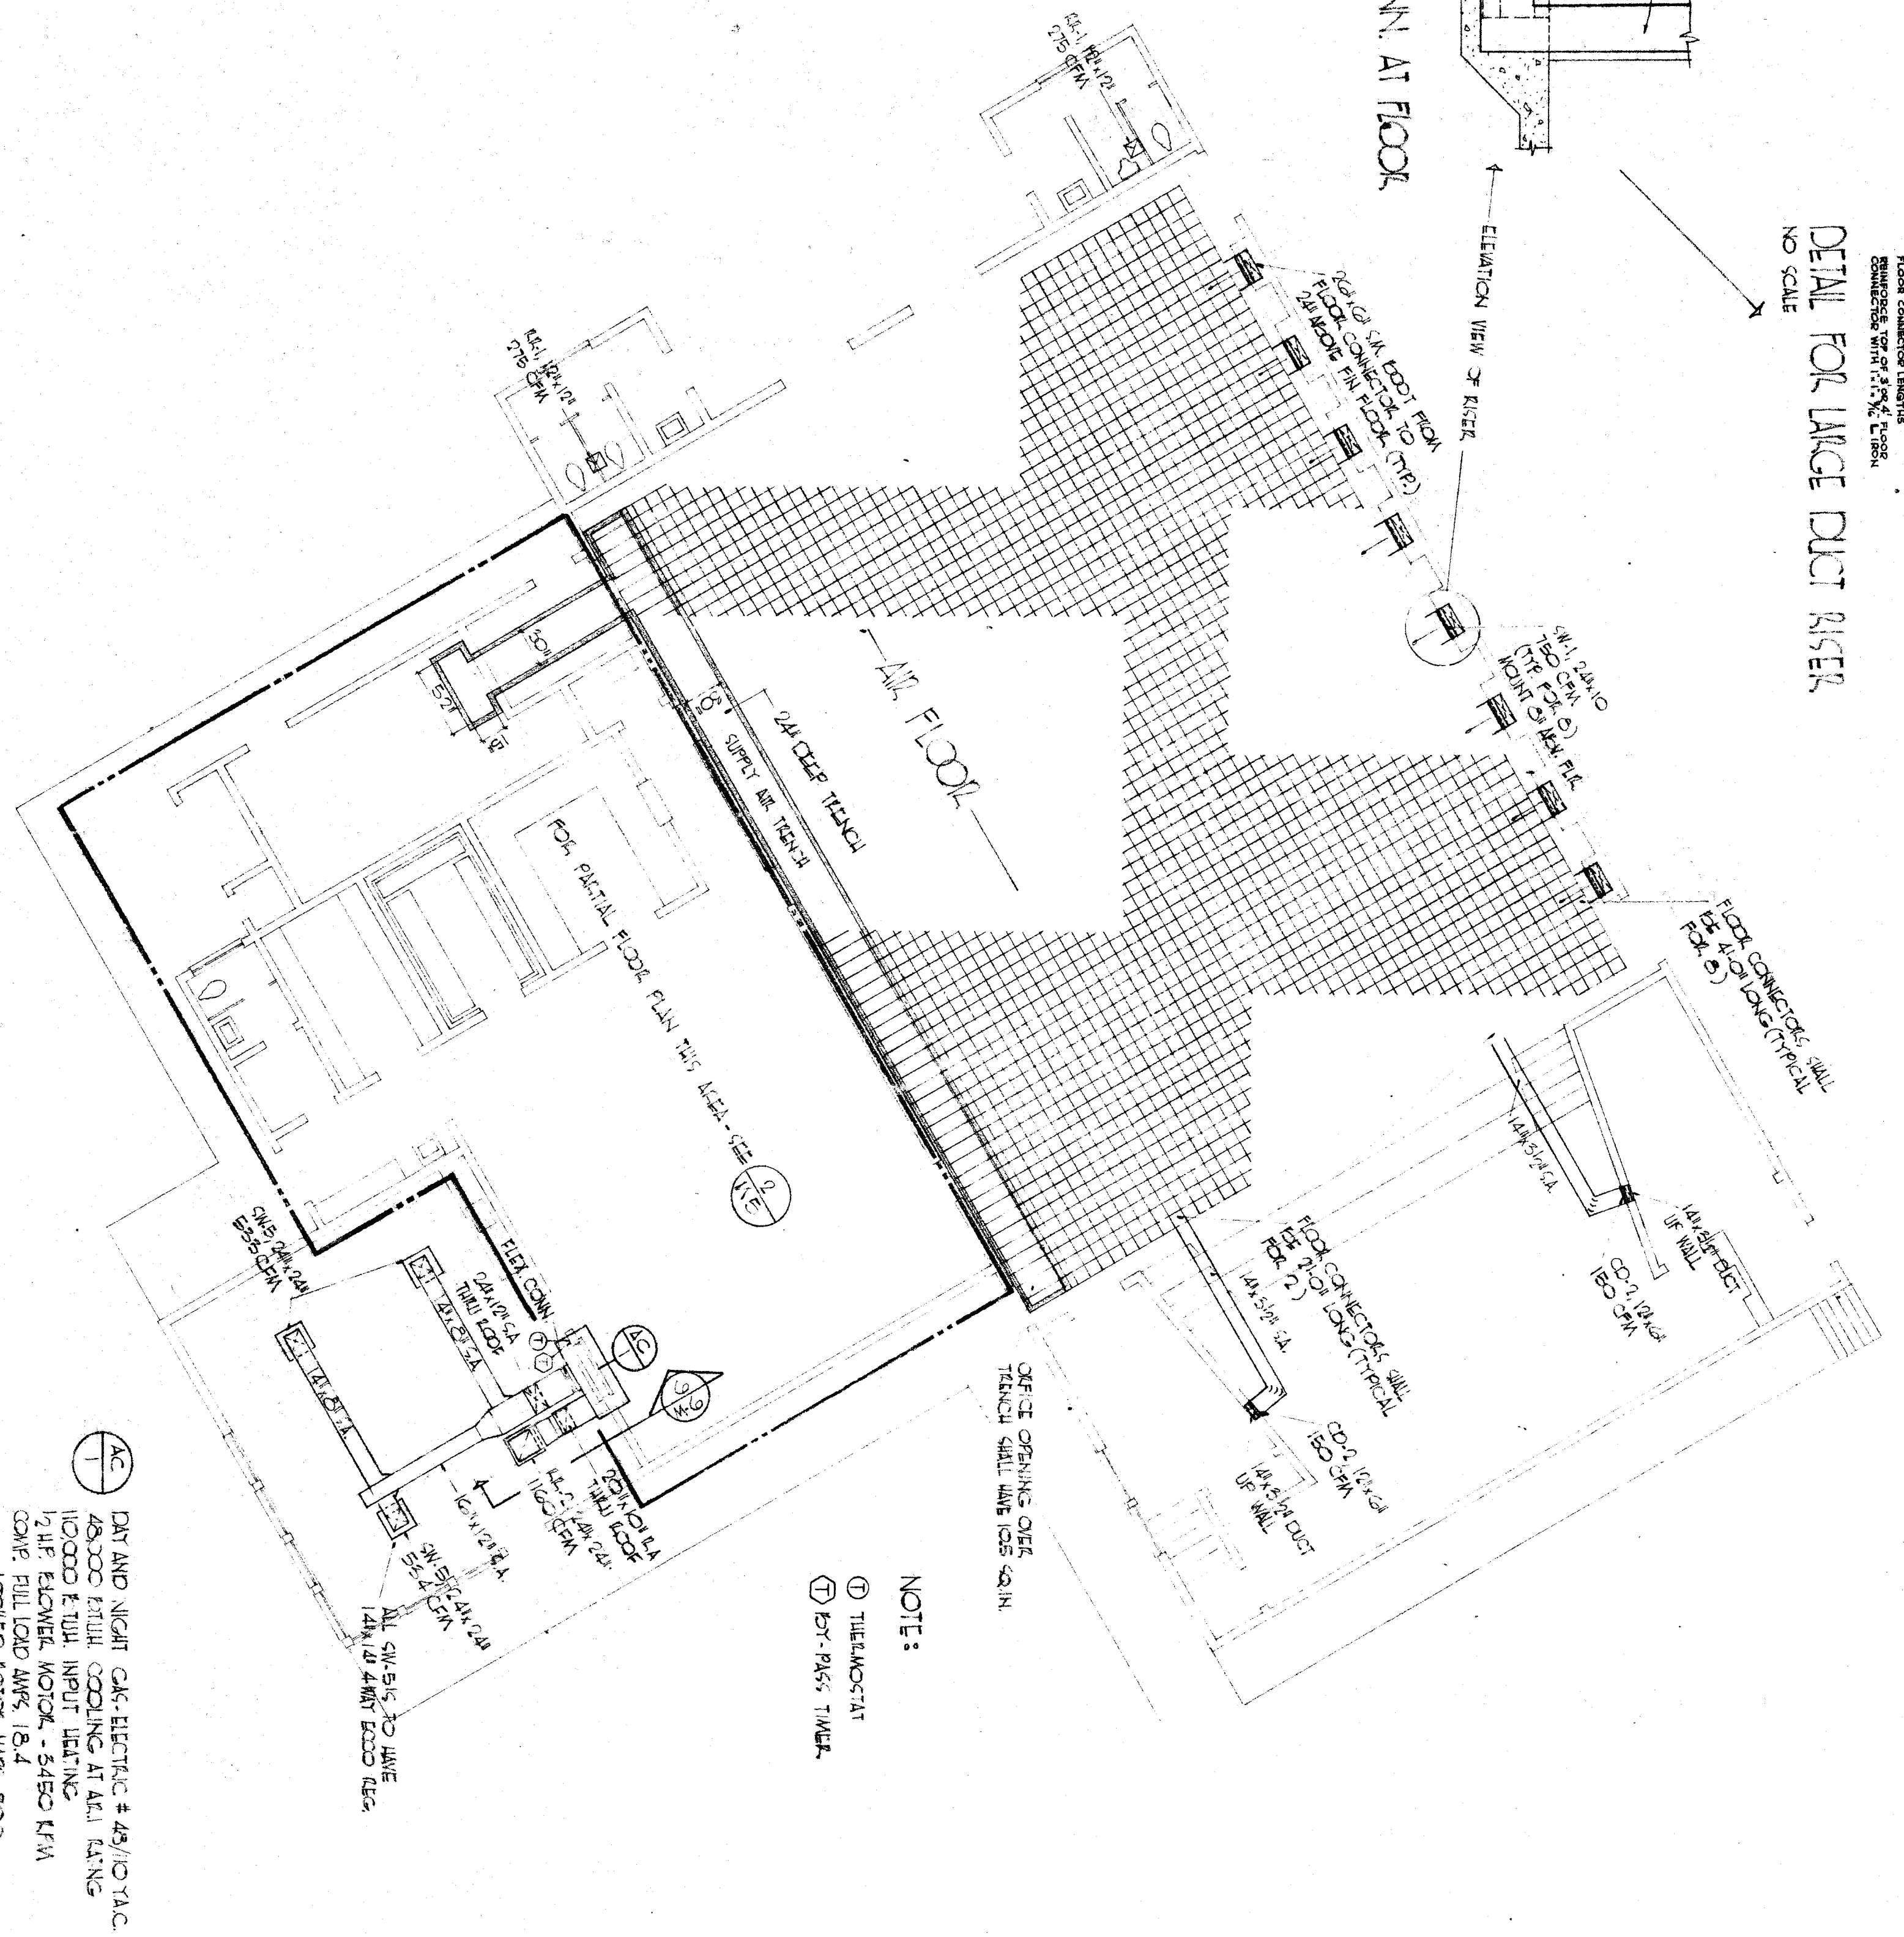

NOTE:
 ① THERMOSTAT
 ② EX. PASS. TUBE
 ③ DRY AND NEAR C.K. ELECTRIC & 49/10714.C
 ④ 140000 BTU/H COOLING AT 44.1 TONS
 ⑤ 140000 BTU/H HEATING AT 44.1 TONS
 ⑥ 140000 BTU/H COOLING AT 44.1 TONS
 ⑦ 140000 BTU/H HEATING AT 44.1 TONS
 ⑧ 140000 BTU/H COOLING AT 44.1 TONS
 ⑨ 140000 BTU/H HEATING AT 44.1 TONS
 ⑩ 140000 BTU/H COOLING AT 44.1 TONS
 ⑪ 140000 BTU/H HEATING AT 44.1 TONS
 ⑫ 140000 BTU/H COOLING AT 44.1 TONS
 ⑬ 140000 BTU/H HEATING AT 44.1 TONS
 ⑭ 140000 BTU/H COOLING AT 44.1 TONS
 ⑮ 140000 BTU/H HEATING AT 44.1 TONS
 ⑯ 140000 BTU/H COOLING AT 44.1 TONS
 ⑰ 140000 BTU/H HEATING AT 44.1 TONS
 ⑱ 140000 BTU/H COOLING AT 44.1 TONS
 ⑲ 140000 BTU/H HEATING AT 44.1 TONS
 ⑳ 140000 BTU/H COOLING AT 44.1 TONS
 ㉑ 140000 BTU/H HEATING AT 44.1 TONS
 ㉒ 140000 BTU/H COOLING AT 44.1 TONS
 ㉓ 140000 BTU/H HEATING AT 44.1 TONS
 ㉔ 140000 BTU/H COOLING AT 44.1 TONS
 ㉕ 140000 BTU/H HEATING AT 44.1 TONS
 ㉖ 140000 BTU/H COOLING AT 44.1 TONS
 ㉗ 140000 BTU/H HEATING AT 44.1 TONS
 ㉘ 140000 BTU/H COOLING AT 44.1 TONS
 ㉙ 140000 BTU/H HEATING AT 44.1 TONS
 ㉚ 140000 BTU/H COOLING AT 44.1 TONS
 ㉛ 140000 BTU/H HEATING AT 44.1 TONS
 ㉜ 140000 BTU/H COOLING AT 44.1 TONS
 ㉝ 140000 BTU/H HEATING AT 44.1 TONS
 ㉞ 140000 BTU/H COOLING AT 44.1 TONS
 ㉟ 140000 BTU/H HEATING AT 44.1 TONS
 ㊱ 140000 BTU/H COOLING AT 44.1 TONS
 ㊲ 140000 BTU/H HEATING AT 44.1 TONS
 ㊳ 140000 BTU/H COOLING AT 44.1 TONS
 ㊴ 140000 BTU/H HEATING AT 44.1 TONS
 ㊵ 140000 BTU/H COOLING AT 44.1 TONS
 ㊶ 140000 BTU/H HEATING AT 44.1 TONS
 ㊷ 140000 BTU/H COOLING AT 44.1 TONS
 ㊸ 140000 BTU/H HEATING AT 44.1 TONS
 ㊹ 140000 BTU/H COOLING AT 44.1 TONS
 ㊺ 140000 BTU/H HEATING AT 44.1 TONS
 ㊻ 140000 BTU/H COOLING AT 44.1 TONS
 ㊼ 140000 BTU/H HEATING AT 44.1 TONS
 ㊽ 140000 BTU/H COOLING AT 44.1 TONS
 ㊾ 140000 BTU/H HEATING AT 44.1 TONS
 ㊿ 140000 BTU/H COOLING AT 44.1 TONS

MULTI-PURPOSE HEATING AND VENTILATING FLOOR PLAN
 SCALE: 3/8"=1'-0"
 ①

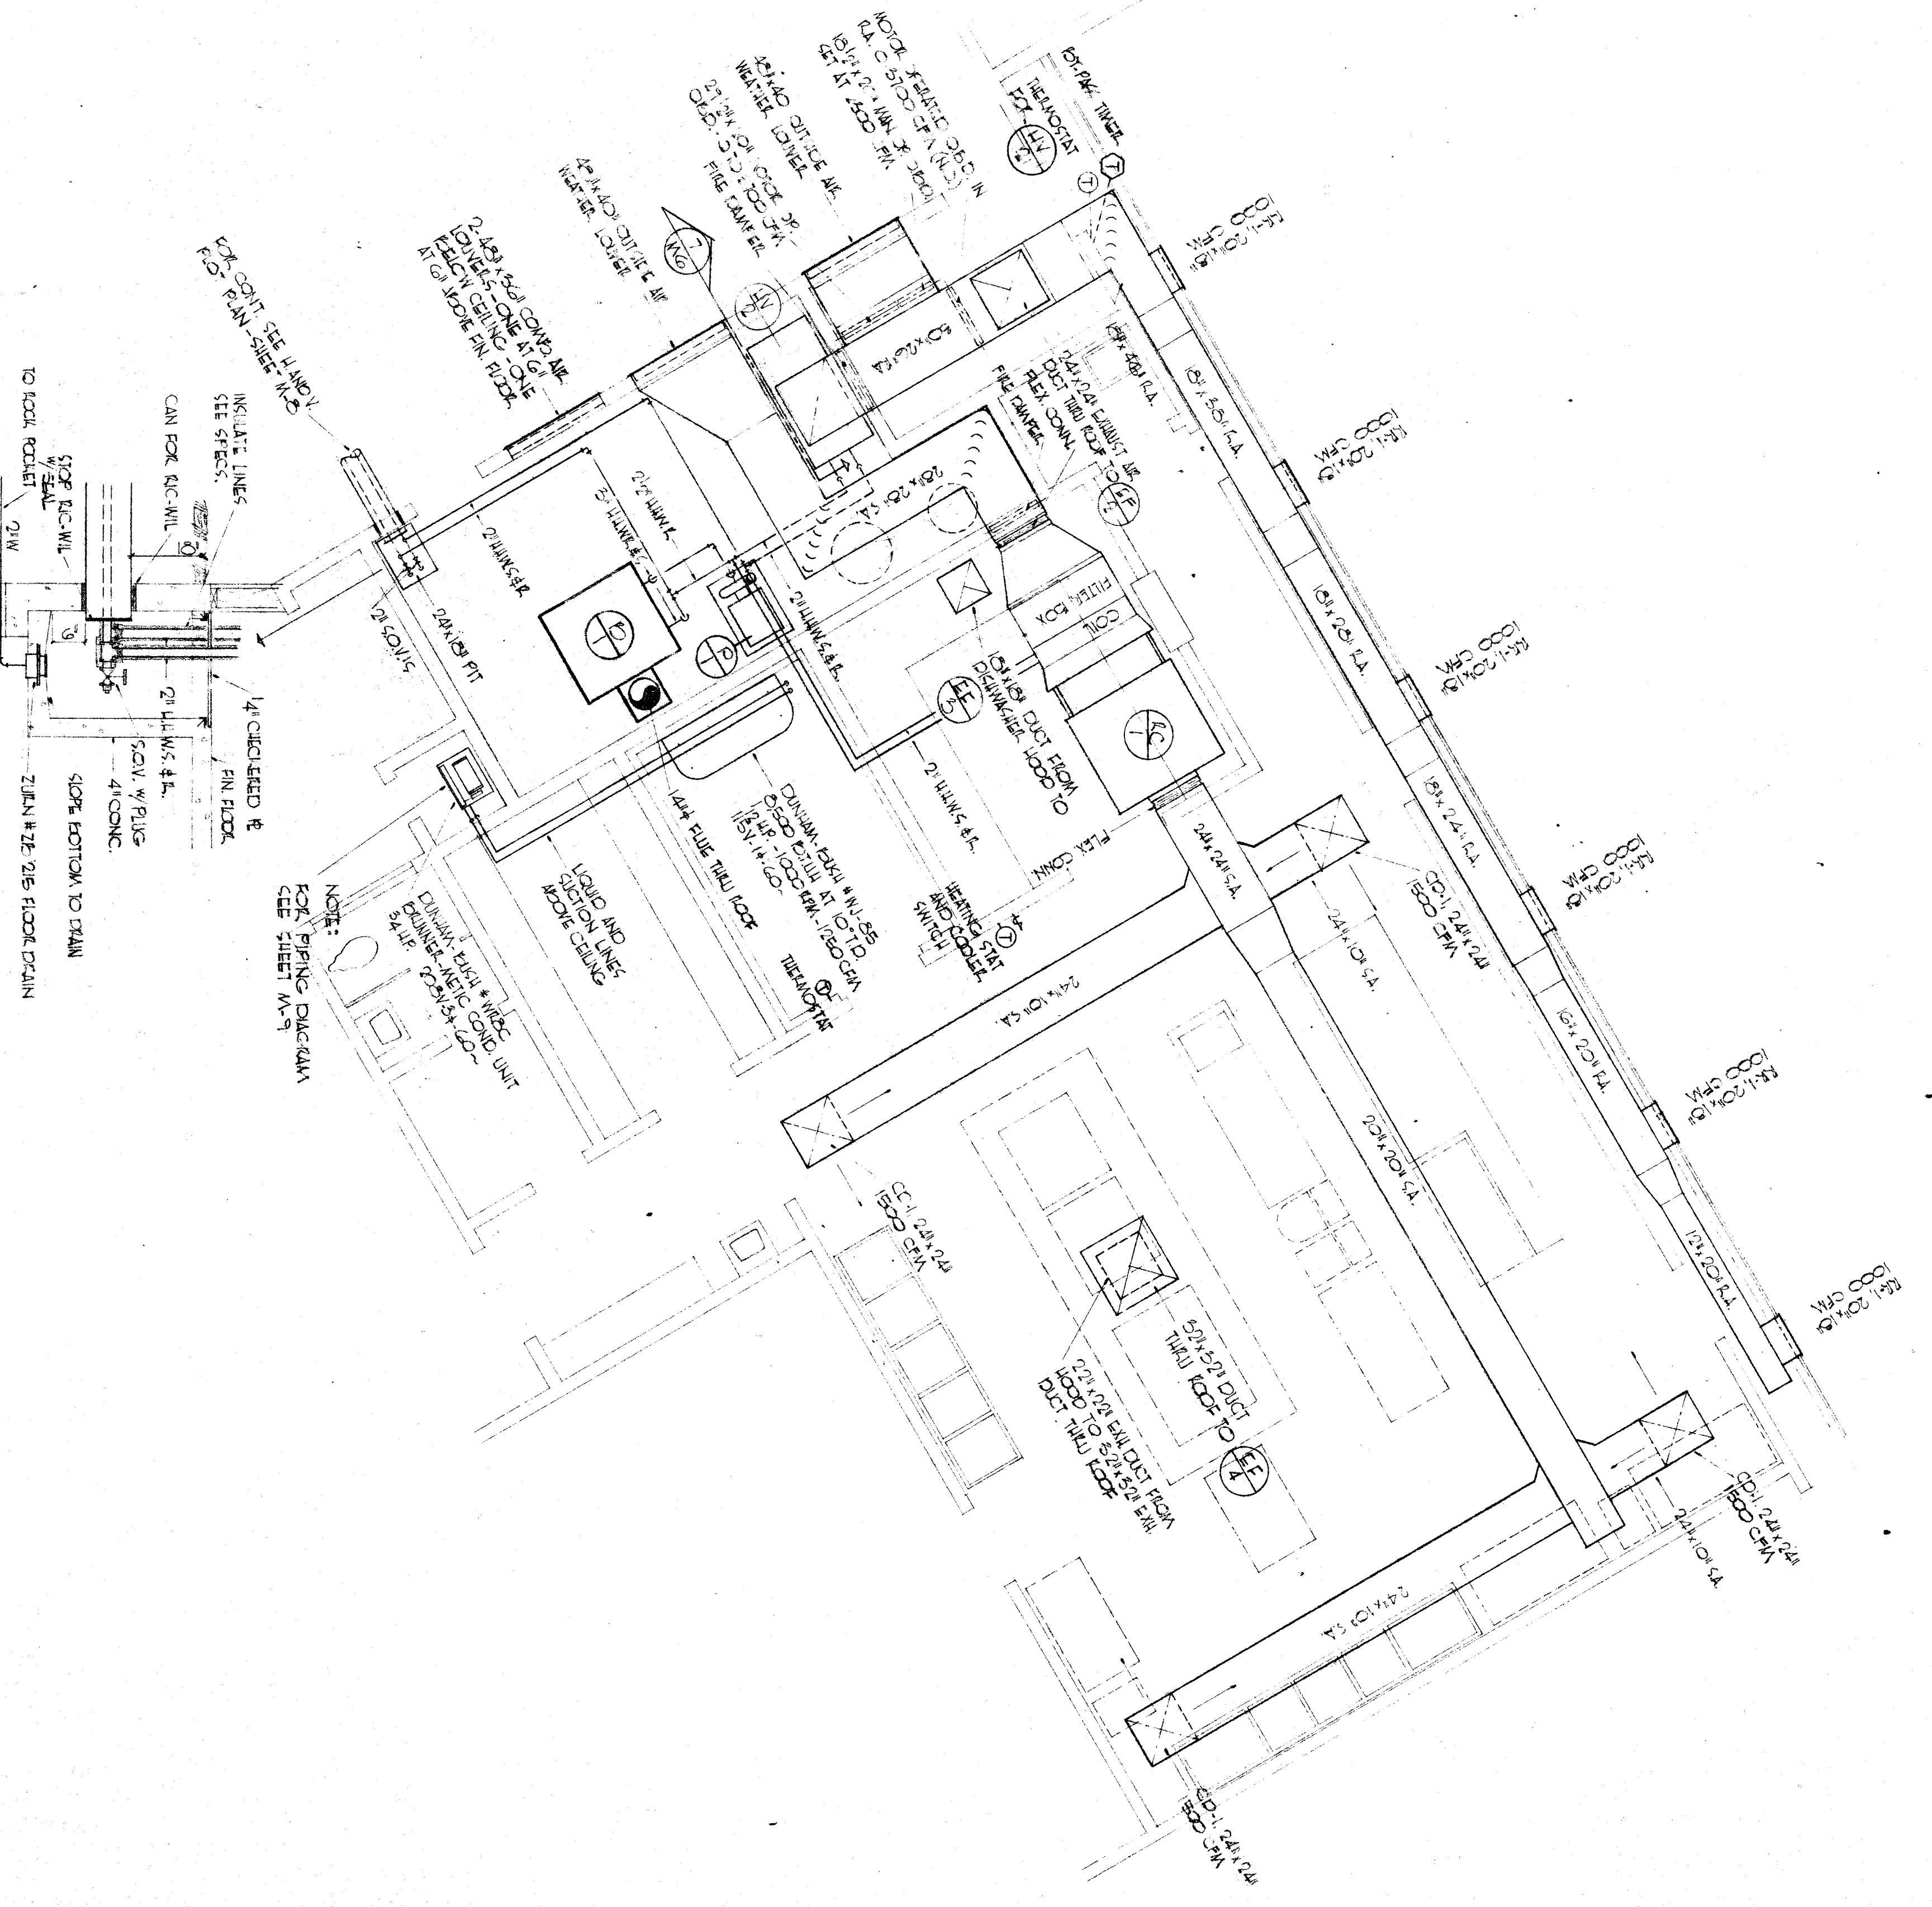

PARTIAL FLOOR PLAN - KITCHEN AREA
 SCALE: 3/8"=1'-0"
 ②

CHECK AND VERIFY ALL DIMENSIONS AND CONDITIONS AT JOB SITE BEFORE PROCEEDING WITH THE WORK.		REPORT ANY DISCREPANCIES TO THE ARCHITECT.		APPROVED - DATE	
SYMBOL	REVISIONS	DATE	BY	DATE	BY
AS BUILT	STATE OF CALIFORNIA	STATE FIRE MARSHAL	APPROVED UNDER STATUTE OF CALIFORNIA	5 5 09 P	APPROVED
CHANGES ORDER	BY				
CLASSIFICATION					
DRAWN BY: HICK, JACOBO		CHECKED BY: WILKINSON		APPROVED: ERNEST L. MCGOY A.I.A. ARCHITECT	
PROJECT: HENRY EISENBERG ELEMENTARY SCHOOL		LOCATION: BAKERSFIELD, CALIFORNIA		SHEET NO. 63-17	
DATE: 11/11/54		SCALE: 3/8"=1'-0"		DRAWN BY: HICK, JACOBO	
PROJECT NO. 54-11		SHEET NO. 63-17		DATE: 11/11/54	