MODULAR CLASSROOM BUILDINGS

BY SILVER CREEK INDUSTRIES, INC.

2830 BARRETT AVE, PERRIS, CALIFORNIA 92571 PHONE: (951) 943-5393 FAX: (951) 943-2211

STOCKPILE 24' x 40' OFFICE BUILDING


GENERAL NOTES BUILDING DATA NUMBER OF STORIES: 1 - STORY OCCUPANCY: E: 24' x 40' OFFICE BUILDINGS TYPE OF CONSTRUCTION VB ☐ 50 PSF ☐ 50+15 PSF PARTITION LOAD FLOOR LIVE LOAD: ▼ 100 PSF □ 150 PSF ROOF LIVE LOAD: ₩ WOOD FLOOR - 8 PSF ☐ CONC FLOOR - 33 PSF FLOOR DEAD LOAD: SEE PC SHEET 17 PSF (INCLUDING SPRINKLER LOAD) ROOF DEAD LOAD: RAMP LIVE LOAD: A-0 24'x40' BLDG - 960 SF/1140 SF 84'x40' BLDG - 3360 SF/3990 SF BUILDING AREA: ☐ 36'x40' BLDG - 1440 SF/1710 SF ☐ 96'x40' BLDG - 3840 SF/4560 SF OVERHANGS / AREA ☐ 48'x40' BLDG - 1920 SF/2280 SF ☐ 108'x40' BLDG - 4320 SF/5130 SF ☐ 60'x40' BLDG - 2400 SF/2850 SF ☐ 120'x40' BLDG - 4800 SF/5700 SF ALLOWABLE AREA = 9000 SF ₩OOD □ CONCRETE FOUNDATION: CEC CLIMATE ZONES: 1- 16 WIND DESIGN DATA SECTION 1603.A.1.4 SEE PC SHEET A-0 APPLICABLE STANDARDS EARTHQAUKE DESIGN DATA SEE PC SHEET A-0 APPLICABLE CODES


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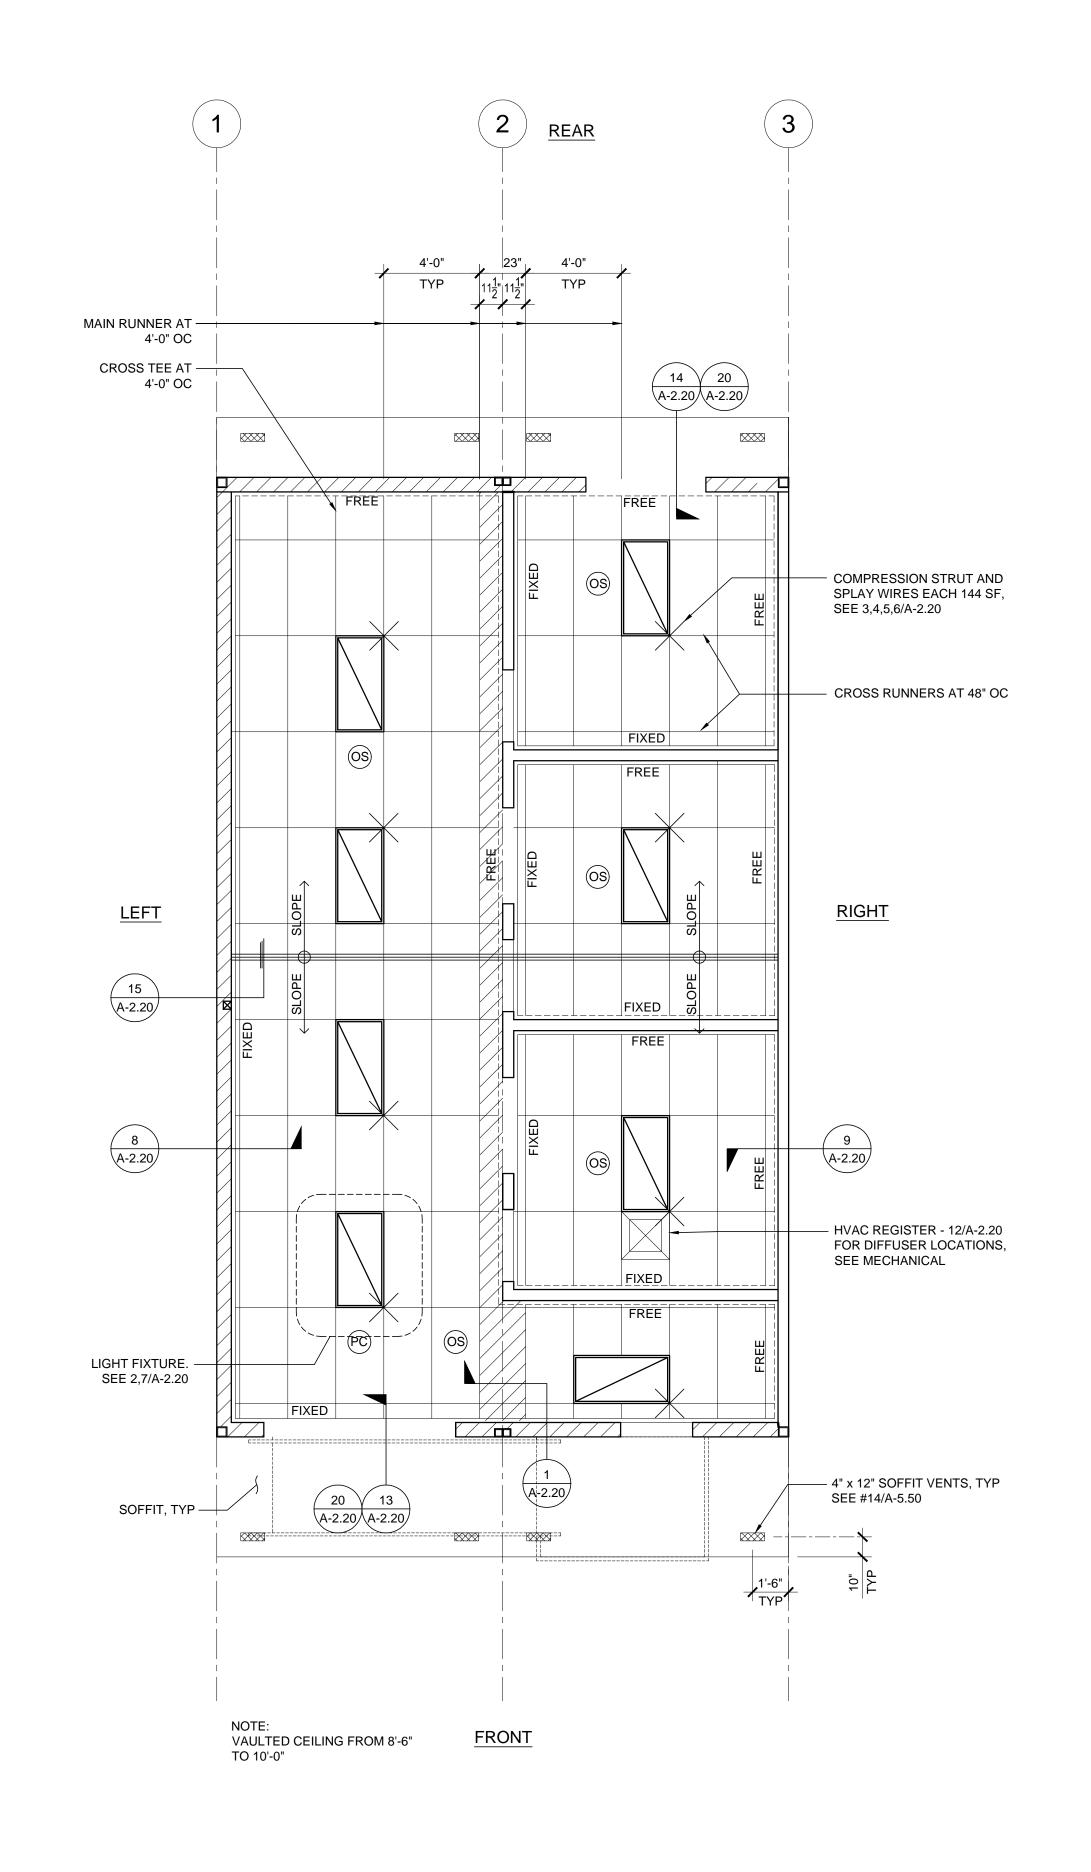
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| PROJECT # 10914 PROJEC | | A-0 N | PROJECT SPECIFIC COVER SHEET | A-0 | COVER SHEET | THEREOF WITHOUT THE FULL KNOWLEDGE AND WRITTEN |
| PROJECT 2 10914 Separate Se | | A-0.2 N | PROJECT SPECIFIC SCHEDULES | | | ALL PATENTABLE MATERIAL CONTAINED HEREIN AND |
| PROJECT # 10014 PROJEC | | A-1.01 N | PROJECT SPECIFIC FLOOR PLAN - 24'x40' | | | ORIGINATING WITH SCI Inc SHALL BE THE PROPERTY OF SCI Inc |
| The content of the | | A-2 11 N | PRO IECT SPECIFIC REFLECTED CEILING PLAN | | | SILVER CREEK INDUSTRIES INC |
| ### PROJECT # 10014 #### PROJECT # 10014 ##### PROJECT # 10014 ################################# | | | | A-0.5A | ENERGY CALC'S - PRF FORMS - ZONE 14 WORST CASE | |
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| ### PROJECT # 10914 PR | | | | A-0.6F | ENERGY CALC'S - LTI FORMS - 120' x 40' BUILDINGS | |
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| PROJECT # 10914 PROJECT BENTILLENG CO. M. | | 5П NO. | ELECTRICAL | | <u>-</u> | 24x40 STOCKPILE |
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| PROJECT # 10914 PROJEC | | | | | | OFFICE BUILDING |
| PROJECT # 10914 SIT NO. FOUNDATION COVER SHEET PROJECT # 10914 SIT NO. STRUCTURAL SALE SHAPE SHOWN FOR THE SHAPE SHOP SHOP SHAPE | | | | A-5.81 | ARCHITECTURAL DETAILS - MISC/OPTIONS | |
| PROJECT # 10914 PROJECT # 10914 SHT NO. STRUCTURAL SS. BILL SECTION SCHOOL STRUCK SST NO. STRUCTURAL SS. BILL SECTION SCHOOL STRUCK SST NO. STRUCTURAL SS. BILL SECTION SCHOOL STRUCK SS. BILL SECTION SCHOOL STRUCK SS. BILL SECTION SCHOOL SCHOOL SS. BILL SECTION S | | | | A-6.01 | INTERIOR ELEVATIONS 24'x40' | SHEET TITLE: |
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| SHT NO | | | | F-0.03 | WOOD FOUNDATION PLAN - 24'x40' (100 PSF) | |
| SHI NO. STRUCTURAL STRUCTURAL | | | | F-0.50 | FOUNDATION DETAILS - WOOD | |
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| SET IN CONTROL OF THE | | | | S-1.01 | FLOOR FRAMING PLAN - WOOD FLOOR | |
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| SHT NO. ELECTRICAL E101 H-BCHNICAS PHAN - 245807 SHT NO. RAMP R. 1.D1 STANDARD RAMP PLAN R. 2.D1 RAMP BETALS ORIGINAL PC STATE AGENCY APPROVAL A REVISIONS A A A A A A A A A A A A A A A A A A A | | | | M-0.1 | MECHANICAL NOTES, SCHEDULES AND DETAILS | PROJECT SPECIFIC STATE AGENCY APPROVAL |
| E-1.07 ELECTRICAL PLAN-24940 SHT NO. RAMP H-1.01 STANDARD RAMP DEFAILS REVISIONS A A A A A A A A A A A A A | | | | M-1.01 | MECHANICAL PLAN - WALL MOUNT - 24'x40' | |
| SHT NO. RAMP 8-101 STANDARD HAMP PLAN REVISIONS A A A SILVER CREEK INDUSTRIES PROJECT NO. 10014 BRAWN DEF. BRAWN DEF. BRAWN DEF. SILVER CREEK INDUSTRIES PROJECT NO. 10014 BRAWN DEF. BRAWN DEF. BRAWN DEF. SILVER CREEK INDUSTRIES PROJECT NO. 10014 BRAWN DEF. BRAWN DEF. SILVER CREEK INDUSTRIES PROJECT NO. 10014 BRAWN DEF. BRAWN DEF. SILVER CREEK INDUSTRIES PROJECT NO. 10014 BRAWN DEF. BRAWN DEF. SILVER CREEK INDUSTRIES PROJECT NO. 10014 BRAWN DEF. SILVER CREEK INDUSTRIES BRAWN DEF. BRAWN DEF. SILVER CREEK INDUSTRIES BRAWN DEF. SILVER CREEK INDUSTRIES BRAWN DEF. BRAWN | | | | SHT NO. | ELECTRICAL | |
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| R 101 SIANDARD MAMP PLAN R 201 RAMP DETAILS REVISIONS | | | | ⊏-1.01 | ELECTRICAL PLAN - 24'X40' | |
| R201 MAMP DETAILS REVISIONS REVISIONS A A B SILVER CREEK INDUSTRIES PROJECT NO: 10014 DRAWN BY: SCALE: AS NOTED DATE: 04-20-17 SHEET NUMBER | | | | SHT NO. | RAMP | |
| R201 MAMP DETAILS REVISIONS REVISIONS A A B SILVER CREEK INDUSTRIES PROJECT NO: 10014 DRAWN BY: SCALE: AS NOTED DATE: 04-20-17 SHEET NUMBER | | | | R-1 01 | STANDARD RAMD DI ANI | ORIGINAL PC STATE AGENCY APPROVAI |
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2830 BARRETT AVE. PERRIS, CALIFORNIA 92571 PHONE: 951-943-5393 FAX: 951-943-2211

PROJECT NAME:

24x40 STOCKPILE OFFICE BUILDING

SHEET TITLE:

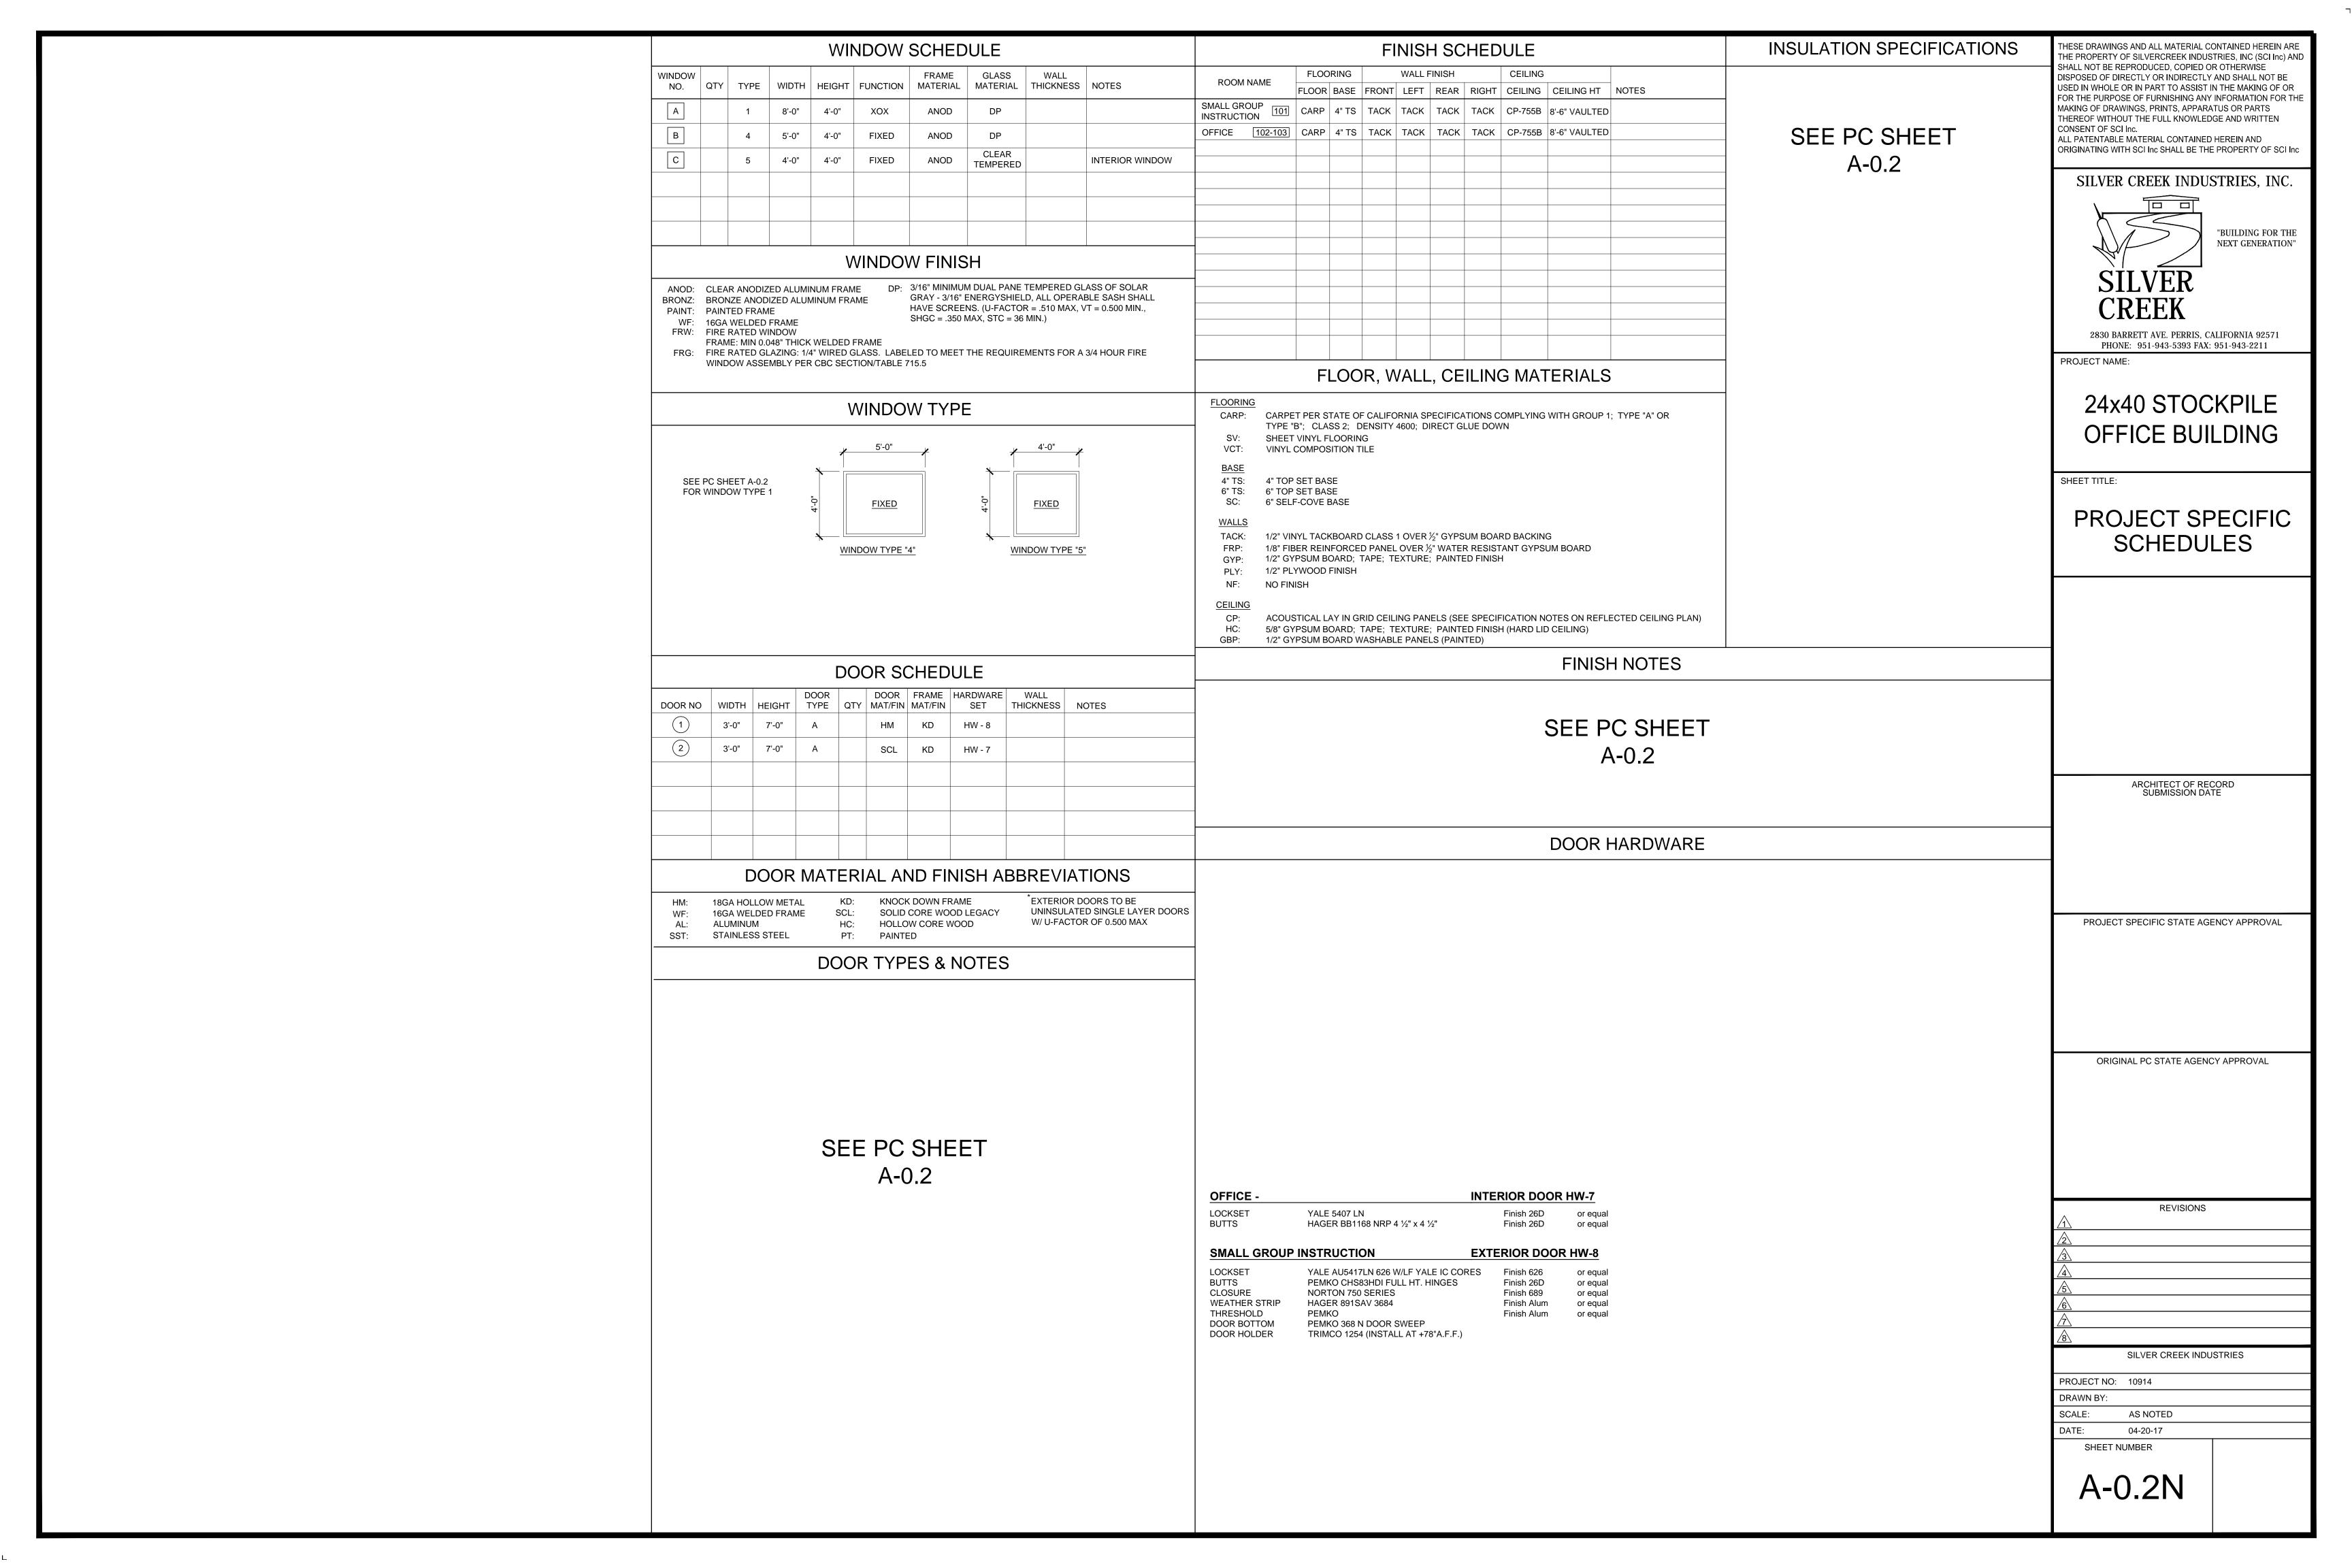PROJECT SPECIFIC REFELECTED CEILING

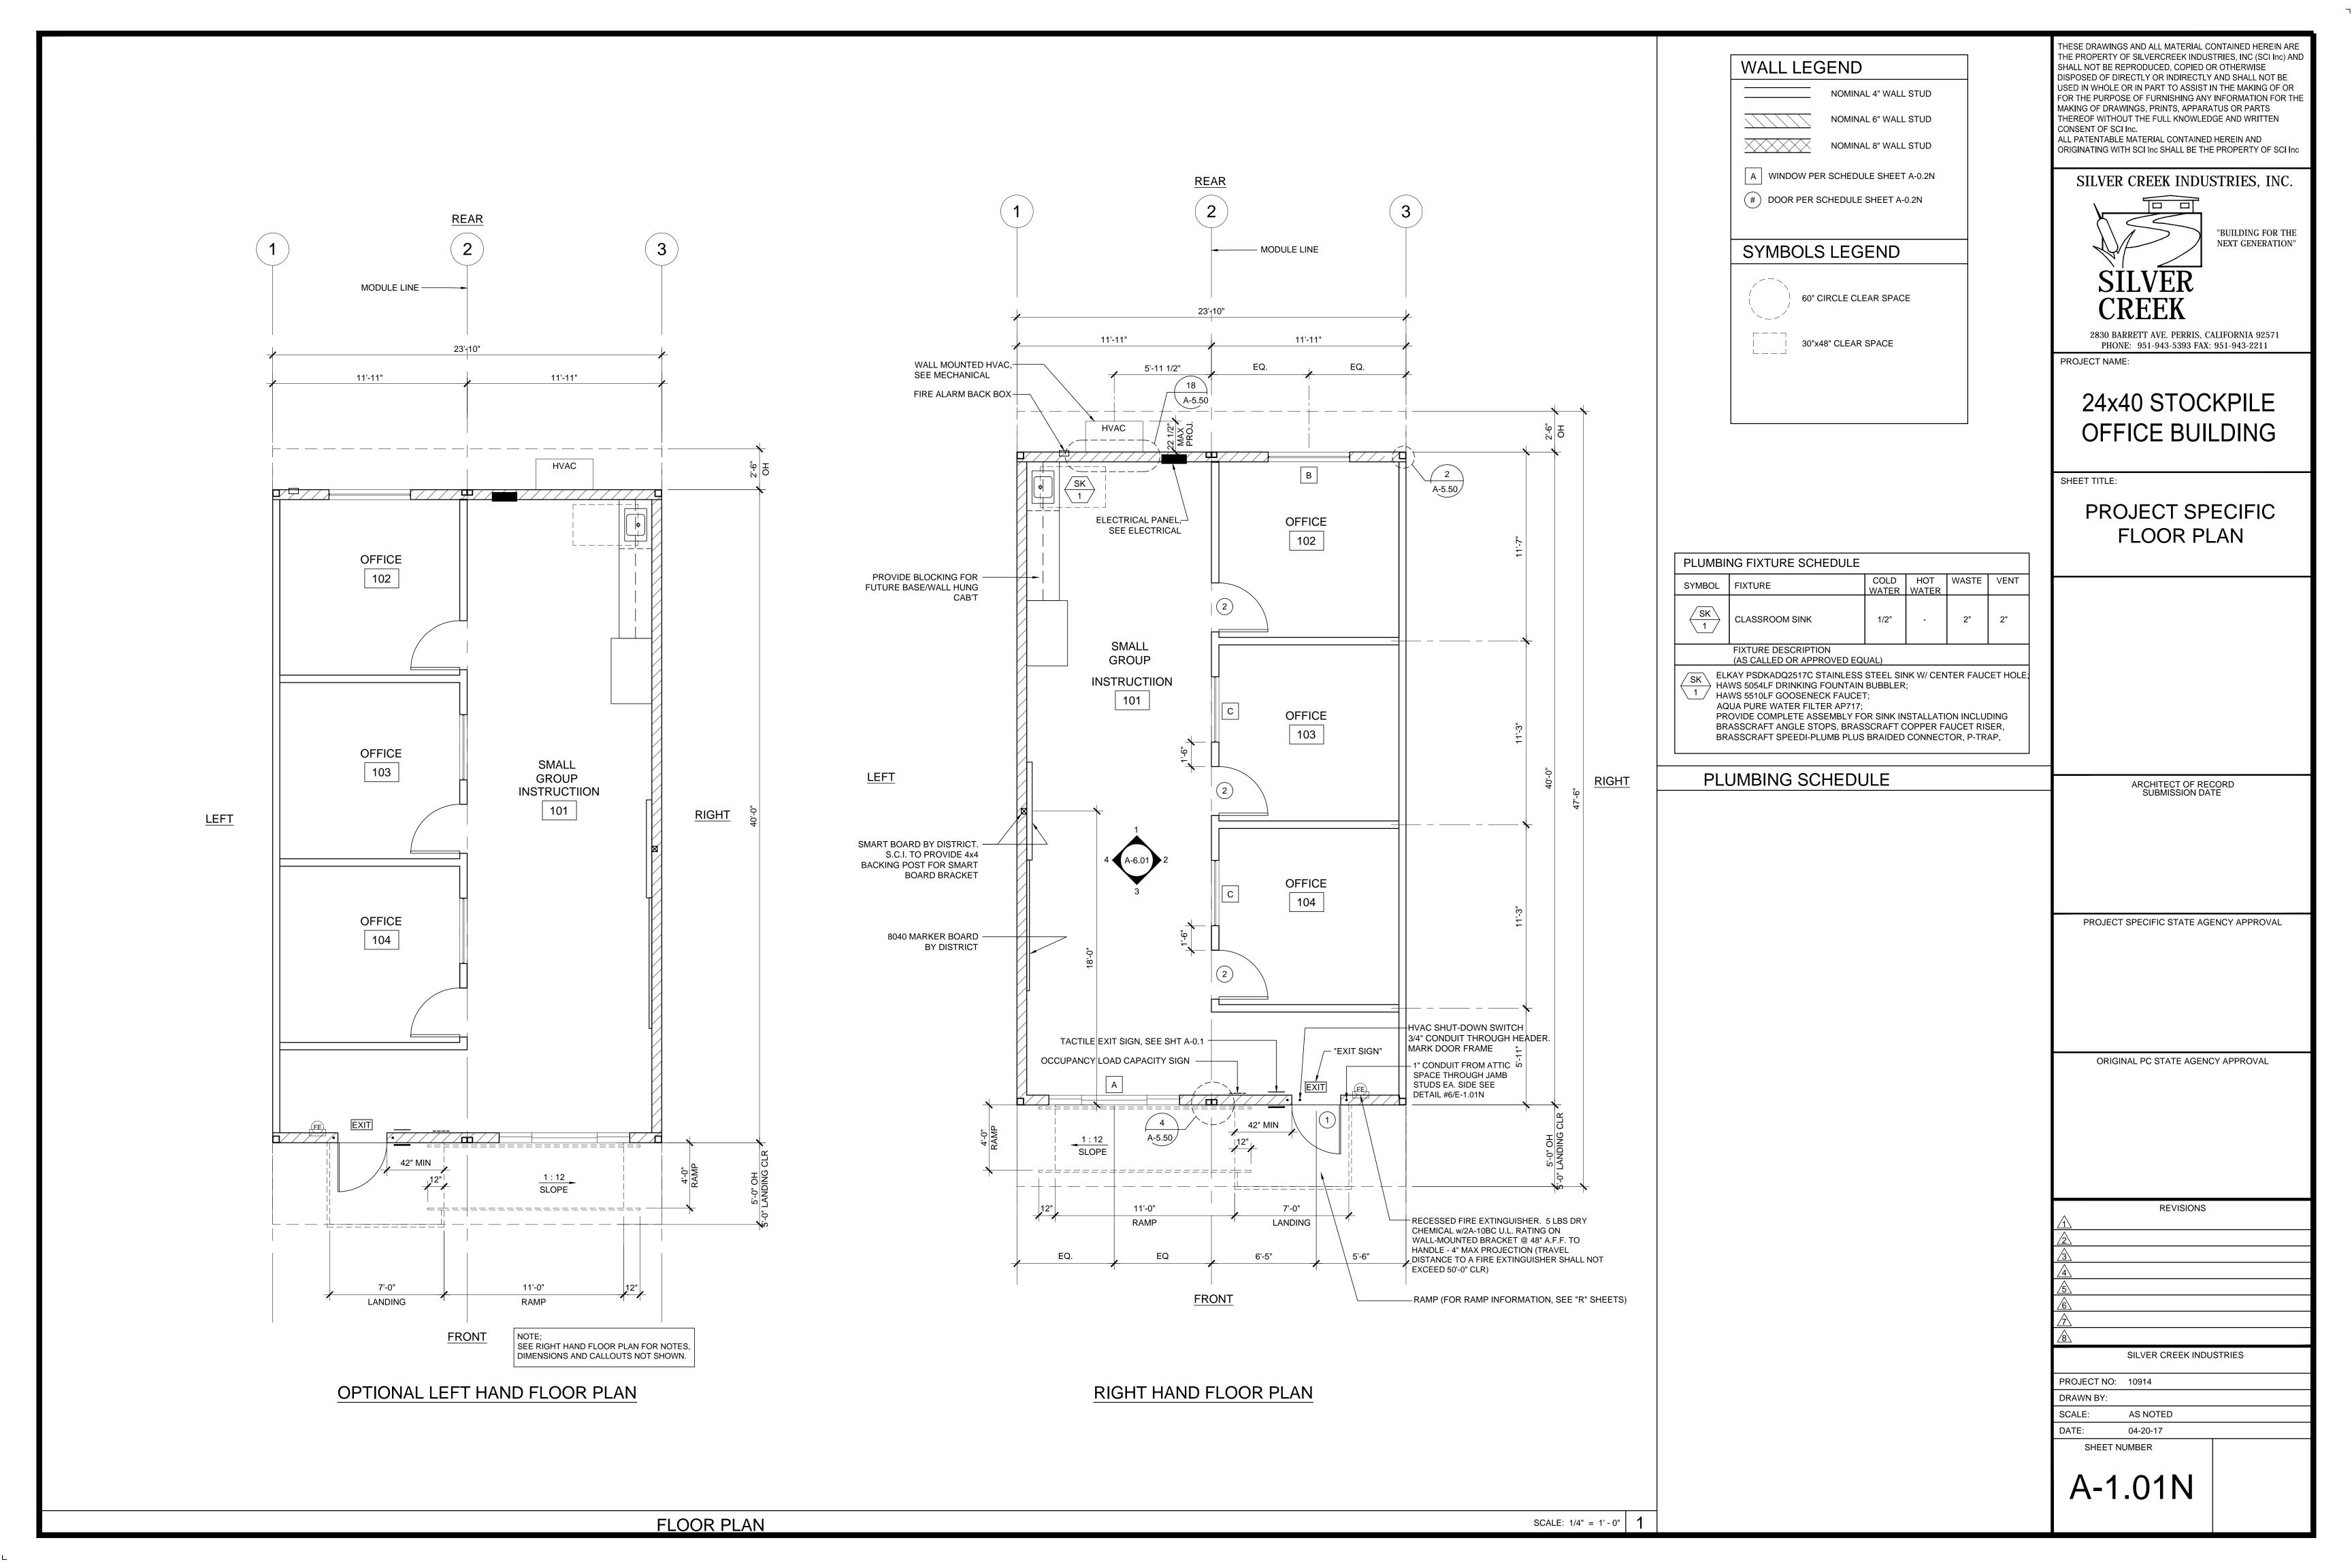ARCHITECT OF RECORD SUBMISSION DATE

PROJECT SPECIFIC STATE AGENCY APPROVAL

ORIGINAL PC STATE AGENCY APPROVAL

REVISIONS SILVER CREEK INDUSTRIES


PROJECT NO: 10914 DRAWN BY: AS NOTED

SHEET NUMBER

04-20-17

REFLECTED CEILING PLAN

SCALE: 1/4" = 1'-0" **1**

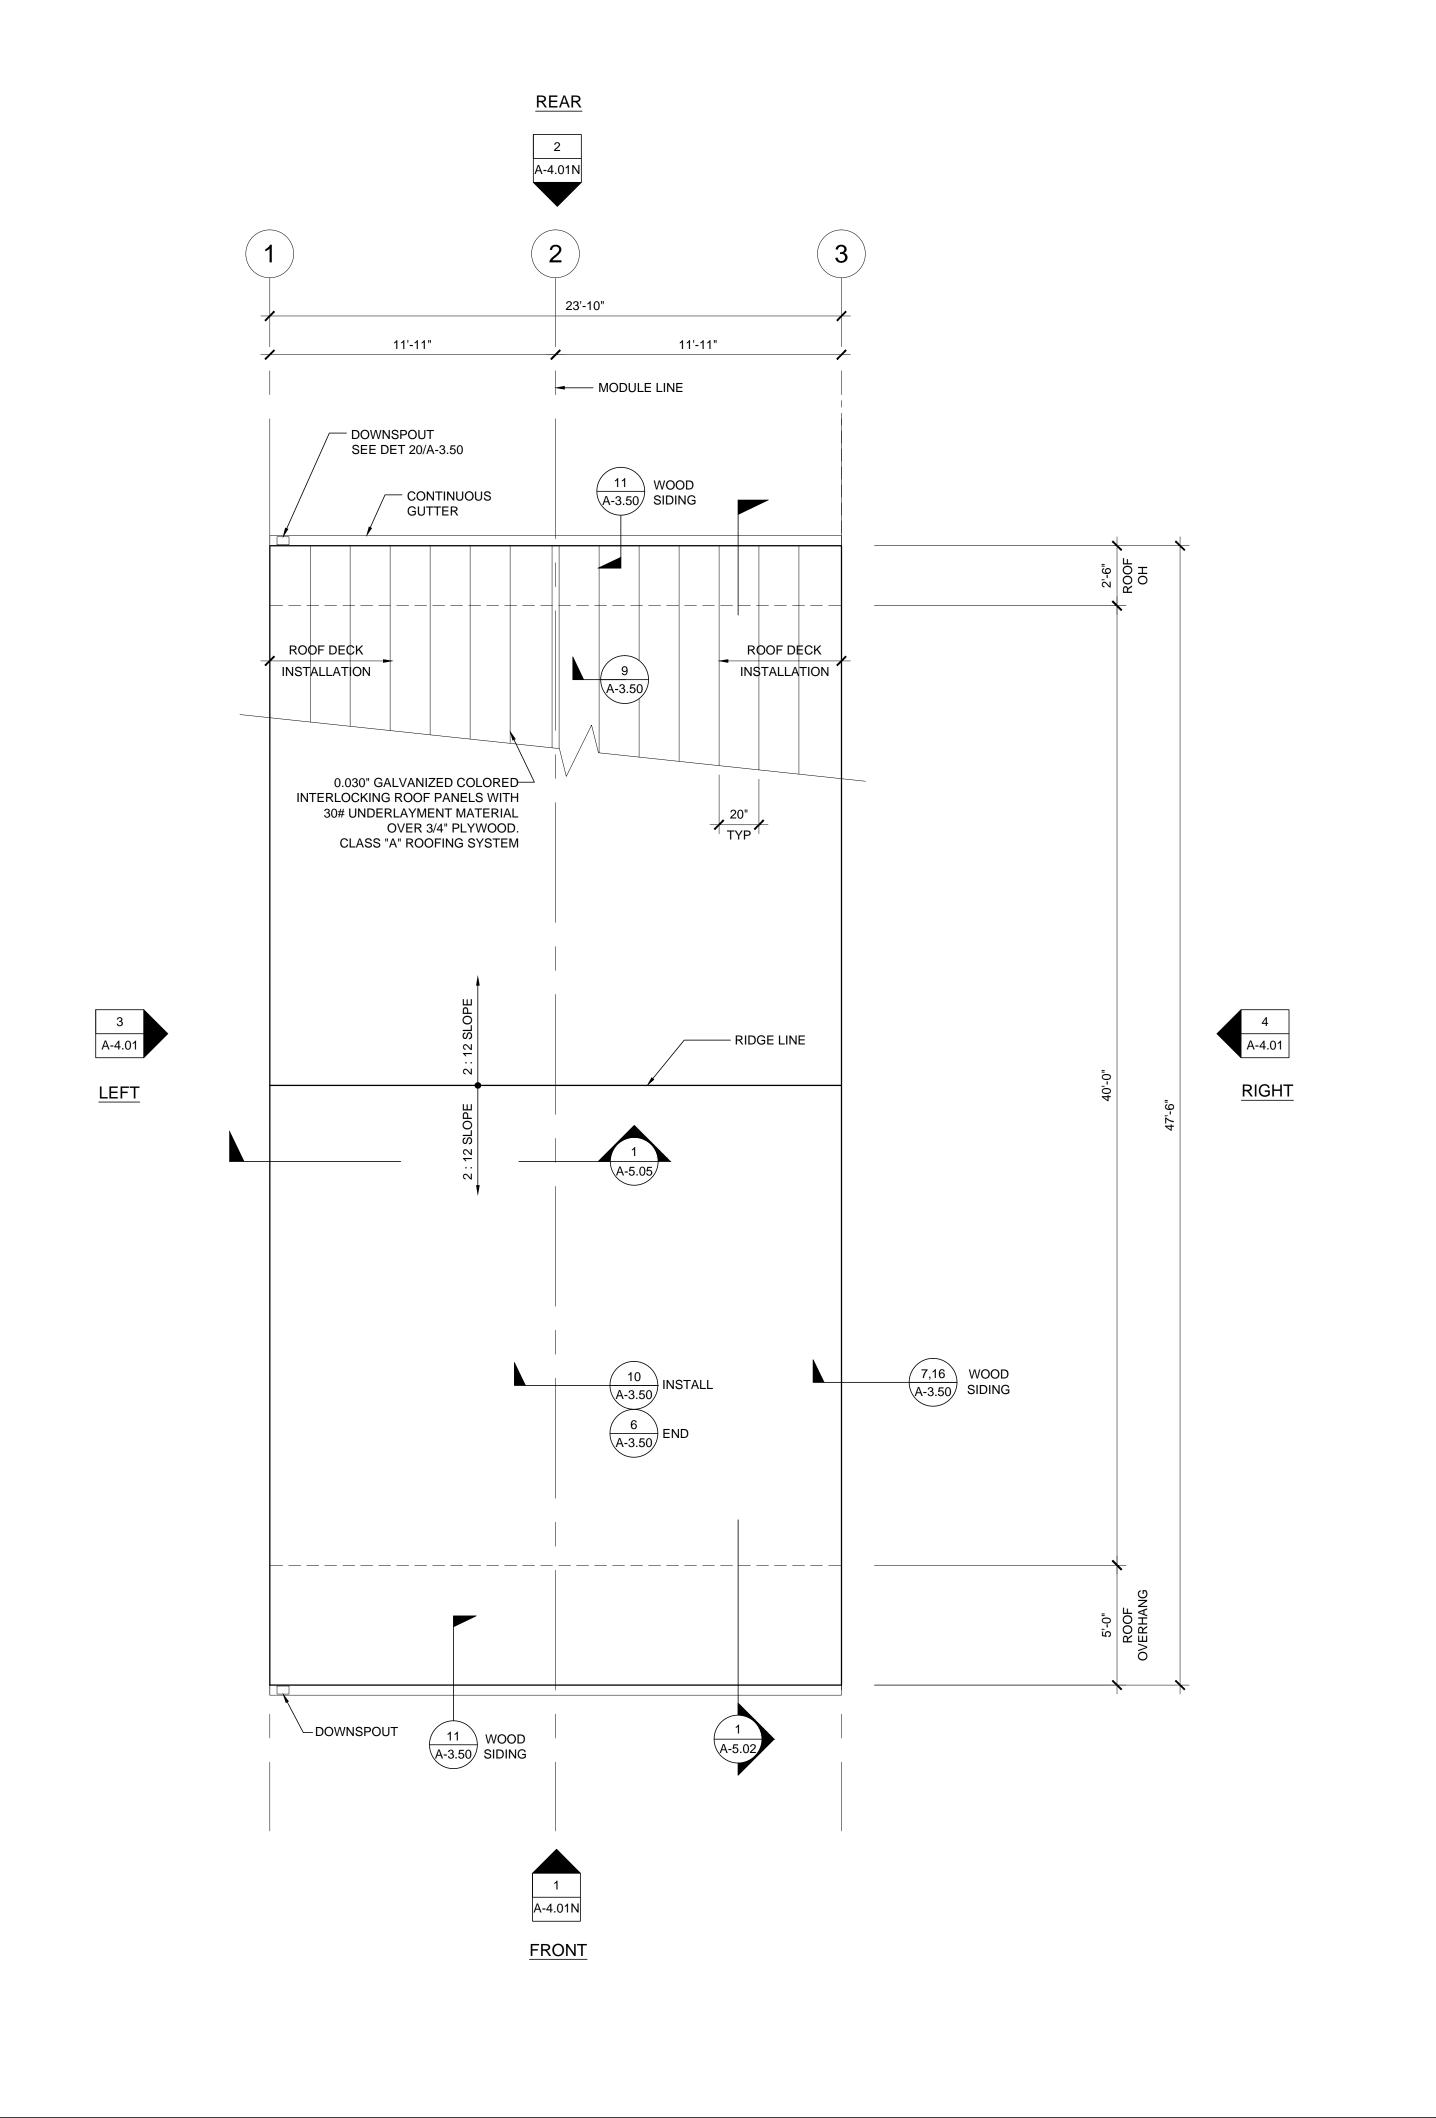

NOTES

- BUILDINGS SHALL HAVE ROOF COVERINGS AS SPECIFIED IN CBC TABLE 1505.1 - CLASS A.
- LOCATIONS OF DRAFTSTOP AND/OR FULL HEIGHT PARTITIONS AS REQUIRED PER CBC-718.4.3 SHALL BE SHOWN ON PROJECT SPECIFIC PLANS LOCATED AT MODULE

CBC 2016 SECTIONS 1015.6 & 1015.7.

- . ALL ROOFTOP EQUIPMENT THAT REQUIRES SERVICE & ROOF ACCESS HATCHES MUST BE A MIN. OF 10'-0" AWAY FROM ALL ROOF EDGES TO OPENING EDGES.
- FOR SPECIFIC DOWNSPOUT LOCATIONS FOR VARIOUS BUILDING SIZES, SEE KEY PLANS ON SHEET A-0.3. LOCATE ONE (1) DOWNSPOUT FOR EVERY THREE (3) MODULES
- ANY BUILDING OVER 3,000 SQ/FT REQUIRES A DRAFT STOP UNLESS BUILDING IS EQUIPPED WITH FIRE SPRINKLERS.
- WHEN PARAPETS ARE REQUIRED BECAUSE OF FIRE SEPARATION REQUIREMENTS AND/OR PROJECT SPECIFICATIONS, PROVIDE PARAPET PER CBC SECT. 705.11.

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PROJECT NAME:

24x40 STOCKPILE OFFICE BUILDING

SHEET TITLE:

PROJECT SPECIFIC **ROOF PLAN** 24'x40' - 0.030" METAL DECK

ARCHITECT OF RECORD SUBMISSION DATE

PROJECT SPECIFIC STATE AGENCY APPROVAL

ORIGINAL PC STATE AGENCY APPROVAL

REVISIONS SILVER CREEK INDUSTRIES

04-20-17 SHEET NUMBER


PROJECT NO: 10914


A-3.01N


AS NOTED

ROOF PLAN - 0.018" METAL DECK - DUAL SLOPE

SCALE: 1/4" = 1'-0" **1**

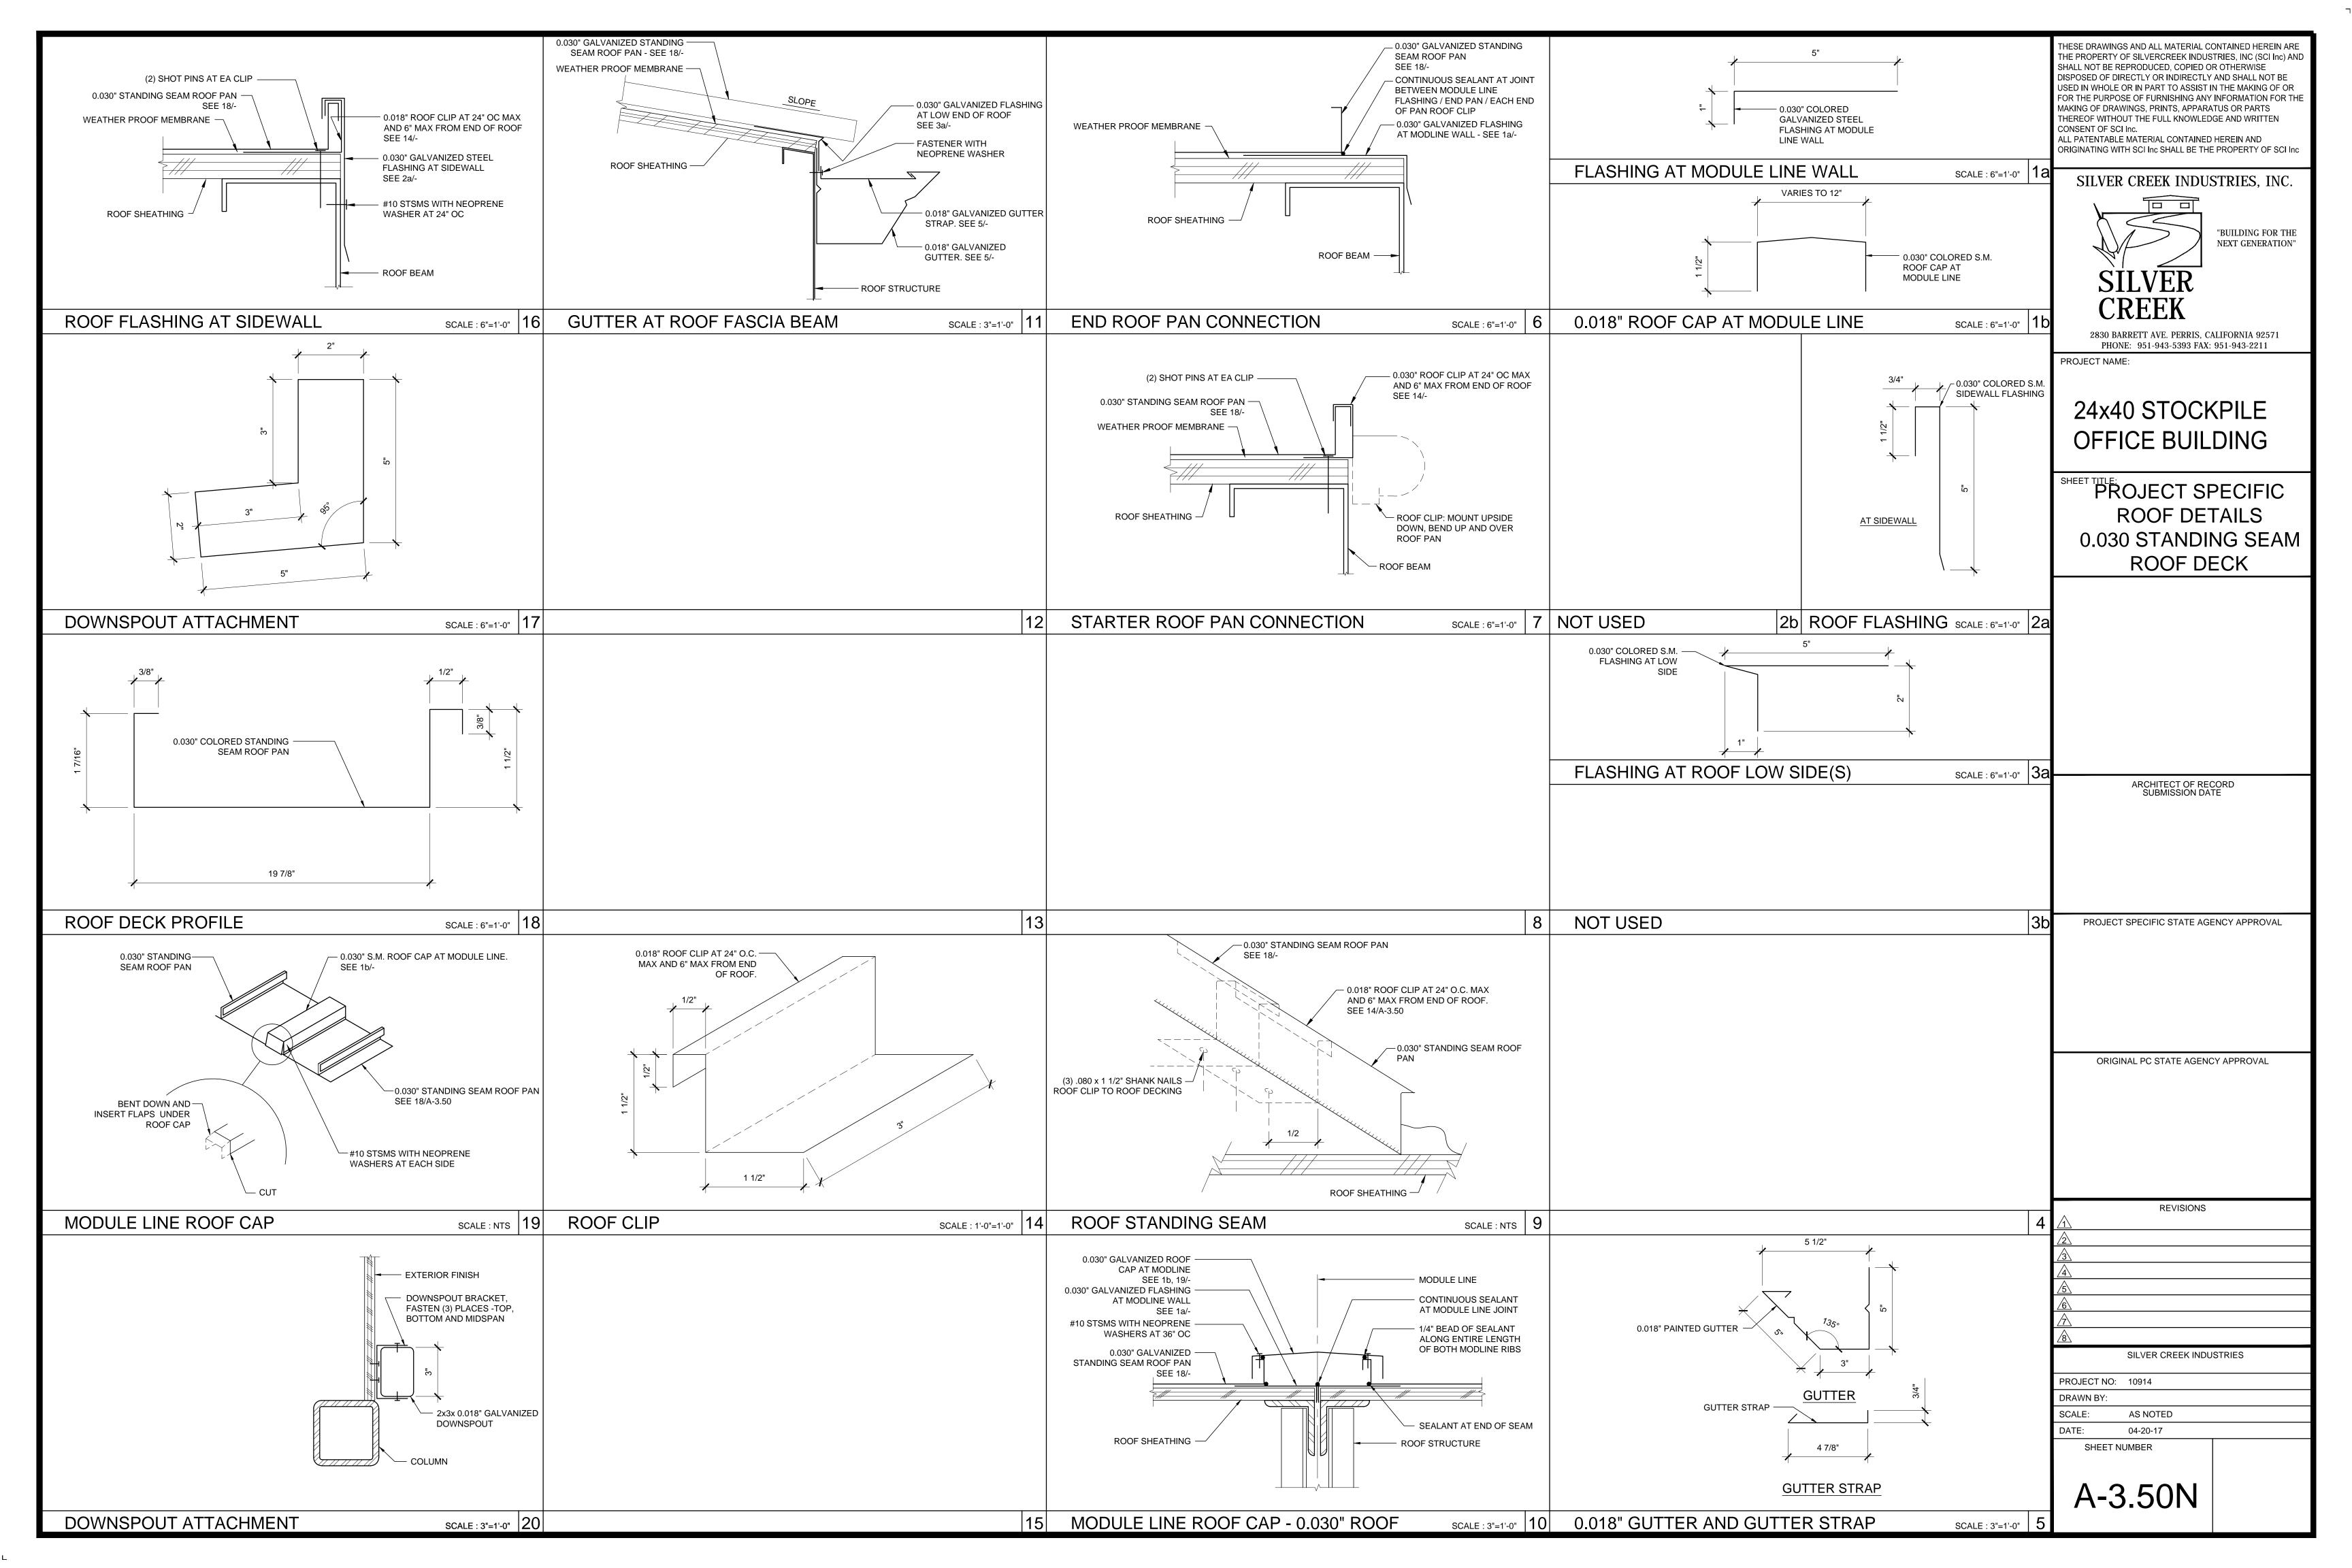

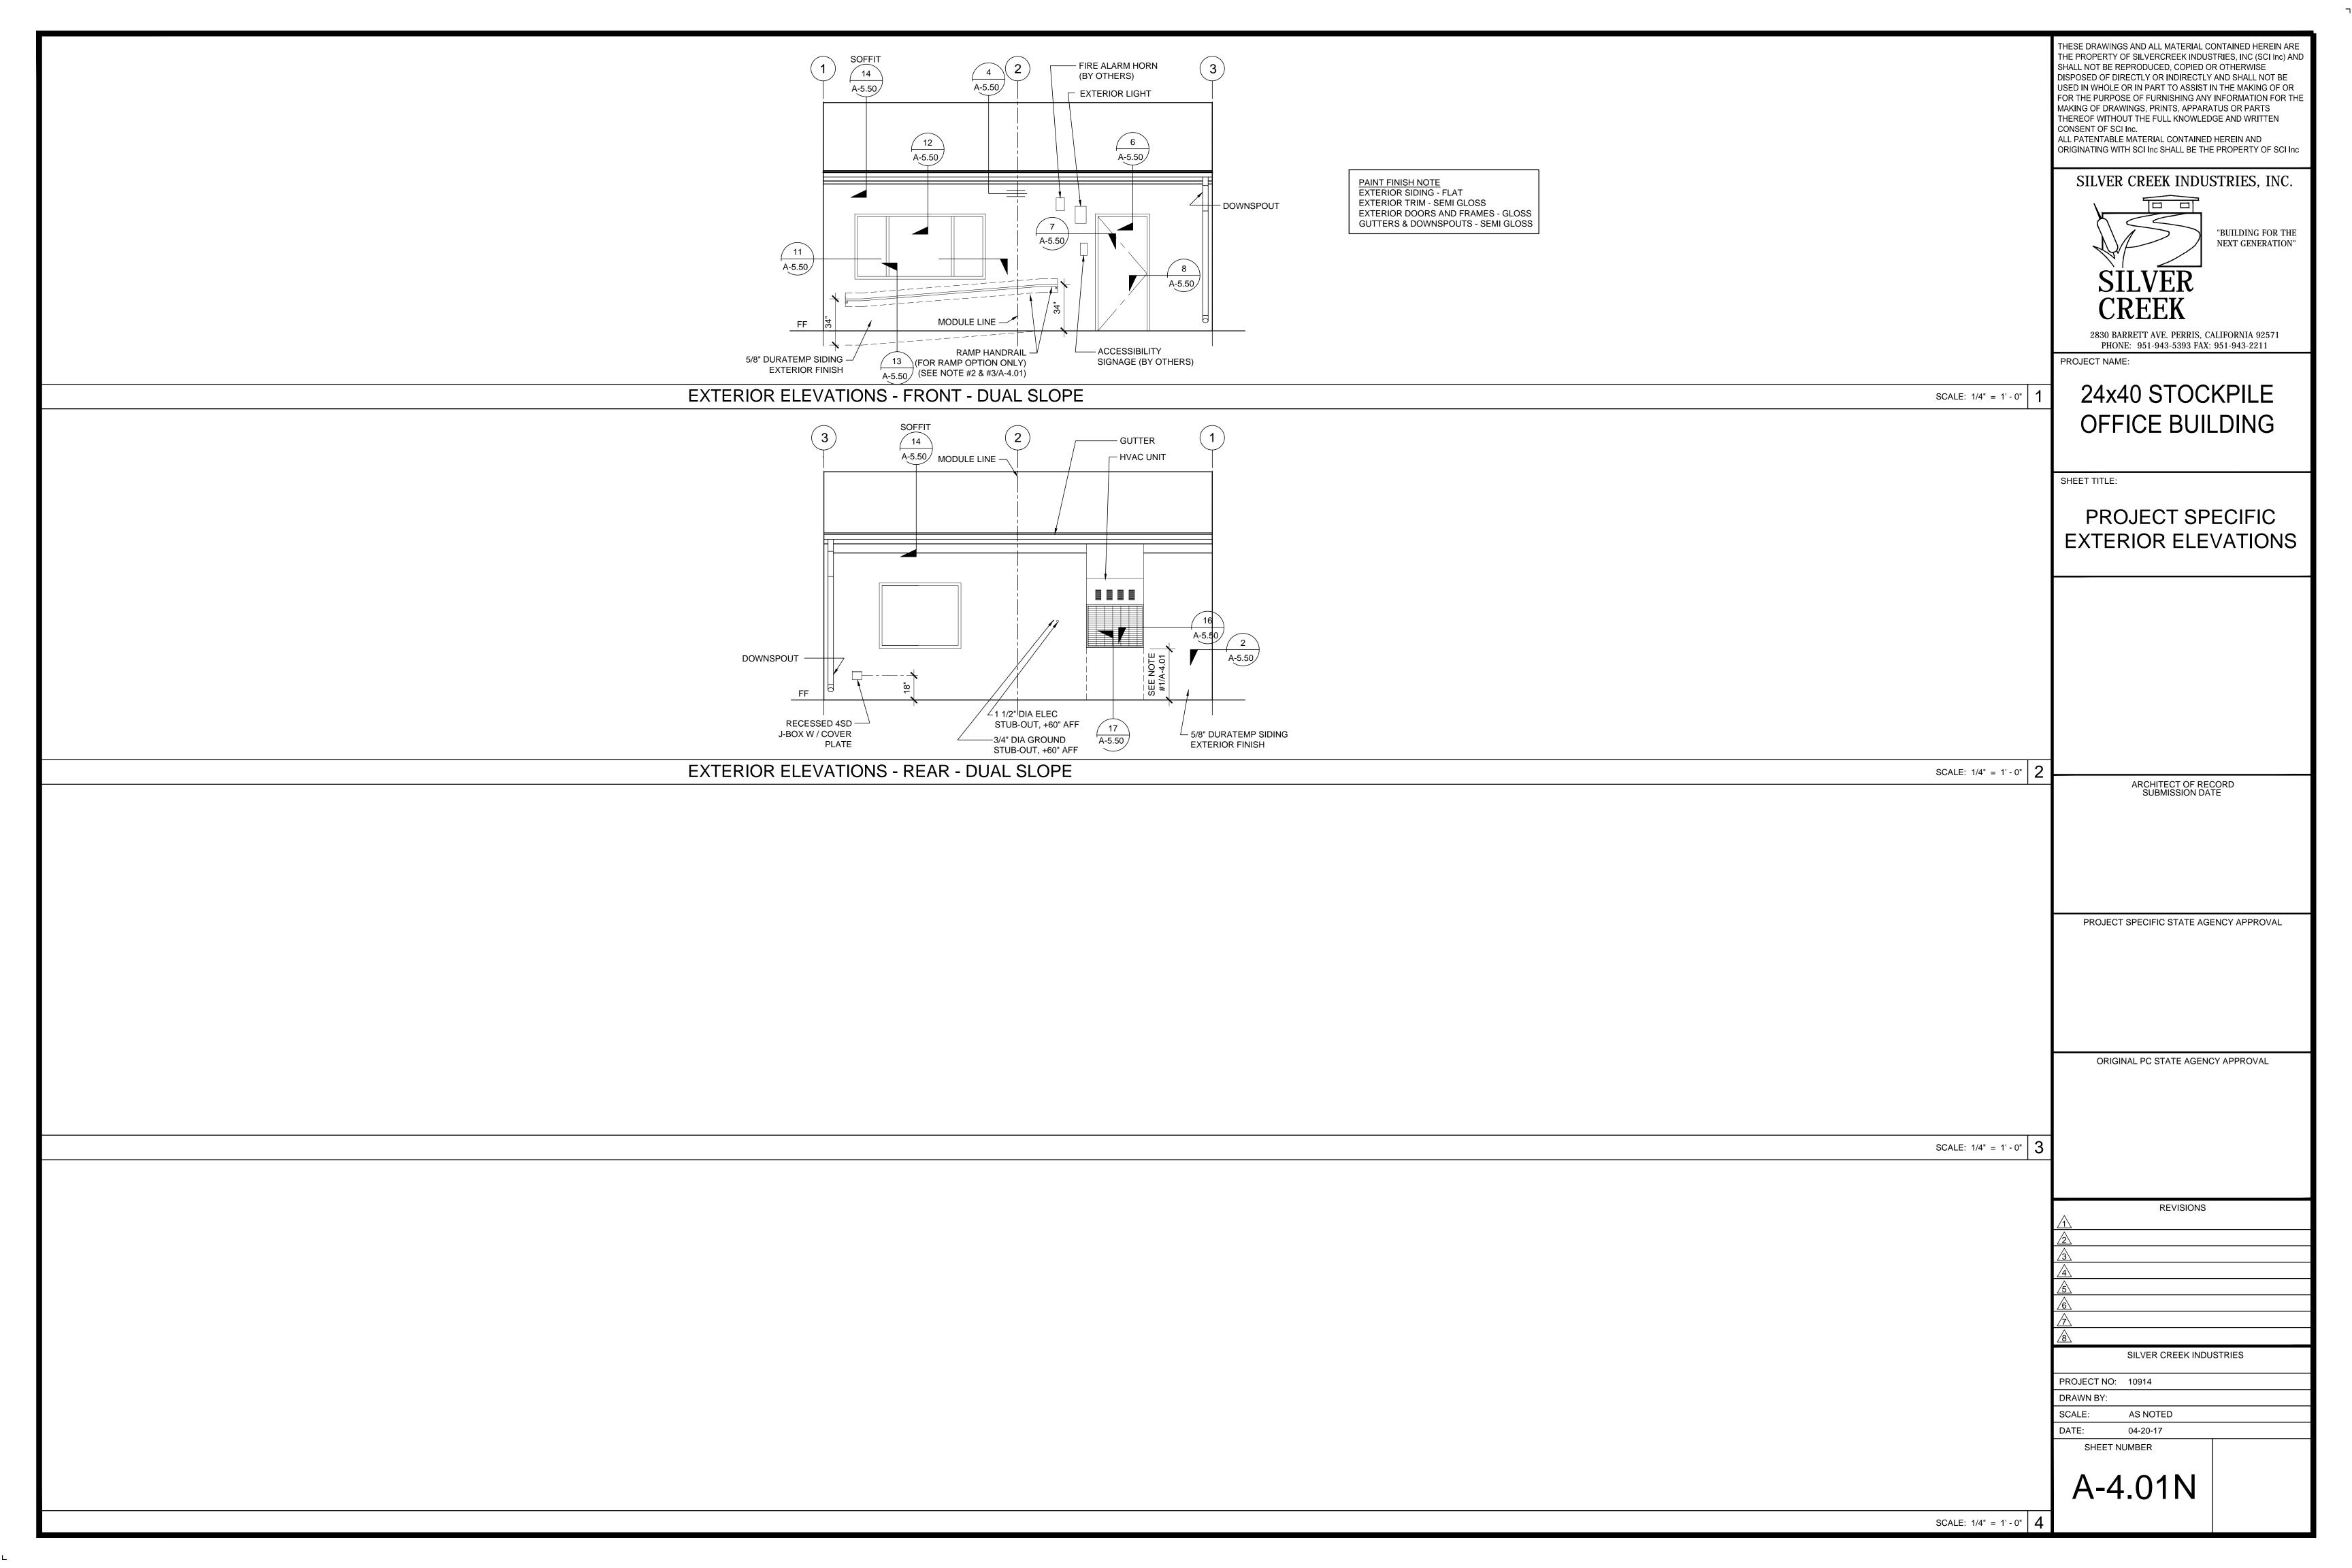

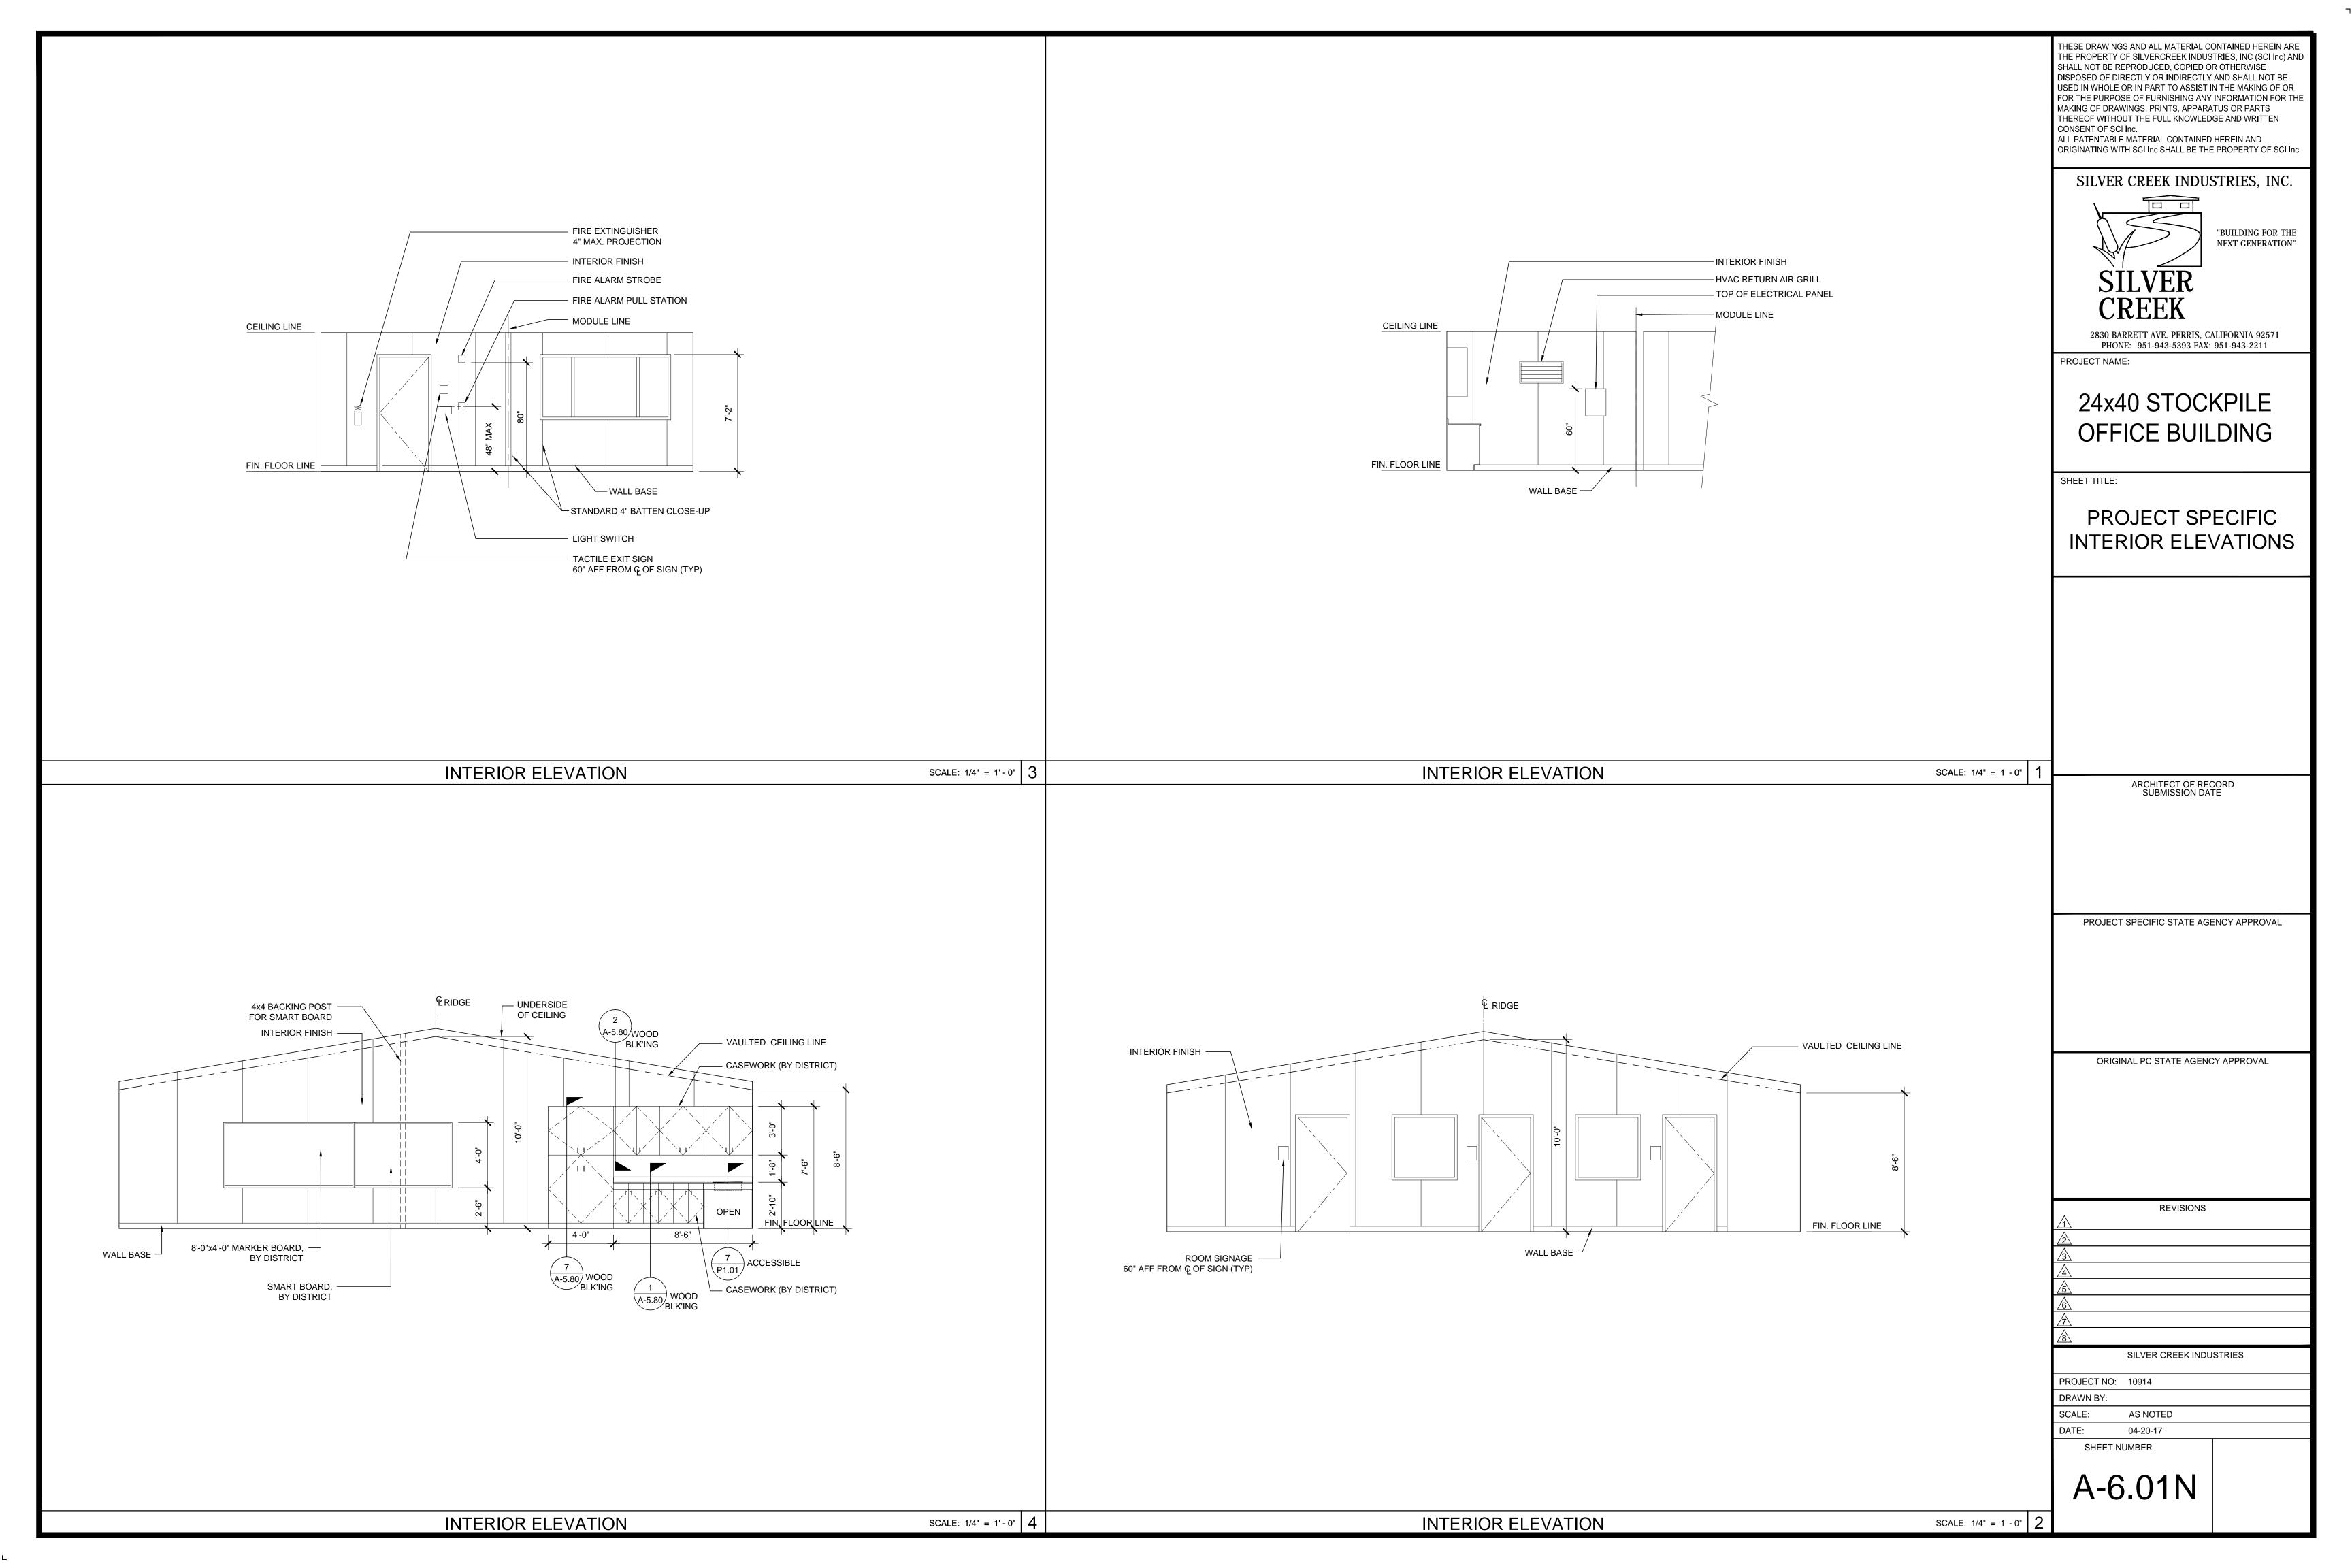

(3) SEE M-1.01 FOR HEAT PUMP SCHEDULE CO² SENSOR FOR DEMAND CONTROL VENTILATION SYSTEM 30x16 RAG 10 A-2.20 NOTE: PROVIDE ECONOMIZER W/ HVAC UNIT. SEE M-1.01 FOR MECHANICAL SCHEDULE THESE DRAWINGS AND ALL MATERIAL CONTAINED HEREIN ARE THE PROPERTY OF SILVERCREEK INDUSTRIES, INC (SCI Inc) AND SHALL NOT BE REPRODUCED, COPIED OR OTHERWISE DISPOSED OF DIRECTLY OR INDIRECTLY AND SHALL NOT BE USED IN WHOLE OR IN PART TO ASSIST IN THE MAKING OF OR FOR THE PURPOSE OF FURNISHING ANY INFORMATION FOR THE MAKING OF DRAWINGS, PRINTS, APPARATUS OR PARTS THEREOF WITHOUT THE FULL KNOWLEDGE AND WRITTEN CONSENT OF SCI Inc. ALL PATENTABLE MATERIAL CONTAINED HEREIN AND ORIGINATING WITH SCI Inc SHALL BE THE PROPERTY OF SCI Inc

SILVER CREEK INDUSTRIES, INC.

"BUILDING FOR THE NEXT GENERATION"



2830 BARRETT AVE. PERRIS, CALIFORNIA 92571 PHONE: 951-943-5393 FAX: 951-943-2211

PROJECT NAME:

24x40 STOCKPILE OFFICE BUILDING

SHEET TITLE:

PROJECT SPECIFIC MECHANICAL PLAN

ARCHITECT OF RECORD SUBMISSION DATE

PROJECT SPECIFIC STATE AGENCY APPROVAL

ORIGINAL PC STATE AGENCY APPROVAL

REVISIONS SILVER CREEK INDUSTRIES

PROJECT NO: 10914

DRAWN BY: AS NOTED 04-20-17

SHEET NUMBER

MECHANICAL PLAN

SCALE: 1/4" = 1'-0" 1

