

APPLICATION FOR APPROVAL OF CONSTRUCTION CHANGE DOCUMENT – CCD CATEGORY A/B

This application is for construction changes, as defined in IR A-6, to approved contract documents. This form shall be completed by the Design Professional in General Responsible Charge of the project, in accordance with California Code of Regulations, Title 24, Part 1, Section 4-338 (c) and in compliance with DSA IR A-6.

School District/Owner:				DSA File #:	-
Project Name/School:				DSA App. #:	-
APPLICANT					
	Date Submitted	d·	^ ttacho	d Doggoo2: □No	
CCD Cat. \(\begin{align*} \A / \begin{align*} \B, #: \\ \\ \ \ \ \ \ \ \ \ \ \ \ \ \ \ \				d Pages?: ∐No	
	ntary submittal, L	DSA required	1	•	tion requiring submission).
Firm Name:			Contact		
Email:			Phone N	Number:	
Address:			Γ,	_	T
City:			State:		Zip:
A DSA 301-N, DSA 301-P, or	90-Day Letter has	s been issued f	or this pro	ject.	
For project currently under co	nstruction.				
To obtain DSA approval of ex	isting uncertified b	building(s).			
DESIGN PROFESSIONAL IN	GENERAL RE	SPONSIBLE (CHARGE		
Name of Design Professional i					
Professional License #:	11 Conoral 1 Cop	01101010 0116.5	Disciplin		
Design Professional in General I	Design Professional in General Responsible Charge Statement: The attached Construction Change Documents have				
been examined by me for design in Regulations and the project specifi					
Signature:		·			
DES	IGN PROFESSIONAL	. IN GENERAL RES	SPONSIBLE	CHARGE	
				applicable, first s	
calculations and specifications listed on DSA 1 for this this pro		nped and sign	led by the	Responsible Des	sign Professional
Brief description of construction		th additional st	neets if ne	eeded).	
Brief documents of contraction			10010	,,,,,,,,,,,,,,,,,,,,,,,,,,,,,,,,,,,,,,,	
List of DSA approved drawings	s affected by this	s CCD:			
DSA USE ONLY				DSA S	Stamp
SSS_D. C. Date 9/9/19 (Approved / D	Nicopproved / Not Regid	For business office use	only	APPROVED DIV. OF THE STATE A	D
FLS Z. M. Date 9/5/19 Approved /D		Return By		APP. 03-118918	INC:
ACS S. Luk Date 9/26/19 Approved / D		Delivery Wicarou		SS P FLS	ACS 🗹
Remarks				DATE: 09/26/20	119
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Attachment #1 to DSA 140

School District/Owner: Bakersfield City School District

Project Name/School: Bessie Owens Intermediate School Relocatable Classrooms R6 & R7

DSA File #: 15-6 DSA App.#: 03-118918

CCD Cat. A, #1

Description of Construction Change:

District removed existing relocatable Restroom Building: R1; and the following Classroom Buildings: R2, R3, R4, and R5 from project site. Added Relocatable Classroom Building R7 sited as originally designed, Added Classroom Building R6 moved north on site approximately 135 feet, closer to R7. Revise fire alarm system to reflect site plan revisions and removal of relocatable building's R1–R-5.

The following sheets shall be removed and replaced with attached revised sheets:

Sheet Description
TITLE SHEET
FIRE ACCESS
CIVIL IMPROVEMENTS GRADING PLAN
CIVIL IMPROVEMENTS GRADING PLAN
OVERALL SITE PLAN
DEMOLITION SITE PLAN
PARTIAL SITE PLAN
EXISTING RESTROOM
DETAILS (INCLUDED FOR REFERENCE ONLY)
SYMBOLS CODE AND NOTES
DETAILS
FIRE ALARM RISER CALCULATIONS
DATA PLAN
FIRE ALARM PORTABLE PLAN
PARTIAL SITE ELECTRICAL PLAN
PARTIAL SITE FIRE ALARM PLAN
PARTIAL SITE DATA/COMM. PLAN

The following sheet shall be added to the project:

Sht # Sheet Description

E-1.1 PARTIAL SITE DEMO PLAN


- ALL DRAWINGS SHALL BE USED IN CONCERT WITH EACH OTHER. IF THE CONTRACTOR DISCOVERS ANY DISCREPANCY BETWEEN THEDOCUMENTS. THE CONTRACTOR SHALL REQUEST IN WRITING A CLARIFICATION FROM THE ARCHITECT. REFER TO THE ARCHITECTURAL AND ENGINEERING DRAWINGS FOR PLACEMENT, ORIENTATION AND COORDINATION OF WORK. INFORMATION SHOWN IN LARGER SCALE IS INTENDED TO SUPPLEMENT INFORMATION OF SMALLER, PRECEDING REFERENCE DRAWINGS, LARGER SCALE DRAWINGS TAKE PRECEDENCE OVER SMALLER SCALE DRAWINGS.
- NOTATIONS MARKED "TYPICAL" (TYP.) SHALL BE CONSISTENT THROUGHOUT ALL SUCH REFERENCE NOMENCLATURE, SYMBOLS AND DRAWING INDICATIONS OF LIKE OR SIMILAR KIND.
- DO NOT SCALE DRAWINGS. THE CONTRACTOR SHALL FIELD VERIFY CONSTRUCTION CONDITIONS AND DIMENSIONS PRIOR TO ORDERING, FABRICATING OR INSTALLING ANY ASSOCIATED WORK. IF DISCREPANCIES ARE FOUND, THE CONTRACTOR SHALL REQUEST IN WRITING A CLARIFICATION FROM THE ARCHITECT PRIOR TO COMMENCEMENT OF ANY ASSOCIATED WORK.
- CONTRACTOR SHALL VERIFY, AT THE SITE, ALL EXISTING CONDITIONS PRIOR TO SUBMITTAL OF BIDS. SITE VISITS DURING BIDDING SHALL BE COORDINATED WITH THE OWNER IN ACCORDANCE WITH THE PROVISIONS OF THE SPECIFICATIONS.
- SHALL BE REPLACED WITH THE SAME MATERIALS, INCLUDING MATCHING THE EXISTING COLORS AND TEXTURES.
- EXISTING WORK IS SHOWN FOR REFERENCE ONLY. THE OWNER AND/OR ARCHITECT DO NOT GUARANTEE EXISTING CONDITIONS AS SHOWN ON THESE DOCUMENTS.


CONTRACTOR SHALL PROTECT ALL EXISTING WORK. ANY DAMAGED WORK

- CONTRACTOR(S) SHALL BE RESPONSIBLE FOR THEIR OWN CLEANUP AS WORK
- MATERIALS SUSPECTED OF CONTAINING HAZARDOUS MATERIALS THAT ARE DISCOVERED DURING THE PROGRESS OF THE WORK SHALL BE REPORTED TO THE OWNER IN WRITING. WORK IN THAT PARTICULAR AREA SHALL BE SUSPENDED UNTIL THE OWNER TESTS THE SUSPECT MATERIAL AND IT IS FOUND TO BE SAFE, OR THE MATERIAL HAS BEEN PROPERLY ABATED.
- ALL WORK IS NEW UNLESS OTHERWISE NOTED.
- IN THE EVENT CERTAIN FEATURES OF THE CONSTRUCTION ARE NOT FULLY SHOWN ON THE CONSTRUCTION DOCUMENTS, THEN THEIR CONSTRUCTION SHALL BE OF THE SAME CHARACTER AS FOR SIMILAR CONDITIONS THAT ARE SHOWN.
- STORAGE OF CONSTRUCTION MATERIAL AND EFFECT OF WORK ON EXISTING OCCUPIED AREAS SHALL BE APPROVED BY THE LOCAL FIRE AUTHORITY.
- CONTRACTOR SHALL BE RESPONSIBLE FOR COORDINATION OF ALL WORK PROVIDED BY OTHERS UNDER SEPARATE CONTRACT.
- KEYNOTES USED ON THE ARCHITECTURAL DRAWINGS ARE FOR ASSEMBLIES, MATERIAL REFERENCES AND NOTES. REFER TO THE KEYNOTE LIST ON THE RESPECTIVE DRAWING FOR THE INFORMATION WHICH RELATES TO EACH KEYNOTE.
- DURING CONSTRUCTION, COMPLIANCE WITH CFC CHAPTER 14, FIRE SAFETY DURING CONSTRUCTION AND DEMOLITION WILL BE ENFORCED.
- DURING CONSTRUCTION, COMPLIANCE WITH CBC CHAPTER 33, SAFETY WILL BE
- NO CHANGES OR REVISIONS SHALL BE MADE FOLLOWING WRITTEN APPROVAL WHICH AFFECTS ACCESS COMPLIANCE ITEMS UNLESS SUCH CHANGES OR REVISIONS ARE SUBMITTED TO DSA FOR APPROVAL
- SUBSTITUTIONS AFFECTING DSA REGULATIONS SHALL BE SUBMITTED AS A CONSTRUCTION CHANGE DOCUMENT OR ADDENDA AND APPROVED BY DSA PRIOR TO FABRICATION AND INSTALLATION

SYMBOL LEGEND

ROOM NAME____ ROOM NUMBER

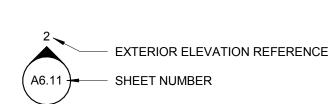

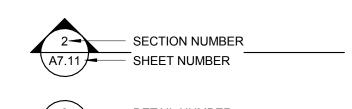

SHEET NUMBER

POT - STATEMENT OF COMPLIANCE

ALTERATIONS, ADDITIONS AND STRUCTURAL REPAIRS"

THESE CONSTRUCTION DOCUMENTS.

FOLLOWINGS:

WITH THE CBC AS A PART OF THIS PROJECT

KEYNOTE REFERENCE OR COLOR DESIGNATION

THE PATH OF TRAVEL (POT) IDENTIFIED IN THESE CONSTRUCTION DOCUMENTS IS

NECESSARY TO BRING THEM INTO COMPLIANCE HAS BEEN INCLUDED WITHIN THE

ANY NON-COMPLIANT ELEMENTS. COMPONENTS OR PORTIONS OF THE POT THAT

WILL NOT BE CORRECTED BY THIS PROJECT BASED ON VALUATION THRESHOLD

LIMITATIONS OR A FINDING OF UNREASONABLE HARDSHIP ARE SO INDICATED IN

DURING CONSTRUCTION, IF POT ITEMS REPRESENTED AS CODE COMPLIANT ARE

FOUND TO BE NON-CONFORMING, THEY SHALL BE BROUGHT INTO COMPLIANCE

COMPLIANT WITH THE CURRENT APPLICABLE CALIFORNIA BUILDING CODE

ACCESSIBILITY PROVISIONS FOR "PATH OF TRAVEL REQUIREMENTS FOR

DETERMINE COMPLIANCE WITH THESE REQUIREMENTS. ANY FLEMENTS.

COMPLIANT 1) HAVE BEEN IDENTIFIED AND 2) THE CORRECTIVE WORK

SCOPE OF THIS PROJECT'S WORK THROUGH DETAILS, DRAWINGS AND

DSA ADMIN. REQUIREMENTS

. A COPY OF PARTS 1 TO 5, TITLE 24, C.C.R. SHALL BE KEPT ON THE JOB

CHANGES OT THE APPROVED DRAWINGS AND SPECIFICATIONS SHALL BE

APPROVED BY DSA, AS REQUIRED PER SECTION 4-338, PART 1, TITLE 24, CCR

MADE BY ADDENDA OR CONSTRUCTION CHANGE DOCUMENT - (C.C.D.

CHANGES OR REVISIONS ARE SUBMITTED TO THE DSA FOR APPROVAL.

A CONSTRUCTION CHANGE DOCUMENT OR ADDENDA, AND SHALL BE

6. MATERIALS AND THEIR INSTALLATION SHALL COMPLY WITH APPLICABLE

7. PER CBC 11B-104.1 "ALL DIMENSIONS ARE SUBJECT TO CONVENTIONAL

INDUSTRY TOLERANCES EXCEPT WHERE THE REQUIREMENT IS STATED AS

CODES, STANDARDS AND MANUFACTURER'S RECOMMENDATIONS.

A RANGE WITH SPECIFIC MINIMUM AND MAXIMUM END POINTS."

ALL TESTS TO CONFORM TO THE REQUIREMENTS OF SECTION 4-335, PART 1 TITLE 24, AND APPROVED TESTS AND INSPECTIONS SHEET.

). TESTS OF MATERIALS SHALL AND TESTING LABORATORY SHALL BE IN

ACCORDANCE WITH SECTION 4-335, PART 1, TITLE 24 AND THE DISTRICT

SHALL EMPLOY AND PAY THE LABORATORY. COSTS OF RE-TEST SHALL

10. DSA SHALL BE NOTIFIED AT THE START OF CONSTRUCTION AND PRIOR TO

THE PLACEMENT OF CONCRETE PER SECTION 4-331, PART 1,TITLE 24.

11. A "DSA CERTIFIED" PROJECT EMPLOYED BY THE DISTRICT (OWNER) AND

TITLE 24, CCR. DSA INSPECTOR SHALL BE CETIFIED CLASS 3.

DUTIES IN ACCORDANCE WITH SECTIONS 4-333(a) AND 4-341,

APPROVED BY DSA SHALL PROVID CONTINUOUS INSPECTION OF THE WORK.

THE DUTIES OF THE INSPECTOR ARE DEFINED IN SECTION 4-342, PART 1,

12. SUPERVISION OF CONSTRUCTION BY DSA SHALL BE IN ACCORDANCE WITH

13. CONTRACTOR, INSPECTOR, ARCHITECT, AND ENGINEERS SHALL SUBMIT

VERIFIED REPORTS (Form SSS-6) IN ACCORDANCE WITH SECTIONS 4-336

14. THE ARCHITECT AND THE STRUCTURAL ENGINEER SHALL PERFORM THEIR

15. THE CONTRACTOR SHALL PERFORM HIS DUTIES IN ACCORDANCE WITH

OF ALTERATION, REHABILITATION OR RECONSTRUCTION IS TO BE

SHOULD ANY EXISTING CONDITIONS SUCH AS DETERIORATION OR

COVERED BY THE CONTRACT DOCUMENTS WHERE IN THE FINISHED

SET OF PLANS AND SPECIFCATIONS, DETAILING AND SPECIFYING THE

17. FABRICATION AND INSTALLATION OF DEFERRED SUBMITTAL ITEMS SHALL

18. A DSA ACCEPTED TESTING LABORATORY DIRECTLY EMPLOYED BY THE

DISTRICT (OWNER) SHALL CONDUCT ALL THE REQUIRED TESTS AND

19. GRADING PLANS, DRAINAGE IMPROVEMENTS, ROAD ACCESS REQUIREMENTS

AND ENVIRONMENTAL HEALTH CONSIDERATIONS SHALL COMPLY WITH LOCAL

NONCOMPLYING CONSTRUCTION BE DISCOVERED WHICH IS NOT

WORK WILL NOT COMPLY WITH TITLE 24, CALIFORNIA CODE OF

IN ACCORDANCE WITH TITLE 24, CALIFORNIA CODE OF REGULATIONS.

16. THE INTENT OF THESE DRAWINGS AND SPECIFICATIONS IS THAT THE WORK

REGULATIONS, A CONSTRUCTION CHANGE DIRECTIVES-C.C.D., OR SEPARATE

REQUIRED WORK SHALL BE SUBMITTED TO AND APPROVED BY DSA BEFORE

NOT BE STARTED UNTIL CONTRACTOR'S DRAWINGS, SPECIFICATIONS. AND

ENGINEERING CALCULATIONS FOR THE ACTUAL SYSTEMS TO BE INSTALLED HAVE BEEN ACCEPTED AND SIGNED BY THE ARCHITECT OR STRUCTURAL

4. SUBSTITUTIONS AFFECTING DSA REGULATED ITEMS SHALL BE SUBMITTED AS

3. NO CHANGES OR REVISIONS SHALL BE MADE FOLLOWING WRITTEN

APPROVED BY DSA PRIOR TO FABRICATION AND INSTALLATION.

5. CONSTRUCTION CHANGE DOCUMENTS MUST BE SIGNED BY THE

· ARCHITECT OR ENGINEER OF RECORD.

· DELEGATED PROFESSIONAL ENGINEER.

BE PER GENERAL CONDITIONS.

SECTION 4-334, PART 1, TITLE 24.

SECTIONS 4-343, PART 1, TITLE 24.

PROCEEDING WITH THE WORK.

ENGINEER AND APPROVED BY THE DSA.

INSPECTIONS FOR THE PROJECT.

AND 4-343, PART 1, TITLE 24.

PART 1, TITLE 24.

· STRUCTURAL ENGINEER (WHEN APPLICABLE)

SPECIFICATIONS INCORPORATED INTO THESE CONSTRUCTION DOCUMENTS

BAKERSFIELD CITY SCHOOL DISTRICT



BESSIE OWENS INTERMEDIATE - RELOCATBLES R6 & R7

815 EUREKA ST. BAKERSFIELD CA, 93305

DSA FILE NO.:15-6

A1100 OVERALL SITE PLAN

A1111 PARTIAL SITE PLAN

A1130 EXISTING RESTROOM

A1110 D DEMOLITION SITE PLAN

A1120 EXISTING ACCESSIBLE PARKING

E-0.2 FIRE ALARM RISER CALCULATIONS)-

E-0.0 SYMBOLS, CODES, AND NOTES

E-0.4 FIRE ALARM PORTABLE PLAN

E-2 PARTIAL SITE FIRE ALARM PLAN

E-3 PARTIAL SITE DATA/COMM. PLAN

E-1 PARTIAL ELECTRICAL PLAN

E-1.1 PARTIAL SITE DEMO PLAN

E-0.1 DETAIL

Total: 9

E-0.3 DATA PLAN

G1100 FLOOD ZONE MAP

Ġ1200 FIRE ACCESS

GENERAL

CIVIL IMPROVEMENTS GRADING PLAN R6 & R7

ARCHITECTURAL

(A8000 DETAILS (INCLUDED FOR REFERENCE ONLY)

ELECTRICAL

CIVIL IMPROVEMENTS GRADING PLAN PATH OF

DSA APP NO.: 03-118918

SHEET INDEX

RELOCATABLE - R7

S/N: 12175-12176

A2.11N REFLECTED CEILING

A-4.01N EXTERIOR ELEVATIONS

A-6.01N INTERIOR ELEVATIONS

A-0.0 BUILDING OPTIONS SCHEDULE

A-0.3 TYPICAL KEY PLANS 24' - 120' x 40'

A-0.1 SYMBOLS LEGEND, ABBREVIATIONS & ADA SIGNAGE

A-0.5A ENERGY CALC'S. PRF FORMS ZONE 14 WORST CASE

A-0.5B ENERGY CALC'S. PRF FORMS ZONE 15 WORST CASE

A-0.5C ENERGY CALC'S. PRF FORMS ZONE 16 WORST CASE

A-0.6B ENERGY CALC'S. LTO / MCH FORMS 24' x 40' BLDG'S

A-0.6E ENERGY CALC'S, LTO / MCH FORMS 120' x 40' BLDG'S

A-0.7 DESIGN ENERGY VALUES BY ZONE & CAL GREEN SPEC'S

A-2.11 REFLECTED CEILING PLAN 24' x 40' - VAULTED CEILING

A-5.80 ARCHITECTURAL DETAILS MISCELLANEOUS / OPTIONS

A-5.81 ARCHITECTURAL DETAILS MISCELLANEOUS / OPTIONS

S-2.11 ROOF FRAMING PLAN 0.018" DECK, B.U.R. OR TPO 20 PSI

S-5.12 WALL FRAMING OPENING SCHEDULES WOOD STUDS

A-0.6A ENERGY CALC'S. ELC FORMS 24' x 40' BLDG'S

A-0.6C ENERGY CALC'S, LTI FORMS 24' x 40' BLDG'S

A-0.6D ENERGY CALC'S. ELC FORMS 120' x 40' BLDG'S

A-0.6F ENERGY CALC'S. LTI FORMS 120' x 40' BLDG'S

A-3.01 ROOF PLAN 24' v 40' METAL DECK DIJAL SLOPE

A-3.50 ROOF DETAILS STANDING SEAM ROOF DECK

A-5.50 ARCHITECURAL DETAILS WOOD STUD - SHTG

A-4.01 EXTERIOR ELEVATION 24' x 40' DUAL SLOPE

A-5.02 CROSS SECTION DUAL SLOPE ROOF DECK

A-5.70 ARCHITECTURAL DETAILS FLOOR

F-0.03 WOOD FOUNDATION PLAN 24 x 40

S-1.01 FLOOR FRAMING PLAN WOOD FLOOR

S-2.51 ROOF FRAMING DETAILS DUAL SLOPE

S-3.02 BUILDING SECTIONS 0.018" DUAL SLOPE

S-5.10 WALL FRAMING DETAILS WOOD STUDS

S-5.11 WALL FRAMING DETAILS WOOD STUDS

P-1.01 PLUMBING DETAILS AND SCHEDULE

M-1.01 MECHANICAL PLAN WALL MOUNT

S-5.00 WALL FRAMING ELEVATIONS WOOD STUDS

M-0.1 MECHANICAL NOTES, SCHEDULES, & DETAILS

E-1.01 ELECTRICAL PLAN AND SCHEDULE 24' x 40'

A-6.01 INTERIOR ELEVATION 24' x 40'

F-0.50 FOUNDATION DETAILS WOOD

S-0.1 STRUCTURAL SPECIFICATIONS

S-1.50 FLOOR FRAMING DETAILS

S-2.60 ROOF FRAMING DETAILS

M-1.01NMECHANICAL PLAN

E-1.01N ELECTRICAL PLAN

A-1.01 FLOOR PLAN 24' x 40'

A-5.05 CROSS SECTION

A-2.20 CEILING DETAILS T GRID

A-0N COVER SHEET

A-1.01N FLOOR PLAN

A3.01N ROOF PLAN

A-0 COVE SHEET

A-0.2 SCHEDULES

A-0A T&IFORMS

A3.50N ROOF DETAILS

A-0.2N SCHEDULES

PC 04-114182 (A#04-116284)

AGENCY TRACKING NO.: 63321-289

STATEMENT OF GENERAL CONFORMANCE

FOR ARCHITECTS/ENGINEERS WHO UTILIZE PLANS. INCLUDING BUT NOT LIMITED TO SHOP DRAWINGS, PREPARED BY OTHER LICENSED DESIGN PROFESSIONALS AND/OR CONSULTANTS The drawings or sheets listed on the cover or sheet index This drawing, page of specifications/ calculations

licensed and/or authorized to prepare such drawings in this state. It has been design intent and appears to meet the appropriate requirements of Title 24, California Code of Regulations and the project specifications prepared


have been prepared by other design professionals or consultants who are

2) coordination with my plans and specifications and is acceptable for incorporation into the construction of this project

The Statement of General Conformance "shall not be construed as relieving me of my rights, duties, and responsibilities under Sections 17302 and 81138 of the Education Code and Sections 4-336, 4-341 and 4-344" of Title 24, Part 1. (Title 24, Part 1, Section 4-317 (b)) certify that:

All drawings or sheets listed on the cover or index sheet

This drawing or page is/are in general conformance with the project design, and

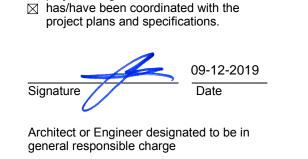

RICHARD MELLO, AIA C-18079 Print Name Architect License Number Expiration Date

SCOPE OF WORK

THE FOLLOWING IS A BRIEF DESCRIPTION OF THE SCOPE OF WORK AS REQUIRED BY DSA, CONTRACTOR SHALL DETERMINE/VERIFY THE ENTIRE SCOPE AS SHOWN ON THE DRAWINGS AND SPECIFICATIONS PRIOR TO SUBMITTING BIDS. PLACEMENT OF (2) 24'-0" x 40'-0" CLASSROOM RELOCATABLE BUILDINGS , ONTO AN EXISTING CAMPUS. TRÉMOVÉ (4) EXISTING 24' X 40' RELOCATABLE CLASSROOM BUILDINGS AND (1) 12' x 40' RELOCATABLE RESTROOM BUILDING.

ASSOCIATED FIRE ALARM MODIFICATIONS THE FOLLOWING DOCUMENTS SHALL BE ON THE JOBSITE PRIOR TO INSTALLATION OF THE UNITS(S):

a) IN-PLANT VERIFIED REPORT b) LABORATORY VERFIED REPORT c) WELDING VERIFIED REPORT

ENGINEER IF ANY DISCREPANCIES OCCUR.

THE SITE INSPECTOR SHALL VERIFY THE ABOVE DOCUMENTS AND SERIAL NUMBERS ARE APPLICABLE TO EACH UNIT PRIOR TO INSTALLATION OF THE UNIT(S). NOTIFY ARCHITECT AND THE DIVISION OF THE STATE ARCHITECT FIELD

DETERIORATION OR EXISTING NON-COMPLIANT CONSTRUCTION: IF ANY CONDITION IS DISCOVERED WHICH, IF LEFT UNCORRECTED, WOULD MAKE THE BUILDING NON-COMPLIANT WITH THE REQUIREMENTS OF THE EDITIONS OF THE CBC IN FORCE AT THE TIME OF ORIGINAL CONSTRUCTION, THE CONDITION MUST BE CORRECTEDIN ACCORDANCE WITH CURRENT CODE REQUIREMENTS. A CONSTRUCTION CHANGE DOCUMENT (CCD TYPE A), OR A SEPARATE SET OF PLANS AND SPECIFICATIONS DETAILING AND SPECIFYING THE REQUIRED REPAIR WORK SHALL BE SUBMITTED TO AND APPROVED BY DSA BEFORE PROCEEDING WITH THE REPAIR WORK

Grand Total: 101 Sheets

APPLICABLE CODES PROJECT DIRECTORY

RELOCATABLE - R6

PC 266 (A#04-100929)

S/N: 38072-38073

AA3.0 EXTERIOR ELEVATIONS

SA1.0 FLOOR FRAMING PLAN

SA2.0 ROOF FRAMING PLAN

WALL FRAMING

E1.0 ELECTRICAL PLAN

RAMP/LANDING

R2.0 RAMP/LANDING DETAILS

FRAMING DETAILS

M1.0 MECHANICAL (HVAC) PLAN

S5.0

Total: 24

STRUCTURAL DETAILS

STRUCTURAL DETAILS

WALL FRAMING DETAILS

SCHEDULE SHEET

INTERIOR ELEVATIONS

ARCHITECTIURAL DETAILS

ARCHITECTURAL DETAILS

REFLECTED CEILING PLAN

REFLECTED CEILING DETAILS

FOUNDATION PLAN & DETAILS

FOUNDATION PLAN & DETAILS

FRAMING ELEVATIONS / DETAILS

A0.0 COVER SHEET

AA2.0 ROOF PLAN

CALIFORNIA CODE OF REGULATIONS, TITLE 24 - BUILDING STANDARDS

amendments)

2016 CALIFORNIA ADMINISTRATIVE CODE (CAC) (Title 24, Part 1, CCR) - At Chaper 10, 2010 California Building Standards Administrative Code (Title 24, Part 1) applies CALIFORNIA BUILDING CODE (CBC), Volumes 1 & 2 (Title 24, Part 2, CR) (2012 International Building Code with 2013 California

2016 CALIFORNIA ELECTRICAL CODE, Title 24, Part 3, CCR) (2011 National Electrical Code with 2013 California amendments) CALIFORNIA MECHANICAL CODE (CMC), Title 24, Part 4, CCR) (2012 Uniform Mechanical Code with 2013 California amendments) CALIFORNIA PLUMBING CODE (CPC), Title 24, Part 5, CCR) (2012 Uniform Plumbing Code with California amendments) CALIFORNIA ENERGY CODE, (Title 24, Part 6, CCR)

CALIFORNIA HISTORICAL BUILDING CODE, (Title 24, Part 8, CCR) CALIFORNIA FIRE CODE (CFC), Title 24, Part 9, CCR) (2012 International Fire Code with California amendments) CALIFORNIA EXISTING BUILDING CODE, (Title 24, Part 10, CCR) CALIFORNIA GREEN BUILDING STANDARDS CODE (CALGREEN), 2010 California Green Building Standards Code applies at those portions designated by California Building Standards Commision.

CALIFORNIA REFERENCE STANDARDS CODE, (Title 24, Part 12, 2016 ADA STANDARDS FOR ACCESSIBILITY DESIGN, U.S. Department of Justice 2016 NFPA 13. STANDARD FOR THE INSTALLATION OF SPRINKLER

SYSTEMS, 2013 Edition 2016 NFPA 72, NATIONAL FIRE ALARM CODE AND SIGNALING CODE, 2013 Edition NOTE: SOME CODES MAY NOT APPLY IF WORK REGULATED BY SUCH CODES IS NOT WITHIN THE SCOPE OF THIS PROJECT.

OWNER: BAKERSFIELD CITY SCHOOL DISTRICT 1501 FELIZ DR.

BAKERSFIELD, CA, 93307 PHONE: (661) 636-4000 (661) 636-4130 CONTACT:

SAN LUIS OBISPO, CA 93401 PHONE: FAX: ROBERT VAN TASSEL CONTACT: RANDY ROWLES

R-1.01 RAMP/LANDING

R-2.01 RAMP DETAILS

PORTER AND ASSOCIATES INC. 1200 21ST. STREET BAKERSFIELD, CA. 93301 (661) 327-0362 PHONE: (661) 327-1065 CONTACT: FREDDIE PORTER

JMPE ELECTRICAL ENGINEERING 5500 MING AVENUE, SUITE 251 BAKERSFIELD, CA 93309 PHONE: (270) 210-4159 FAX:

ELECTRICAL:

ARCHITECT:

IBI GROUP ARCHITECTURE PLANNING

(805) 546-0433


(805) 546-0504

SR. PRIN. ARCHITECT

RICK MELLO

4115 BROAD STREET, SUITE B-6

CONTACT: CHELSEY HARMON

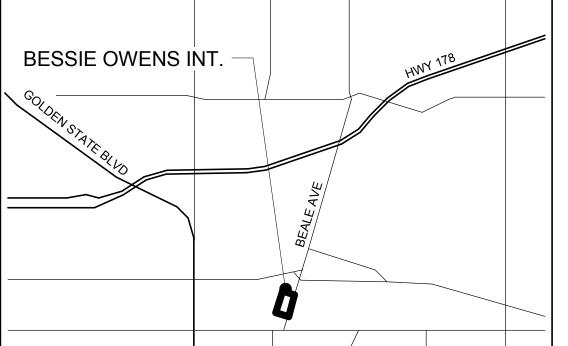

VICINITY MAP

PROJECT NO: 109668 DRAWN BY CHK'D BY: **ISSUE DATE** 05/24/2018 SHEET TITLE

BESSIE OWENS INTERMEDIATE -

RELOCATBLES R6 & R7

815 EUREKA ST. BAKERSFIELD CA, 93305

TITLE SHEET

SHEET NUMBER

PRIME CONSULTANT

IBI Group is forbidden

NO. DATE

CONSULTANT

AGENCY INFORMATION:

08-30-2019

09-12-2019

ARCHITECTURE PLANNING

San Luis Obispo

4119 Broad Street, Suite 210

San Luis Obispo, CA 93401

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REVISIONS

DSA CCD #1

Clarification to CCD #1

V. OF THE STATE ARCHIT

PP. 03-118918 INC:

REVIEWED FOR

DATE: 09/26/2019

AGENCY TRACKING NO. 63321-289

DIV. OF THE STATE ARCHITECT

OFFICE OF REGULATION SERVICES

|03-118918|

AC_____FLS____SS____

BAKERSFIELD CITY SCHOOL


DISTRICT

FILE NO. 15-6

S V FLSV HESMACS V

DESCRIPTION

805.546.0433 fax: 805.546.0504

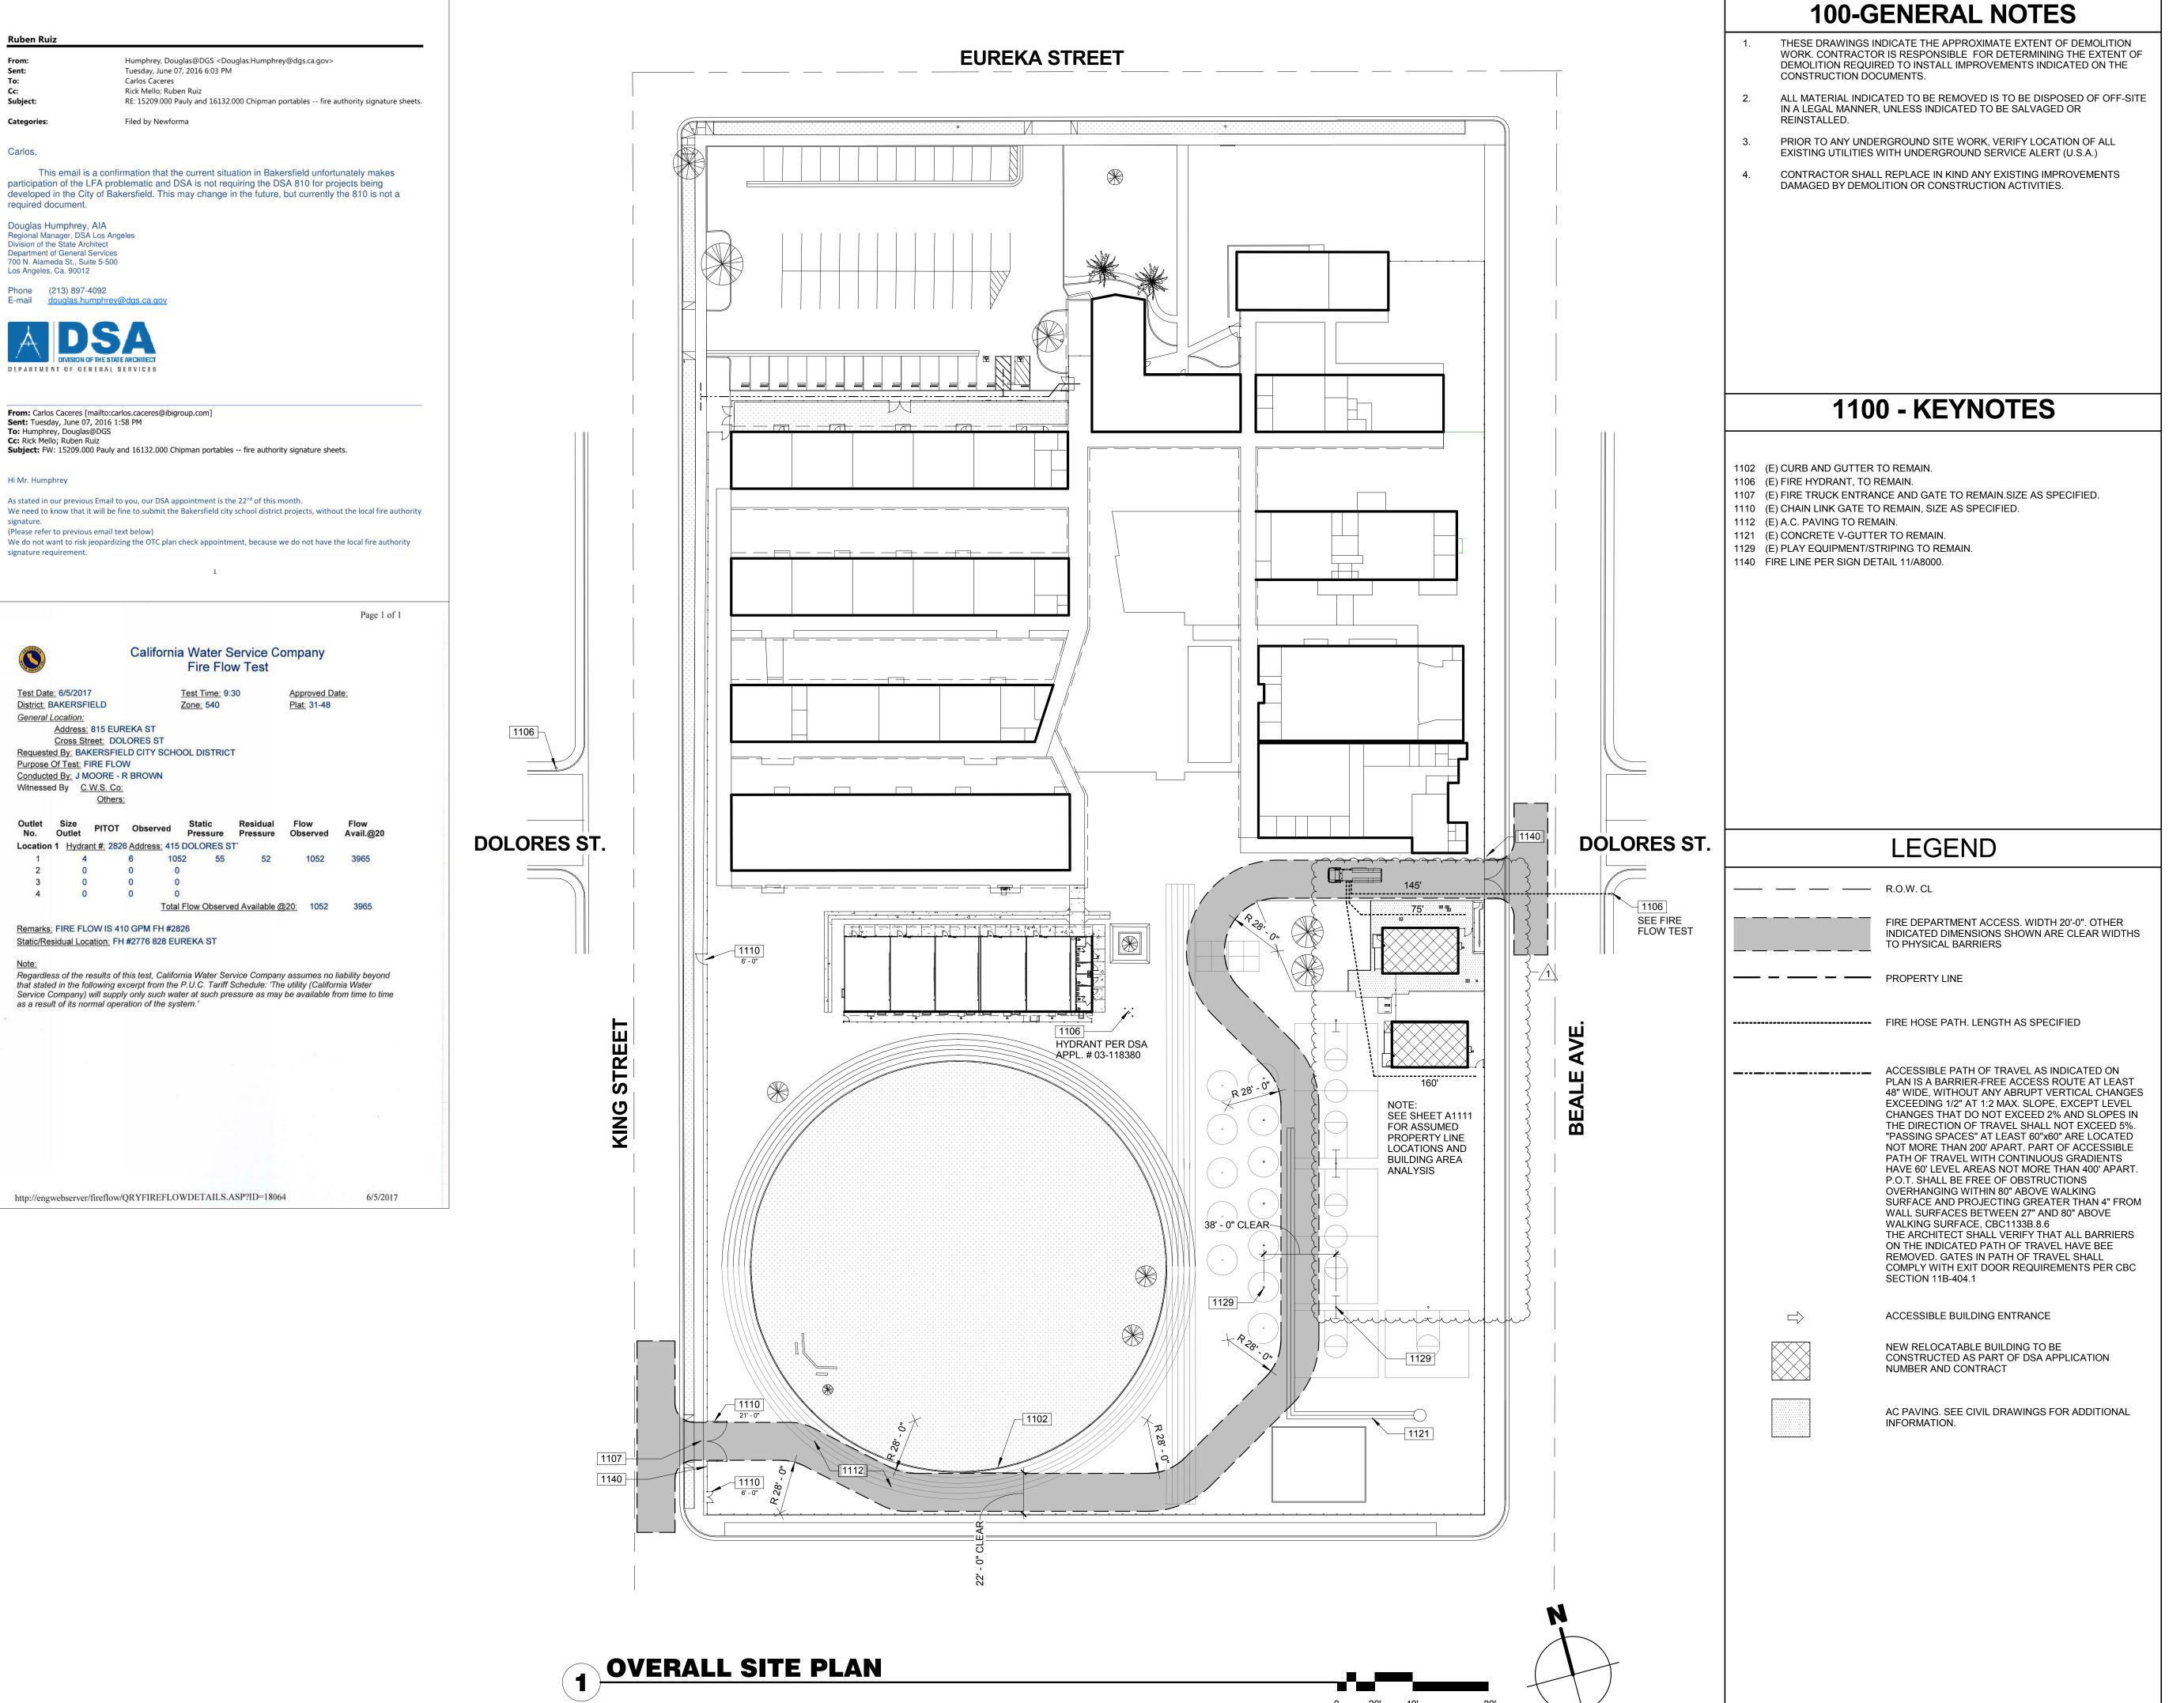

ARCHITECTURE PLANNING

ibigroup.com

PRIME CONSULTANT

San Luis Obispo 4119 Broad Street, Suite 210 San Luis Obispo, CA 93401 805.546.0433 fax: 805.546.0504




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	REVISIONS			
NO.	DATE	APPRD.	DESCRIPTION	
	08-30-2019		DSA CCD #1	

CONSULTANT



AGENCY INFORMATION:

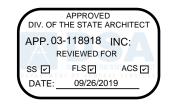AGENCY TRACKING NO. 63321-289 FILE NO. 15-6

IDENTIFICATION STAMP DIV. OF THE STATE ARCHITECT OFFICE OF REGULATION SERVICES 03-118918 AC____FLS____SS____

BAKERSFIELD CITY SCHOOL



BESSIE OWENS INTERMEDIATE -RELOCATBLES R6 & R7

815 EUREKA ST. BAKERSFIELD CA, 93305


		899
PROJECT NO:	109668	-109 -109
DRAWN BY:	rRr	TWVTV
CHK'D BY:	RM	116VA
ISSUE DATE:	05/24/2018	1120
SHEET TITLE		ZEV 218

FIRE ACCESS

SHEET NUMBER

CCD #1

G1200

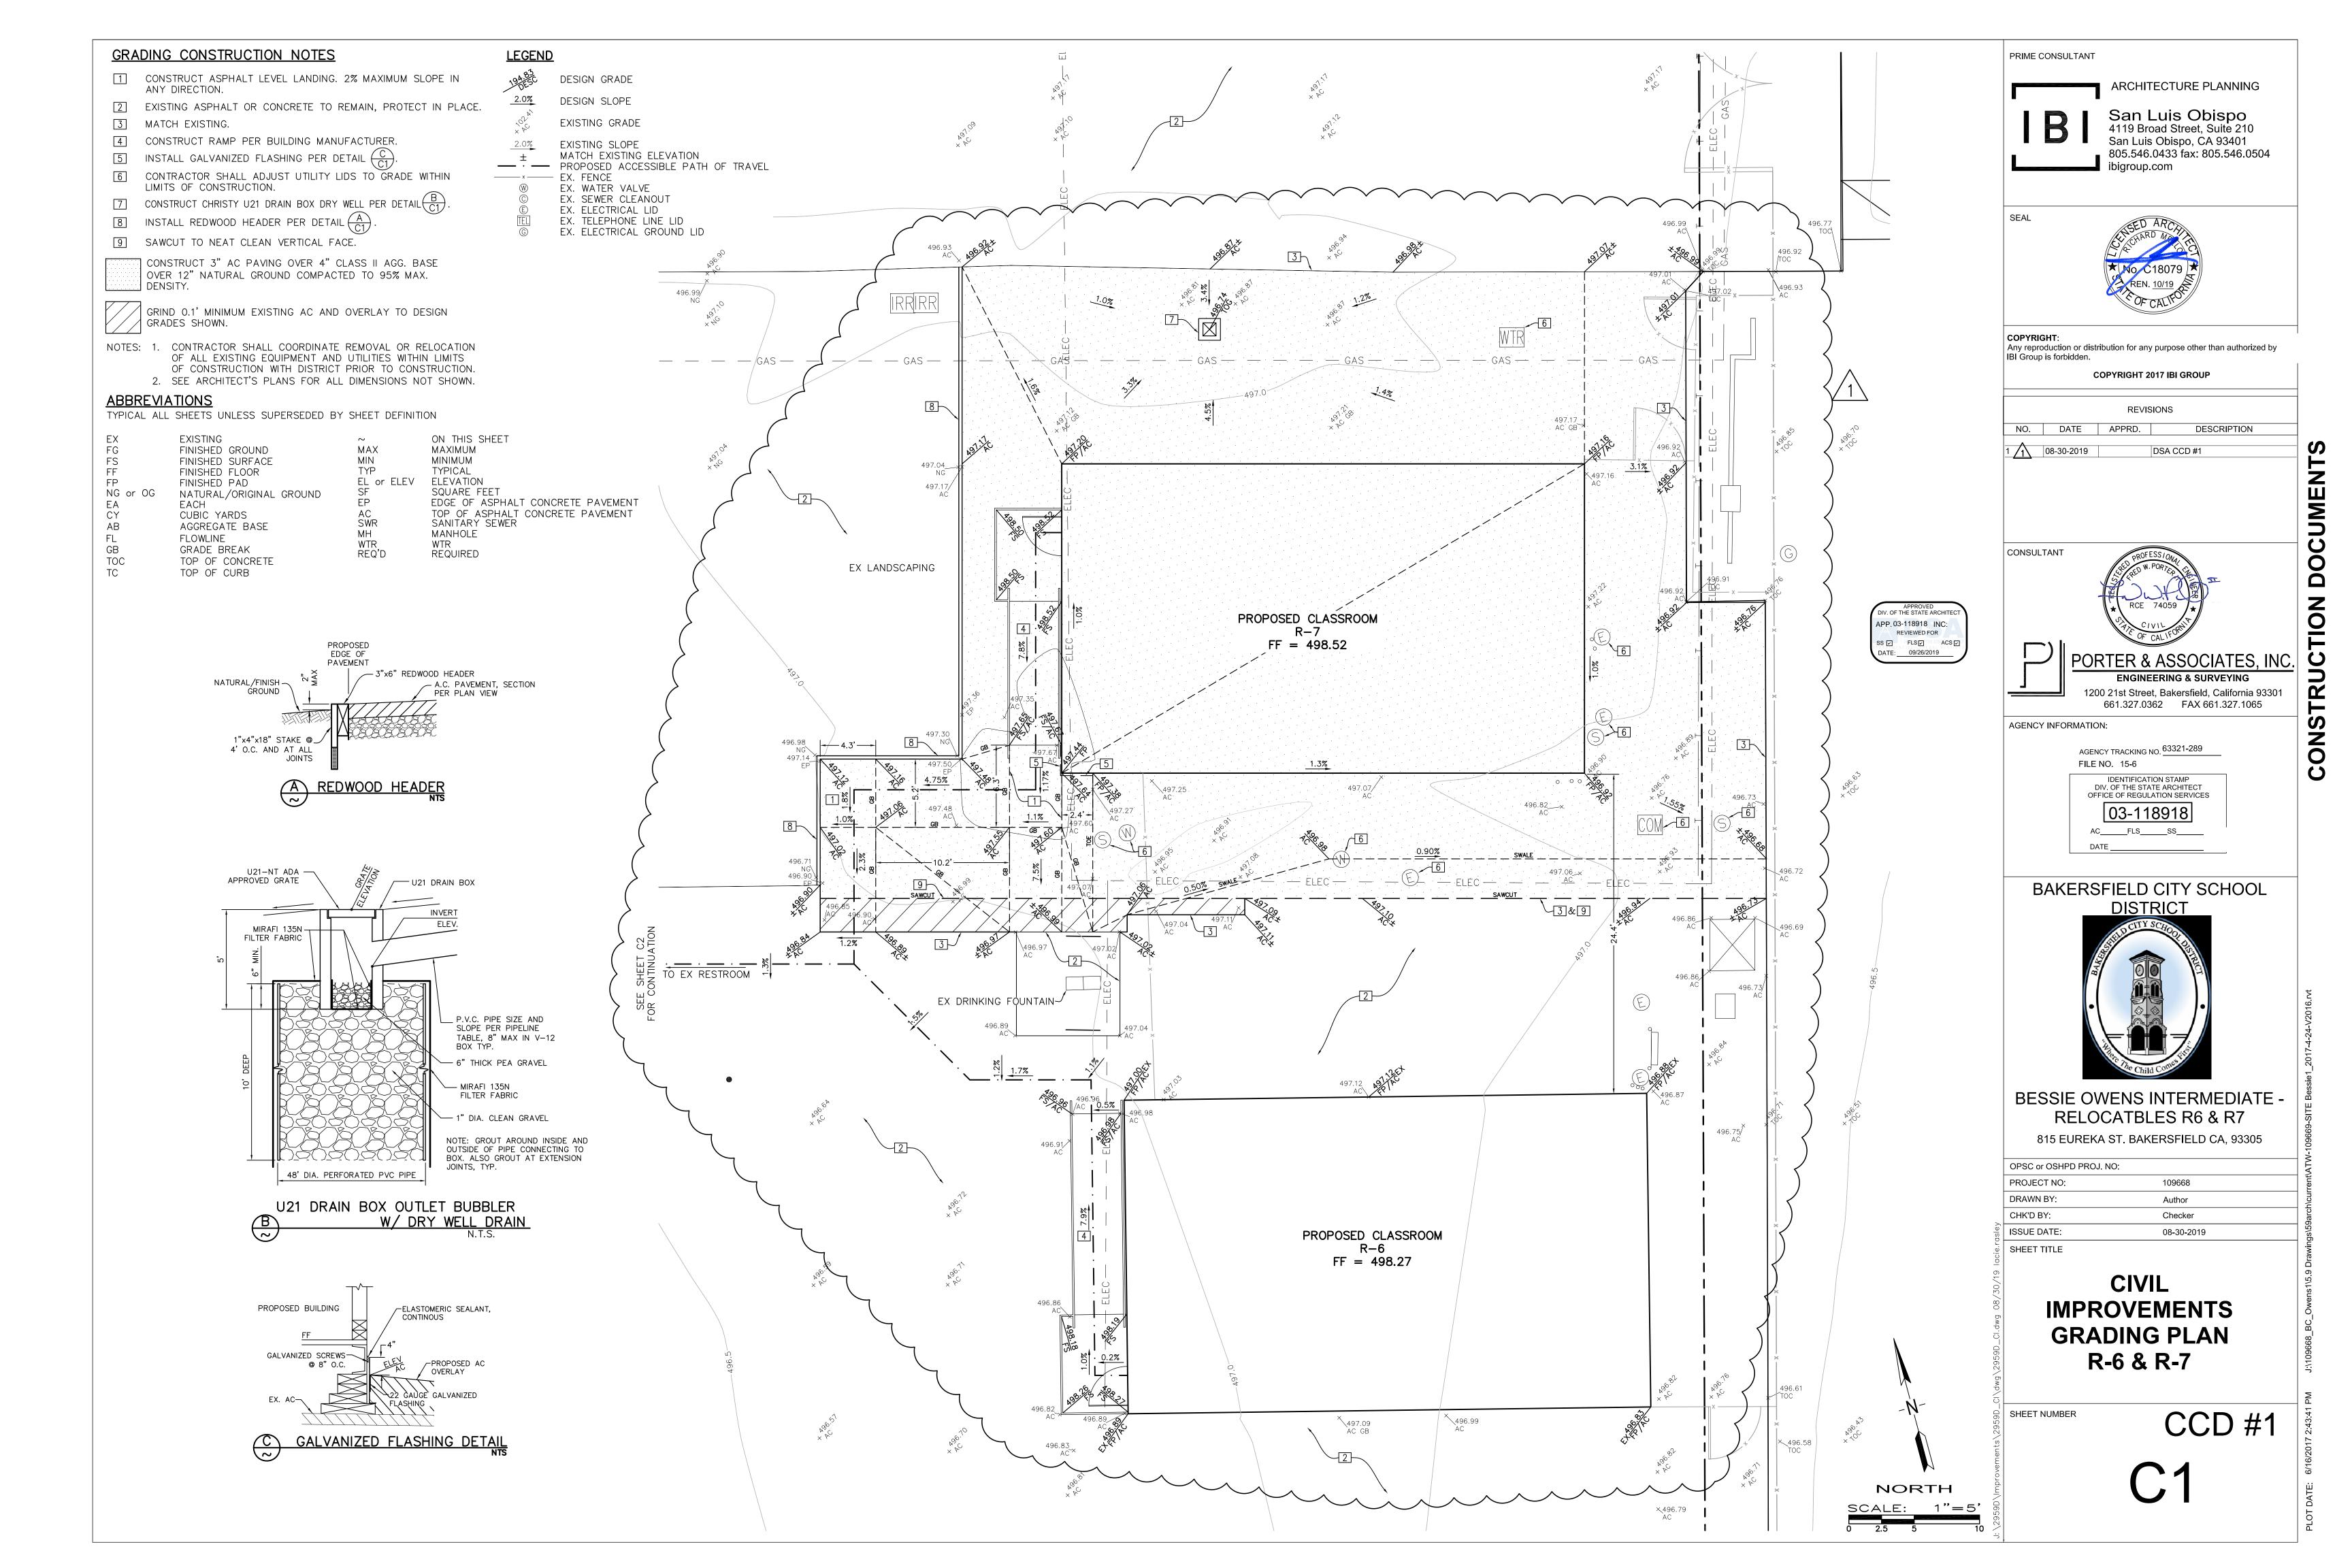

GENERAL SPECIFICATIONS

- 1. ALL CONSTRUCTION SHALL CONFORM TO THIS PLAN, THE CALIFORNIA BUILDING CODE, AND STANDARDS PERTAINING THERETO. THESE DOCUMENTS SHALL BE MADE A PART HEREOF.
- 2. THE CONTRACTOR IS RESPONSIBLE FOR VERIFYING DIMENSIONS, DATA AND MEASUREMENTS AT THE BUILDING SITE PRIOR TO CONSTRUCTION. DO NOT SCALE DRAWINGS. WRITTEN DIMENSIONS ON THESE DRAWINGS SHALL HAVE PRECEDENCE OVER SCALED DIMENSIONS. PORTER & ASSOCIATES, INC. MUST BE NOTIFIED OF ANY VARIATIONS FROM THE DIMENSIONS AND CONDITIONS SHOWN BY THESE DRAWINGS.
- 3. EXISTING UTILITY AND UNDERGROUND LINES HAVE BEEN SHOWN ON THIS PLAN ACCORDING TO AVAILABLE RECORDS. THE ENGINEER IS NOT RESPONSIBLE FOR POSSIBLE ERRORS OR OMISSIONS. THE CONTRACTOR IS RESPONSIBLE FOR VERIFICATION OF THE LOCATION AND DEPTH OF ALL UTILITIES PRIOR TO BEGINNING OF ANY WORK. UNDERGROUND SERVICE ALERT (U.S.A.: 1-800-227-2600) SHALL BE CONTACTED AT LEAST TWO WORKING DAYS PRIOR TO ANY CONSTRUCTION OR EXCAVATION.
- 4. ANY EXISTING IMPROVEMENTS OR UTILITIES THAT ARE REMOVED, DAMAGED OR UNDERCUT BY CONTRACTOR'S OPERATIONS SHALL BE REPAIRED OR REPLACED AT THE CONTRACTOR'S EXPENSE, AS DIRECTED BY THE ENGINEER AND APPROVED BY THE GOVERNING AUTHORITY.
- 5. IF A PROBLEM OR CONFLICT SHOULD ARISE DURING THE COURSE OF THE PROJECT, IT IS THE RESPONSIBILITY OF THE OWNER OR THE CONTRACTOR TO NOTIFY THE ENGINEER IMMEDIATELY PRIOR TO ANY FURTHER WORK.
- 6. THE CONTRACTOR SHALL FURNISH ALL LABOR, MATERIALS, TOOLS, EQUIPMENT AND SUPERVISION NECESSARY FOR A COMPLETE AND FUNCTIONAL PRODUCT.
- 7. ALL WORK WHICH IS DEFECTIVE IN ITS CONSTRUCTION OR DEFICIENT IN ANY OF THE REQUIREMENTS OF THESE DRAWINGS AND SPECIFICATIONS SHALL BE REMEDIED, OR REMOVED AND REPLACED BY THE CONTRACTOR IN AN ACCEPTABLE MANNER, AND NO COMPENSATION WILL BE ALLOWED FOR SUCH CORRECTION.
- 8. IN THE EVENT CONSTRUCTION STAKING BASED ON THE CONSULTANT'S PLANS, DRAWINGS OR OTHER DOCUMENTS IS ACCOMPLISHED BY ANYONE OTHER THAN THE CONSULTANT, THE OWNER OR CONTRACTOR SHALL NOTIFY THE BUILDING OFFICIAL IN WRITING AS TO THE CHANGE OF ENGINEER IN RESPONSIBLE CHARGE.
- 9. THE CONTRACTOR AGREES THAT HE SHALL ASSUME SOLE AND COMPLETE RESPONSIBILITY FOR JOB SITE CONDITIONS DURING THE COURSE OF CONSTRUCTION OF THIS PROJECT; INCLUDING EROSION, SEDIMENTATION & DUST CONTROL PLAN AND STORM WATER POLLUTION PREVENTION PLAN IMPLEMENTATION AND THE SAFETY OF ALL PERSONS AND PROPERTY; THAT THIS REQUIREMENT SHALL APPLY CONTINUOUSLY AND NOT BE LIMITED TO NORMAL WORKING HOURS; AND THAT THE CONTRACTOR SHALL DEFEND, INDEMNIFY AND HOLD THE OWNER AND THE ENGINEER HARMLESS FROM ANY AND ALL LIABILITY, REAL OR ALLEGED, IN CONNECTION WITH THE PERFORMANCE OF WORK ON THIS PROJECT, EXCEPTING FOR LIABILITY ARISING FROM THE SOLE NEGLIGENCE OF THE OWNER OR THE ENGINEER.
- 10. IF THE CONTRACTOR IS IN DOUBT AS TO THE MEANING OF ANY PART OF THE DRAWINGS AND SPECIFICATIONS OR FINDS DISCREPANCIES IN OR OMISSIONS FROM THE DRAWINGS, HE SHALL SUBMIT A WRITTEN REQUEST FOR AN INTERPRETATION OR A CORRECTION THEREOF, PRIOR TO FILING HIS BID PRICE FOR THE PROJECT.
- 11. PORTER & ASSOCIATES, INC. WILL NOT BE RESPONSIBLE OR LIABLE FOR UNAUTHORIZED CHANGES TO OR USES OF THESE PLANS. ANY AND ALL CHANGES TO THESE PLANS MUST BE APPROVED IN WRITING BY PORTER & ASSOCIATES, INC.

ACCESSIBILITY SPECIFICATIONS

- ACCESSIBILITY NOTES ARE PROVIDED FOR REFERENCE ONLY. ALL WORK SHALL BE PERFORMED IN ACCORDANCE WITH APPLICABLE SECTIONS OF THE CALIFORNIA BUILDING CODE AND ADA STANDARDS. THE CONTRACTOR SHALL OBTAIN THE LATEST EDITION THEREOF.
- 2. CURB RAMPS SHALL BE 8.33% MAXIMUM GRADE.
- 3. PERPENDICULAR CURB RAMP SIDE SLOPES SHALL NOT EXCEED 10% GRADIENT.
- 4. SURFACE SLOPE OF RAMPS SHALL NOT EXCEED 8.33%.

AND 4" MAXIMUM ABOVE THE WALKWAY SURFACE.

- 5. ACCESSIBLE ROUTE SLOPES SHALL NOT EXCEED 5%, UNLESS CONSTRUCTED AS A RAMP AND HANDRAILS ARE PROVIDED.
- 6. ACCESSIBLE ROUTE CROSS SLOPES SHALL NOT EXCEED 2%.
- 7. RAMP LANDINGS SHALL NOT EXCEED 2% MAXIMUM GRADE IN ANY DIRECTIONS.
- 8. GRATINGS LOCATED WITHIN ACCESSIBLE ROUTES SHALL HAVE MAXIMUM 1/2" OPENINGS IN THE DIRECTION OF PEDESTRIAN
- 9. TRANSITIONS ALONG ACCESSIBLE ROUTES SHALL BE FLUSH WITH CHANGES IN LEVEL NO GREATER THAN ½". CHANGES IN LEVEL BETWEEN ¼" AND ½" SHALL BE BEVELED WITH A MINIMUM GRADIENT OF 1:2. CHANGES IN LEVEL BETWEEN 0" AND ¼" MAY BE VERTICAL.
- MAY BE VERTICAL.

 10. EXCEPT BETWEEN SIDEWALKS AND ADJACENT STREETS OR DRIVEWAYS, ABRUPT CHANGES IN LEVEL EXCEEDING 4" ALONG A PATH OF TRAVEL SHALL BE PROTECTED BY A WARNING CURB A MINIMUM OF 6" IN HEIGHT ABOVE THE WALKWAY SURFACE.
- 11. ALL ACCESSIBLE DOORS SHALL HAVE LEVEL LANDINGS IN ACCORDANCE WITH CALIFORNIA BUILDING CODE, CURRENT EDITION.

A WARNING CURB IS NOT REQUIRED WHEN A GUARD OR HANDRAIL IS PROVIDED WITH A GUIDE RAIL CENTERED 2" MINIMUM

12. ACCESSIBLE PARKING STALLS AND LOADING AISLES SHALL NOT EXCEED 2% MAXIMUM GRADE IN ANY DIRECTION.

ASPHALT CONCRETE SPECIFICATIONS

- . THIS SECTION COVERS THE FURNISHING OF LABOR AND EQUIPMENT FOR EXCAVATION, TRENCHING, BACKFILLING AND ALL OTHER EARTHWORK OPERATIONS REQUIRED TO COMPLETE THE INSTALLATION OF ASPHALT PAVING AS INDICATED ON THE DRAWINGS AND HEREIN SPECIFIED. ALL REFERENCES TO PROVISIONS SHALL BE TO THE CALTRANS STANDARD SPECIFICATIONS, CURRENT EDITION, UNLESS OTHERWISE NOTED.
- 2. AGGREGATE BASE SHALL BE "CLASS 2" UNLESS OTHERWISE NOTED AND SHALL CONFORM TO THE PROVISIONS IN SECTION 26, "AGGREGATE BASES," OF THE CALTRANS STANDARD SPECIFICATIONS. AGGREGATE BASE SHALL BE COMPACTED TO A MINIMUM OF 95% OF MAXIMUM DRY DENSITY.
- 3. ASPHALT CONCRETE SHALL BE "TYPE B" UNLESS OTHERWISE NOTED AND SHALL CONFORM TO THE PROVISIONS IN SECTION 39, "ASPHALT CONCRETE," OF THE CALTRANS STANDARD SPECIFICATIONS AND THE FOLLOWING SPECIAL PROVISIONS:
- A. ASPHALT CONCRETE SHALL HAVE A BITUMINOUS BINDER. THE BINDER SHALL BE PG 64—10 PERFORMANCE GRADED ASPHALT AND SHALL CONFORM TO THE REQUIREMENTS OF THE TABLE FOR PERFORMANCE GRADED ASPHALT BINDER IN SECTION 92—1.02(B), "GRADES" OF THE STANDARD SPECIFICATIONS.
- B. THE AMOUNT OF BITUMINOUS BINDER TO BE MIXED WITH THE MINERAL AGGREGATE SHALL BE BETWEEN FOUR PERCENT (4%) AND SIX PERCENT (6%) BY WEIGHT OF DRY MINERAL AGGREGATE. THE EXACT AMOUNT OF BITUMINOUS BINDER TO BE MIXED WITH THE MINERAL AGGREGATE WILL BE DETERMINED BY THE ENGINEER.
- C. ASPHALT CONCRETE SURFACING SHALL BE CONSTRUCTED IN ACCORDANCE WITH REQUIREMENTS OF SECTION 39. A PRIME COAT SHALL NOT BE APPLIED TO THE BASE PRIOR TO PLACING ASPHALT CONCRETE SURFACING. A TACK COAT SHALL BE APPLIED PRIOR TO PAVING OVER EXISTING ASPHALT CONCRETE SURFACING. TACK COAT SHALL CONFORM TO
- CALTRANS STANDARD SPECIFICATION SECTION 94; ASPHALT GRADE EMULSION SS-1, SS-1N, CSS-1 AND CSS-1N.

 D. ASPHALT CONCRETE SHALL BE COMPACTED TO 92-94% OF THE MAXIMUM THEORETICAL DENSITY AS DETERMINED BY
- E. AT CONNECTIONS TO EXISTING AC SURFACES, THE EXISTING SURFACE SHALL BE SAWCUT AND REMOVED TO A NEAT LINE BEFORE THE PAVING OR AS DIRECTED BY THE ENGINEER.

ASTM D-2041. IN-PLACE DENSITY SHALL BE DETERMINED IN ACCORDANCE WITH CALIFORNIA TEST 375.

- F. THE MIXTURE SHALL BE APPLIED AT A MINIMUM TEMPERATURE OF 225°F. SPREADING SHALL BE PERFORMED BY SELF—PROPELLED ASPHALT PAVERS THAT PRODUCE AN ASPHALT CONCRETE SURFACING OF UNIFORM SMOOTHNESS AND TEXTURE
- G. ALL SPILLAGE OF ASPHALT CONCRETE OUTSIDE OF THE DESIGNATED PAVING AREA SHALL BE PROMPTLY SWEPT UP AND REMOVED.
- H. FOG SEAL SHALL BE APPLIED TO ALL NEWLY PAVED SURFACES WITHIN TWO WEEKS AFTER THE PAVING IS PLACED. FOG SEAL SHALL BE APPLIED IN ACCORDANCE WITH SECTION 37-1; GRADE MEDIUM FINE; ASPHALTIC EMULSION GRADE SS-1.
- I. FINISHING ROADWAY SHALL CONFORM TO THE PROVISIONS OF SECTION 22.
- J. ALL ASPHALT CONCRETE SHALL BE CONSTRUCTED TO THE TOLERANCES ALLOWED IN SECTION 39—6.03 AS MODIFIED BY THESE PLANS. A.C. AND BASE THICKNESS SHOWN ON THESE PLANS ARE MINIMUMS AND LESSER THICKNESS WILL NOT BE ALLOWED.
- 4. A TINTED PRE-EMERGENT HERBICIDE SHALL BE APPLIED OVER NATURAL GROUND IN ALL AC PAVED PARKING LOT AREAS AND DRIVE AISLES PRIOR TO PLACING ANY BASE OR PAVING. APPLY IN STRICT ACCORDANCE WITH MANUFACTURER'S INSTRUCTIONS. NO WEED CONTROL CHEMICAL IS TO BE APPLIED TO AREAS DESIGNATED FOR PLANTING.

PRIME CONSULTANT

ARCHITECTURE PLANNING



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NO.	DATE	APPRD.	DESCRIPTION
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1200 21st Street, Bakersfield, California 93301 661.327.0362 FAX 661.327.1065

AGENCY INFORMATION:

APPROVED
DIV. OF THE STATE ARCHITECT
APP. 03-118918 INC:
REVIEWED FOR
SS FLS ACS D
DATE: 09/26/2019

AGENCY TRACKING NO. 63321-289
FILE NO. 15-6

identification stamp
DIV. of the state architect
OFFICE OF REGULATION SERVICES

03-118918

AC____FLS___SS__
DATE ____

BAKERSFIELD CITY SCHOOL



BESSIE OWENS INTERMEDIATE - RELOCATBLES R6 & R7

815 EUREKA ST. BAKERSFIELD CA, 93305

OPSC or OSHPD PROJ. NO:

PROJECT NO:

DRAWN BY:

CHK'D BY:

ISSUE DATE:


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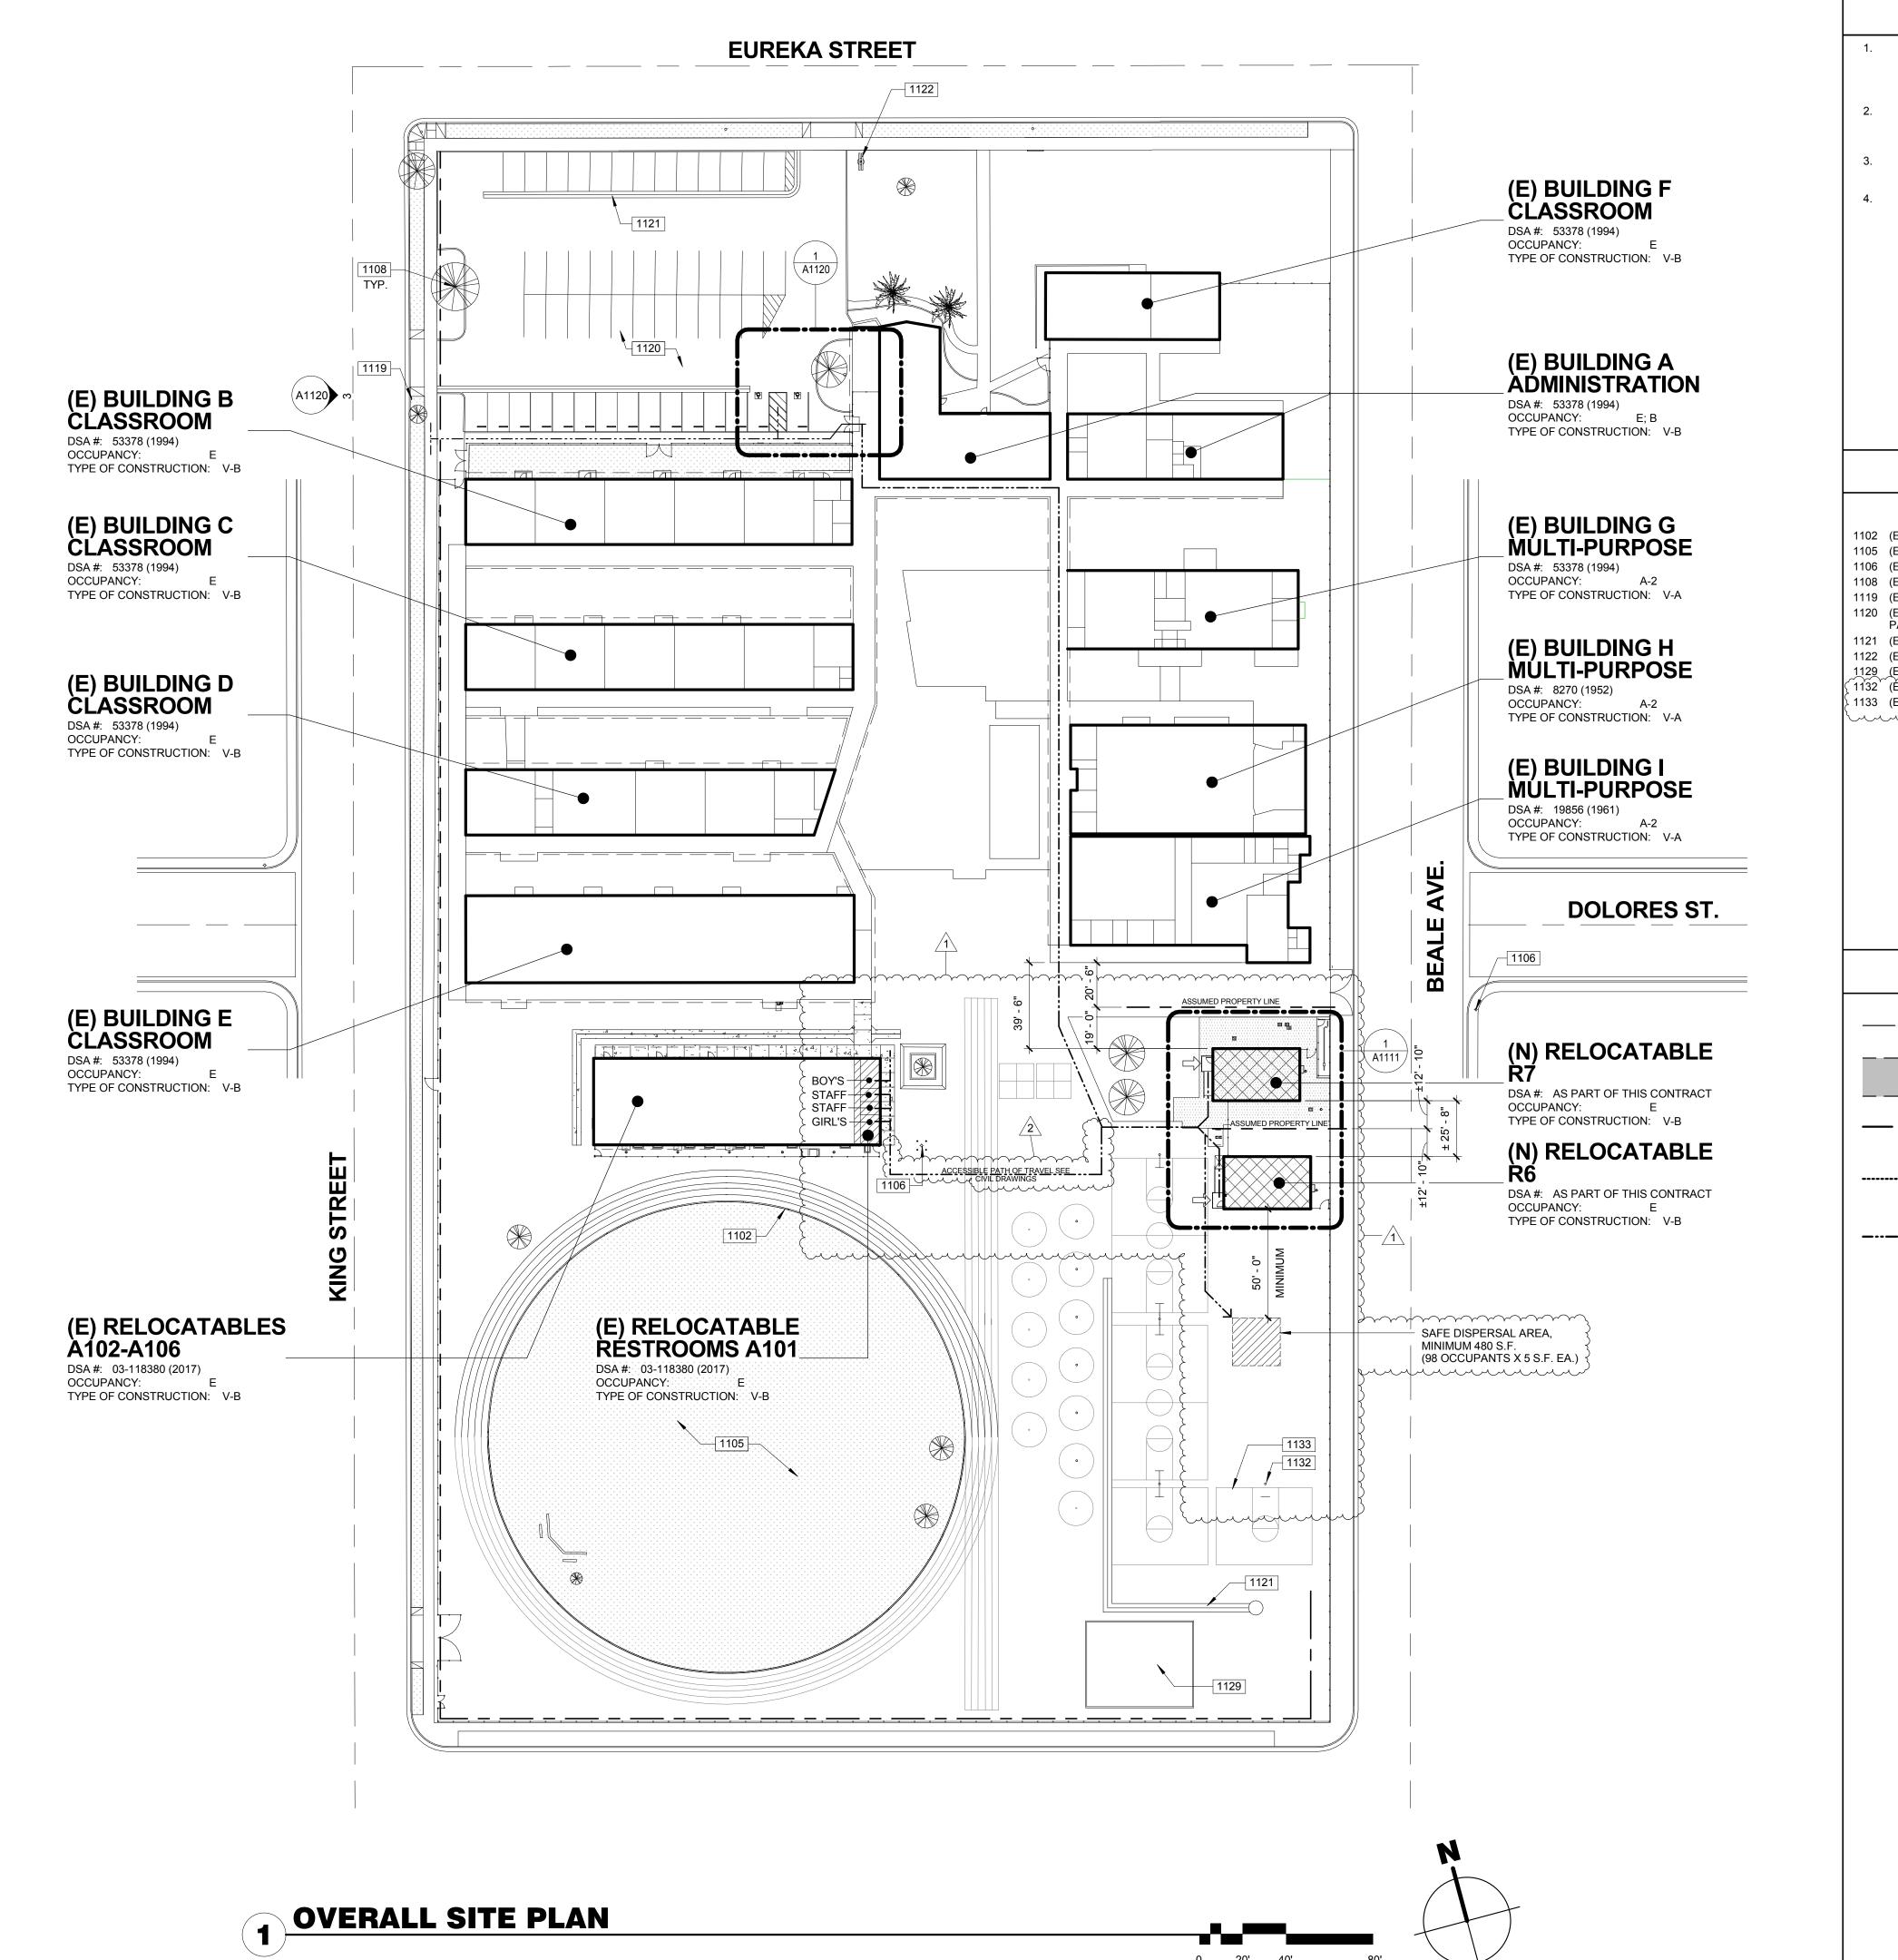
CIVIL
IMPROVEMENTS
GRADING PLAN
PATH OF TRAVEL

SHEET NUMBER

CCD #1

C2



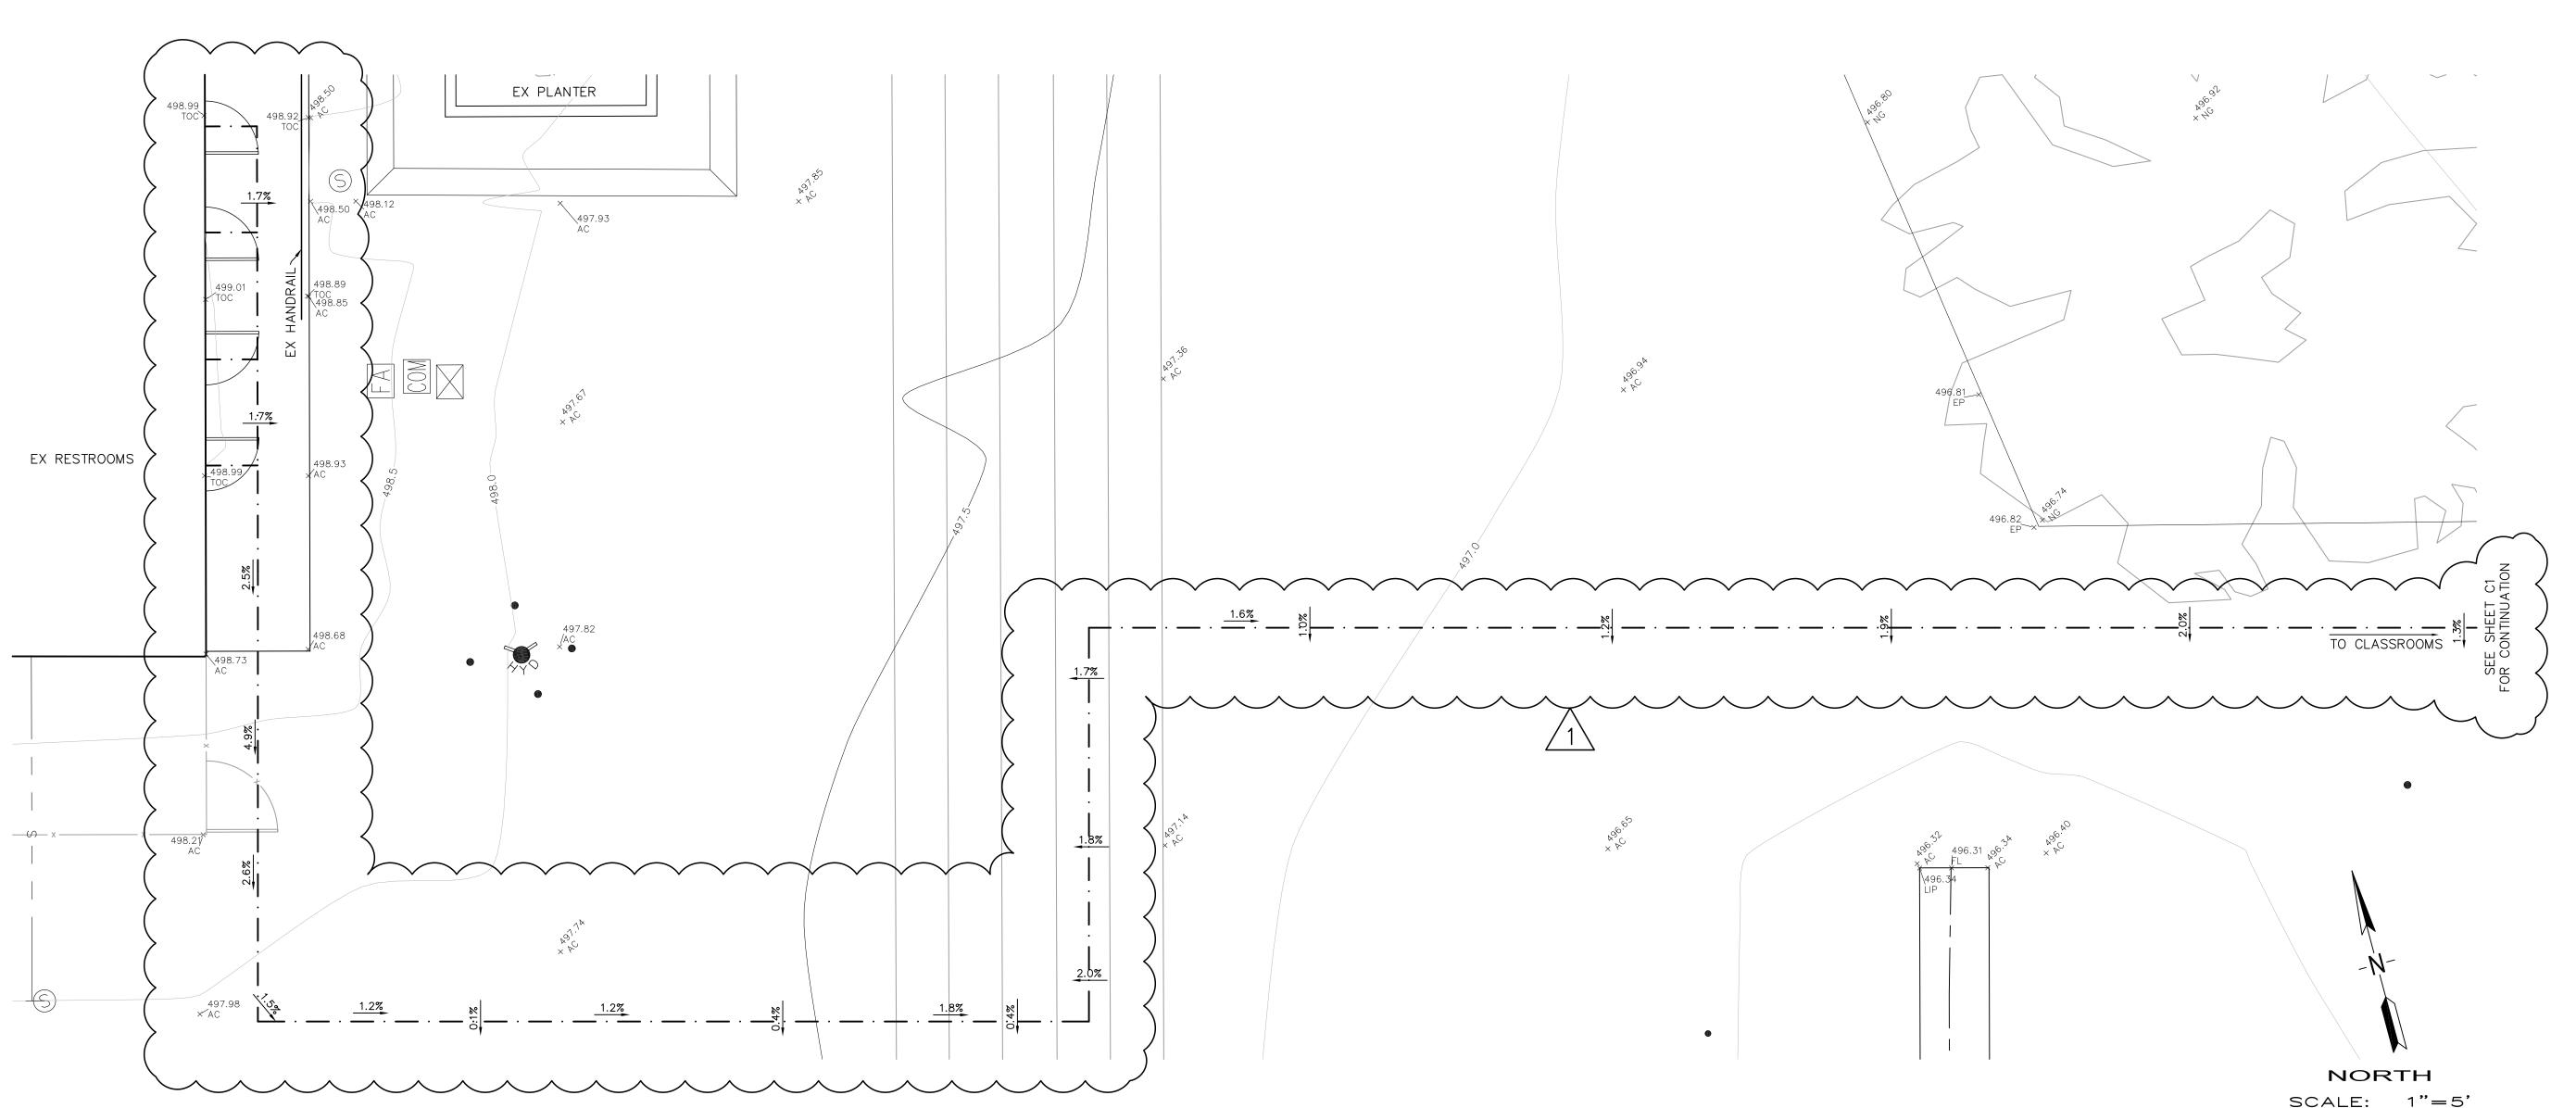

100-GENERAL NOTES

- . THESE DRAWINGS INDICATE THE APPROXIMATE EXTENT OF DEMOLITION WORK. CONTRACTOR IS RESPONSIBLE FOR DETERMINING THE EXTENT OF DEMOLITION REQUIRED TO INSTALL IMPROVEMENTS INDICATED ON THE CONSTRUCTION DOCUMENTS.
- ALL MATERIAL INDICATED TO BE REMOVED IS TO BE DISPOSED OF OFF-SITE IN A LEGAL MANNER, UNLESS INDICATED TO BE SALVAGED OR
- 3. PRIOR TO ANY UNDERGROUND SITE WORK, VERIFY LOCATION OF ALL EXISTING UTILITIES WITH UNDERGROUND SERVICE ALERT (U.S.A.)
- CONTRACTOR SHALL REPLACE IN KIND ANY EXISTING IMPROVEMENTS DAMAGED BY DEMOLITION OR CONSTRUCTION ACTIVITIES.

1100 - KEYNOTES

- 1102 (E) CURB AND GUTTER TO REMAIN.
- 1105 (E) TURF/LANDSCAPE AREA TO REMAIN.
- 1106 (E) FIRE HYDRANT, TO REMAIN.1108 (E) TREE TO REMAIN.
- 1119 (E) PARKING ENTRY SIGN TO REMAIN. SEE DETAIL 03/A1120.
- 1120 (E) A.C. PAVED PARKING TO REMAIN.SEE DETAIL 01/A1120 FOR ACCESSIBLE PARKING CONDITIONS.
- 1121 (E) CONCRETE V-GUTTER TO REMAIN.
- 1122 (E) MARQUEE SIGN TO REMAIN.
- 1129 (E) PLAY EQUIPMENT/STRIPING TO REMAIN. 1132 (É) BACKSTOP TO REMAIN - TYPICAL U.O.N.
- 1133 (E) PLAY LINES TO REMAIN TYPICAL U.O.N.

LEGEND

----- R.O.W. CL

FIRE DEPARTMENT ACCESS. WIDTH 20'-0". OTHER INDICATED DIMENSIONS SHOWN ARE CLEAR WIDTHS TO PHYSICAL BARRIERS

PROPERTY LINE

SECTION 11B-404.1

FIRE HOSE PATH. LENGTH AS SPECIFIED

ACCESSIBLE PATH OF TRAVEL AS INDICATED ON PLAN IS A BARRIER-FREE ACCESS ROUTE AT LEAST 48" WIDE, WITHOUT ANY ABRUPT VERTICAL CHANGES EXCEEDING 1/2" AT 1:2 MAX. SLOPE, EXCEPT LEVEL CHANGES THAT DO NOT EXCEED 2% AND SLOPES IN THE DIRECTION OF TRAVEL SHALL NOT EXCEED 5%. "PASSING SPACES" AT LEAST 60"x60" ARE LOCATED NOT MORE THAN 200' APART. PART OF ACCESSIBLE PATH OF TRAVEL WITH CONTINUOUS GRADIENTS HAVE 60' LEVEL AREAS NOT MORE THAN 400' APART. P.O.T. SHALL BE FREE OF OBSTRUCTIONS OVERHANGING WITHIN 80" ABOVE WALKING SURFACE AND PROJECTING GREATER THAN 4" FROM WALL SURFACES BETWEEN 27" AND 80" ABOVE WALKING SURFACE, CBC1133B.8.6 THE ARCHITECT SHALL VERIFY THAT ALL BARRIERS ON THE INDICATED PATH OF TRAVEL HAVE BEE REMOVED. GATES IN PATH OF TRAVEL SHALL

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ACCESSIBLE BUILDING ENTRANCE

COMPLY WITH EXIT DOOR REQUIREMENTS PER CBC

NEW RELOCATABLE BUILDING TO BE CONSTRUCTED AS PART OF DSA APPLICATION NUMBER AND CONTRACT

AC PAVING. SEE CIVIL DRAWINGS FOR ADDITIONAL INFORMATION.

PRIME CONSULTANT

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San Luis Obispo, CA 93401
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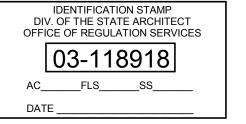
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	08-30-2019		DSA CCD #1		
	09-12-2019 Clarification to CCD #1				

CONSULTANT



AGENCY INFORMATION:

AGENCY TRACKING NO. 63321-289 FILE NO. 15-6



BAKERSFIELD CITY SCHOOL



BESSIE OWENS INTERMEDIATE - RELOCATBLES R6 & R7

815 EUREKA ST. BAKERSFIELD CA, 93305

PROJECT NO:	109668
DRAWN BY:	rRr
CHK'D BY:	RM
ISSUE DATE:	05/24/2018

SHEET TITLE

OVERALL SITE PLAN


SHEET NUMBER

CCD #1

A1100

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1 PARTIAL DEMOLITION SITE PLAN

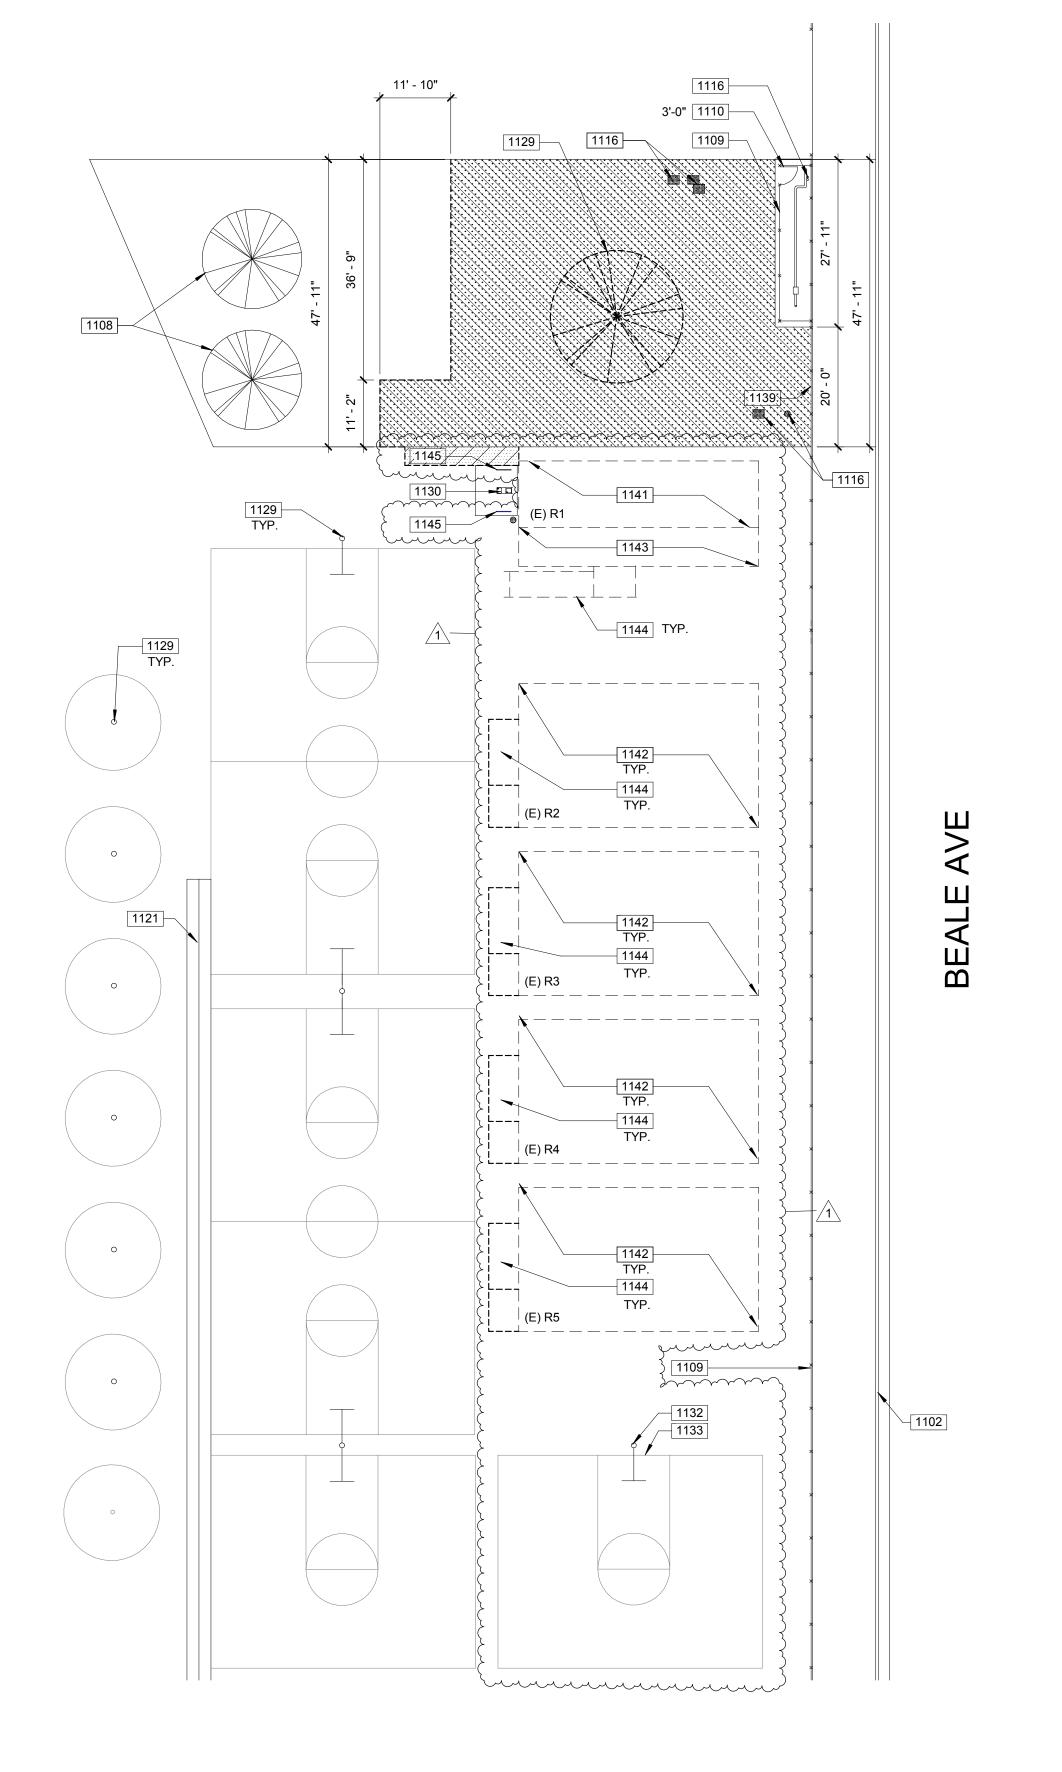


100-GENERAL NOTES

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- ALL MATERIAL INDICATED TO BE REMOVED IS TO BE DISPOSED OF OFF-SITE IN A LEGAL MANNER, UNLESS INDICATED TO BE SALVAGED OR REINSTALLED.
- PRIOR TO ANY UNDERGROUND SITE WORK, VERIFY LOCATION OF ALL EXISTING UTILITIES WITH UNDERGROUND SERVICE ALERT (U.S.A.)
- CONTRACTOR SHALL REPLACE IN KIND ANY EXISTING IMPROVEMENTS DAMAGED BY DEMOLITION OR CONSTRUCTION ACTIVITIES.


1100 - KEYNOTES

- 1102 (E) CURB AND GUTTER TO REMAIN.
- 1108 (E) TREE TO REMAIN.
- 1109 (E) CHAIN LINK FENCE TO REMAIN.
- 1110 (E) CHAIN LINK GATE TO REMAIN, SIZE AS SPECIFIED.
- 1116 (E) UTILITY BOXES/METER TO REMAIN. 1121 (E) CONCRETE V-GUTTER TO REMAIN.
- 1129 (E) PLAY EQUIPMENT/STRIPING TO REMAIN.
- 1130 (E) DRINKING FOUNTAIN TO BE REMAIN, PER DSA A#03-115433. SEE DETAIL 2/1130. 🕻 1132 (Ė) BACKSTOP TO REMAIN - TYPIČAL U.O.N. }____/\
- (1133) (E) PLAY LINES TO REMAIN TYPICAL U.O.N.
- 1139 REMOVE PORTION ON CHAIN LINK FENCE TO ACCOMMODATE NEW GATE.
- Ĩ 1 1 41 T (Ĕ) ŘELŐCÁTÁBLE ŘEŠTŘOŎM BUĬLDĬNĠ RĚMŐVĚD FRŐM SITE.
- 1142 (E) RELOCATABLE CLASSROOM BUILDING REMOVED FROM SITE. 1143 (E) ELEVATED LANDING REMOVED FROM SITE.
- 1144 (E) ACCESS RAMP REMOVED FROM SITE.
- 1145 (E) GALVANIZED GUARD RAILS TO REMAIN. DSA APPL. No. 03-115433 CERTIFIED
- #1 (5-22-2017).

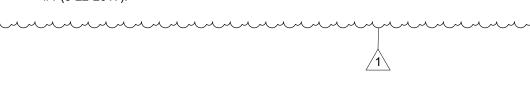


LEGEND

REMOVE (E) CONSTRUCTION, REFER TO DEMOLITION KEYNOTES FOR ADDITIONAL INFORMATION

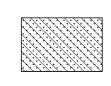

REMOVE (E) TURF/LANDSCAPE AREA IN ITS ENTIRETY. PREP SOIL TO RECEIVE NEW SITE IMPROVEMENTS PER SITE & CIVIL DRAWINGS.

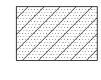

REMOVE (E) A.C. PAVING IN ITS ENTIRETY.
PREP SOIL TO RECEIVE NEW SITE IMPROVEMENTS PER SITE

PRIME CONSULTANT

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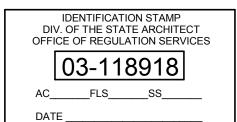
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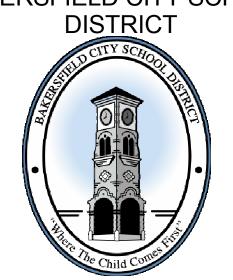


AGENCY INFORMATION:

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BAKERSFIELD CITY SCHOOL



BESSIE OWENS INTERMEDIATE -RELOCATBLES R6 & R7

815 EUREKA ST. BAKERSFIELD CA, 93305

PROJECT NO:	109668
DRAWN BY:	Author
CHK'D BY:	Checker
ISSUE DATE:	05/24/2018

SHEET TITLE

DEMOLITION SITE PLAN

SHEET NUMBER

CCD #1

A1110 D

NOTE: SEE SHEET A1130 FOR (E) RESTROOM MODIFICATIONS

BUILDING DATA - R7

BUILDING R7:

OCCUPANCY:

BUILDING R7:

OCCUPANCY:

No OF OCUPANTS:

TYPE OF CONSTRUCTION:...

ALLOWABLE BUILDING AREA:..

ACTUAL BUILDING AREA: R7

No OF OCUPANTS:

TYPE OF CONSTRUCTION:. ALLOWABLE BUILDING AREA:..

ACTUAL BUILDING AREA: R7

BUILDING DATA - R6

ALLOCATION BOARD REGULATIONS SECTION 1865.3.3.

ALLOCATION BOARD REGULATIONS SECTION 1865.3.3.

AREA CALCULATIONS ARE ACCORDING TO CBC TABLE 506.2, AND ARE FOR THE CONVENIENCE OF

AREA CALCULATIONS ARE ACCORDING TO CBC TABLE 506.2, AND ARE FOR THE CONVENIENCE OF

CONTRACTOR. THESE AREAS WILL NOT MATCH AREAS CALCULATED IN ACCORDANCE WITH STATE

48, OCCUPANT LOAD FACTOR 20 SF/PERSON

DSA PLANCHECKERS ONLY. AREAS ARE NOT TO BE USED FOR ESTIMATING PURPOSED BY THE

960 S.F. < 9,500 S.F.

9,500 S.F.

960 S.F.

960 S.F. < 9,500 S.F.

48, OCCUPANT LOAD FACTOR 20 SF/PERSON

DSA PLANCHECKERS ONLY. AREAS ARE NOT TO BE USED FOR ESTIMATING PURPOSED BY THE CONTRACTOR. THESE AREAS WILL NOT MATCH AREAS CALCULATED IN ACCORDANCE WITH STATE

9,500 S.F.

960 S.F.

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- PRIOR TO ANY UNDERGROUND SITE WORK, VERIFY LOCATION OF ALL EXISTING UTILITIES WITH UNDERGROUND SERVICE ALERT (U.S.A.)

1100 - KEYNOTES

1130 (E) DRINKING FOUNTAIN TO BE REMAIN, PER DSA A#03-115433. SEE DETAIL 2/1130.

1145 (É) GALVANIZED GUARD RAILS TO REMAIN. DSA APPL. No. 03-115433 - CERTIFIED

LEGEND

TO PHYSICAL BARRIERS

FIRE DEPARTMENT ACCESS. WIDTH 20'-0". OTHER

ACCESSIBLE PATH OF TRAVEL AS INDICATED ON

PLAN IS A BARRIER-FREE ACCESS ROUTE AT LEAST 48" WIDE, WITHOUT ANY ABRUPT VERTICAL CHANGES EXCEEDING 1/2" AT 1:2 MAX. SLOPE, EXCEPT LEVEL CHANGES THAT DO NOT EXCEED 2% AND SLOPES IN THE DIRECTION OF TRAVEL SHALL NOT EXCEED 5%. "PASSING SPACES" AT LEAST 60"x60" ARE LOCATED NOT MORE THAN 200' APART. PART OF ACCESSIBLE PATH OF TRAVEL WITH CONTINUOUS GRADIENTS

HAVE 60' LEVEL AREAS NOT MORE THAN 400' APART.

SURFACE AND PROJECTING GREATER THAN 4" FROM WALL SURFACES BETWEEN 27" AND 80" ABOVE

THE ARCHITECT SHALL VERIFY THAT ALL BARRIERS

ON THE INDICATED PATH OF TRAVEL HAVE BEE

REMOVED. GATES IN PATH OF TRAVEL SHALL COMPLY WITH EXIT DOOR REQUIREMENTS PER CBC

CONSTRUCTED AS PART OF DSA APPLICATION

AC PAVING. SEE CIVIL DRAWINGS FOR ADDITIONAL

P.O.T. SHALL BE FREE OF OBSTRUCTIONS

WALKING SURFACE, CBC1133B.8.6

ACCESSIBLE BUILDING ENTRANCE

NUMBER AND CONTRACT

NEW RELOCATABLE BUILDING TO BE

SECTION 11B-404.1

OVERHANGING WITHIN 80" ABOVE WALKING

FIRE HOSE PATH. LENGTH AS SPECIFIED

INDICATED DIMENSIONS SHOWN ARE CLEAR WIDTHS

1116 (E) UTILITY BOXES/METER TO REMAIN.

1137 DRY WELL, SEE DETAIL 05/A8000. 1138 AREA DRAIN PER CIVIL DRAWINGS.

— — PROPERTY LINE

1134 CHAIN LINK FENCE, SEE DETAIL 10/A8000.

1136 HVAC UNIT PER RELOCATABLE MFR. DRAWINGS.

1135 CHAIN LINK GATE, PER DETAIL 09/A8000. SIZE AS SPECIFIED.

CONTRACTOR SHALL REPLACE IN KIND ANY EXISTING IMPROVEMENTS DAMAGED BY DEMOLITION OR CONSTRUCTION ACTIVITIES.

PRIME CONSULTANT



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ARCHITECTURE PLANNING

San Luis Obispo 4119 Broad Street, Suite 210


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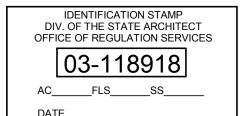
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NO.	DATE	APPRD.	DESCRIPTION
	08-30-2019		DSA CCD #1
	09-12-2019		Clarification to CCD #1

CONSULTANT



AGENCY INFORMATION:

AGENCY TRACKING NO. 63321-289 FILE NO. 15-6

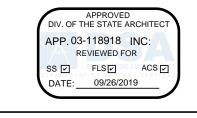

BAKERSFIELD CITY SCHOOL



BESSIE OWENS INTERMEDIATE -RELOCATBLES R6 & R7


815 EUREKA ST. BAKERSFIELD CA, 93305

PROJECT NO:	109668
DRAWN BY:	rRr
CHK'D BY:	RM
ISSUE DATE:	05/24/2018
SHEET TITLE	

PARTIAL SITE PLAN

SHEET NUMBER

CCD #1

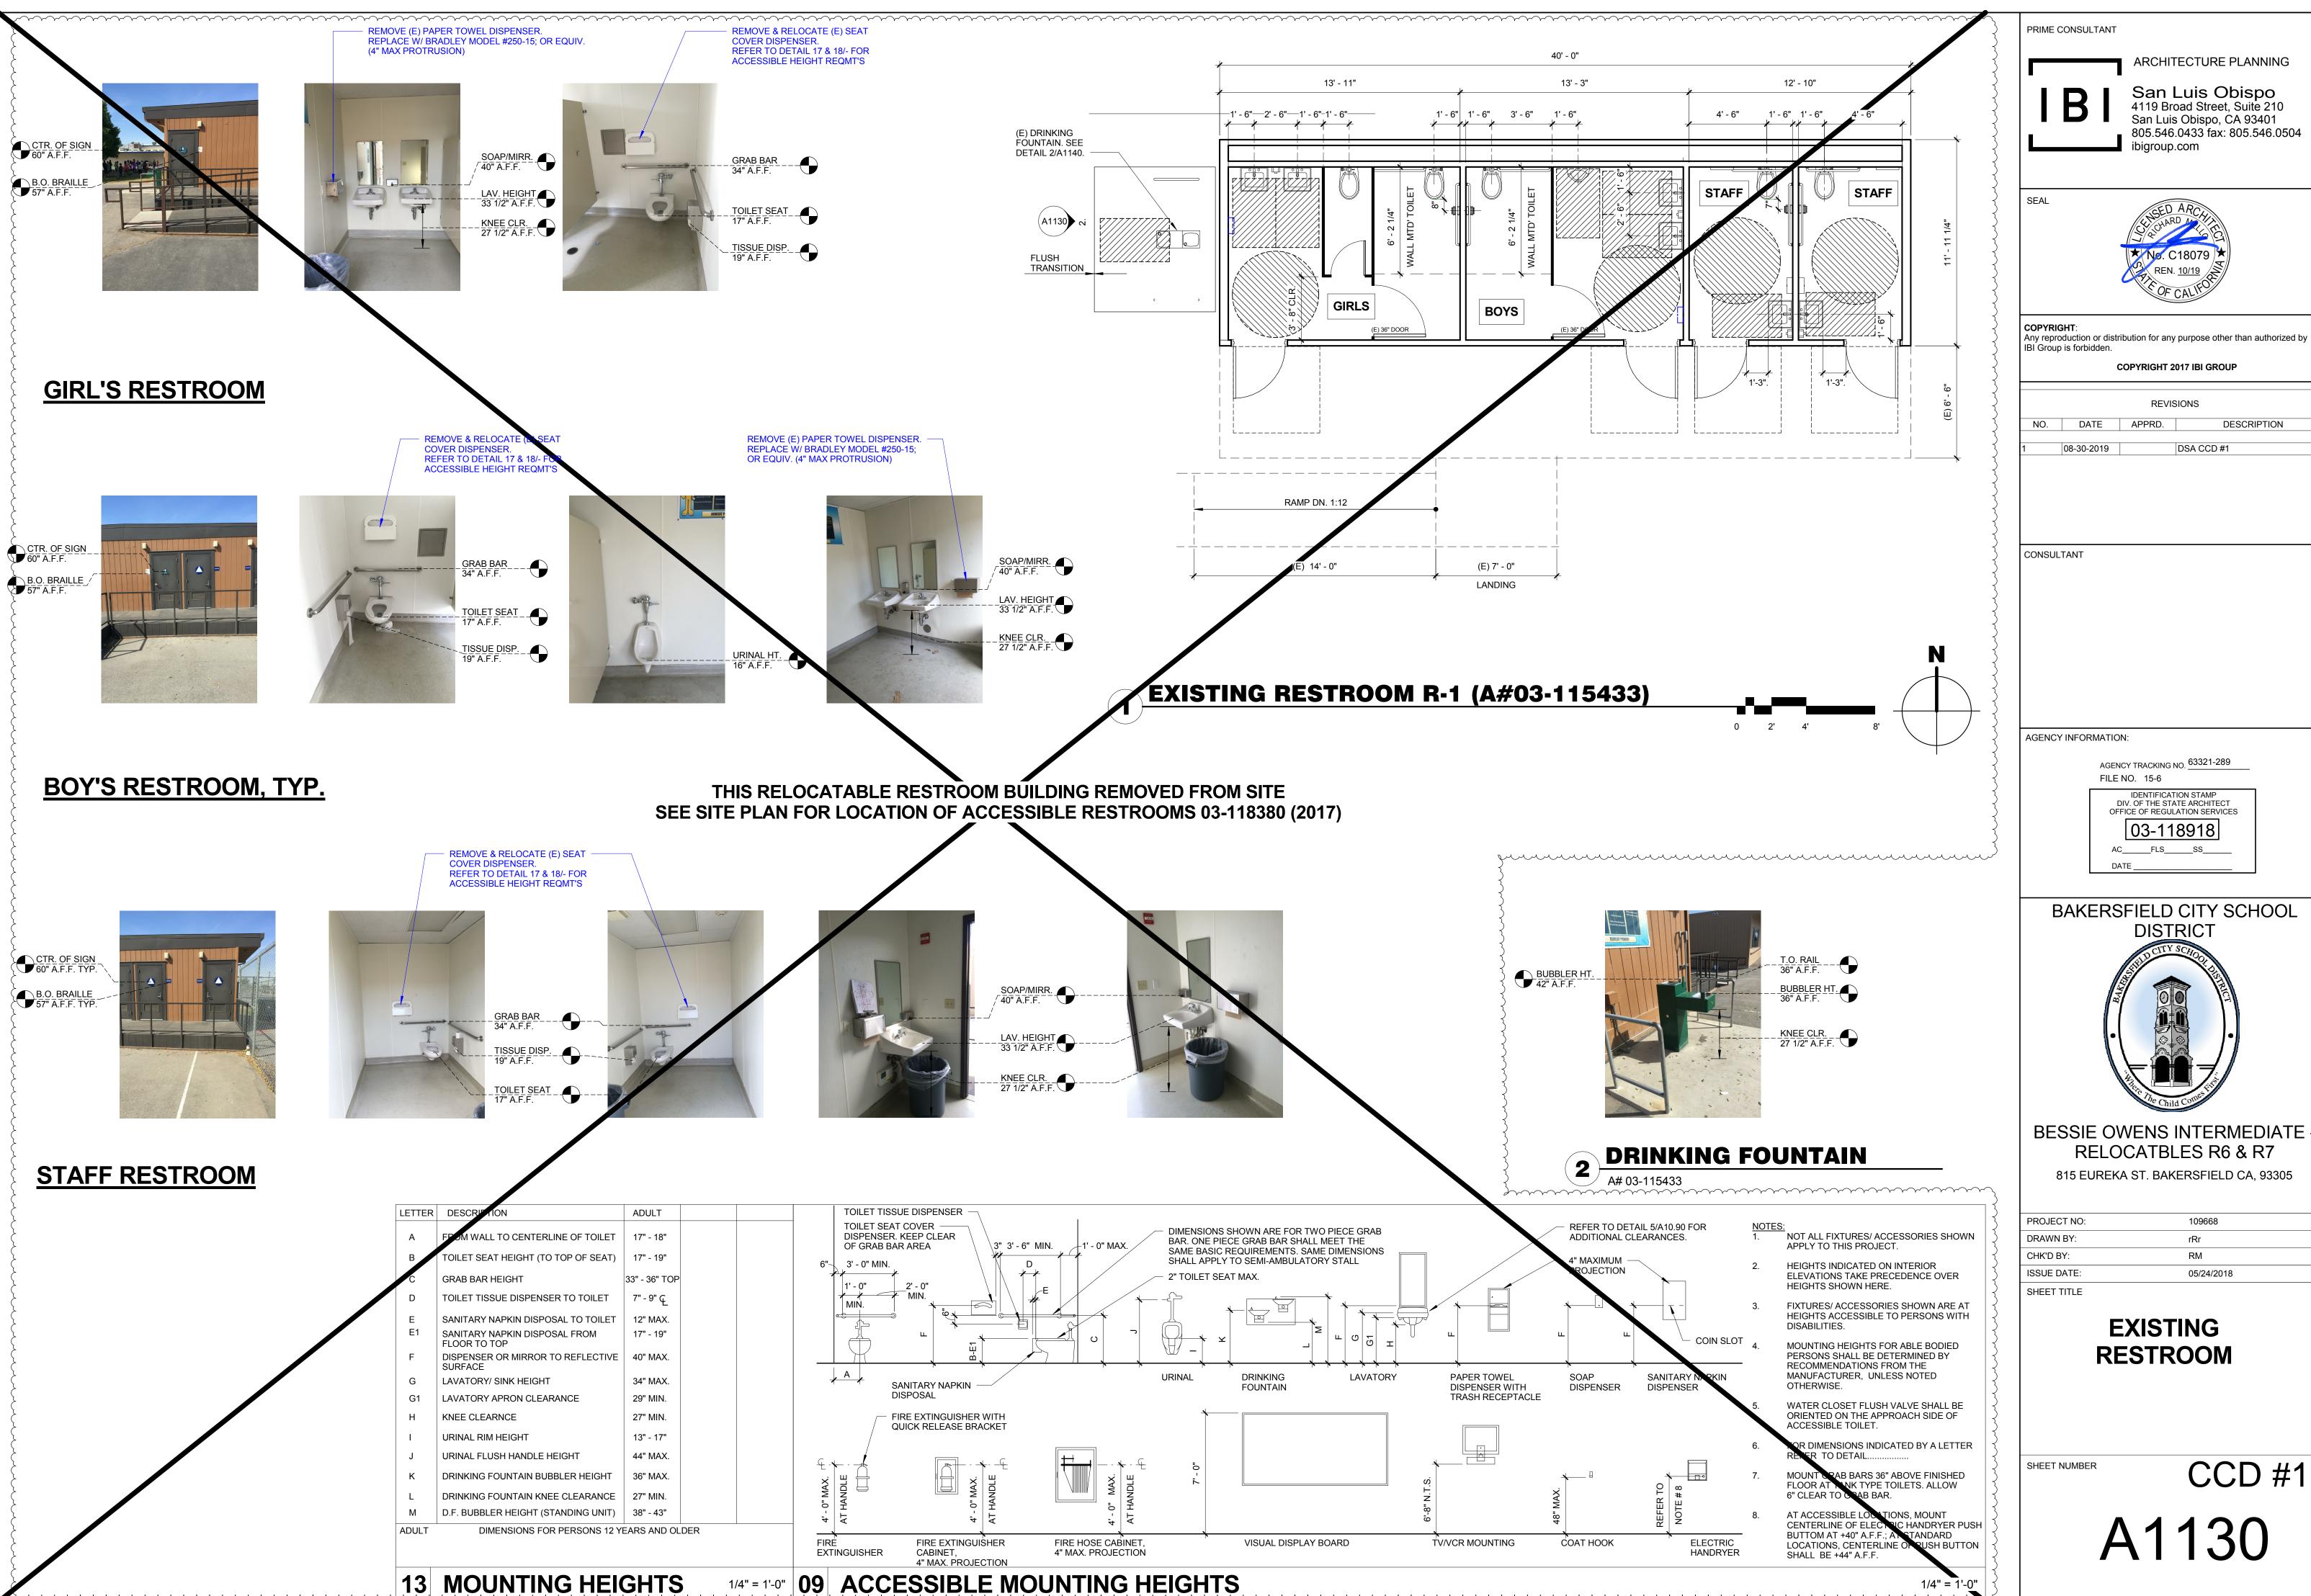

San Luis Obispo 4119 Broad Street, Suite 210 San Luis Obispo, CA 93401 805.546.0433 fax: 805.546.0504


DESCRIPTION




BESSIE OWENS INTERMEDIATE -RELOCATBLES R6 & R7

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SHEET TITI E	

CCD #1

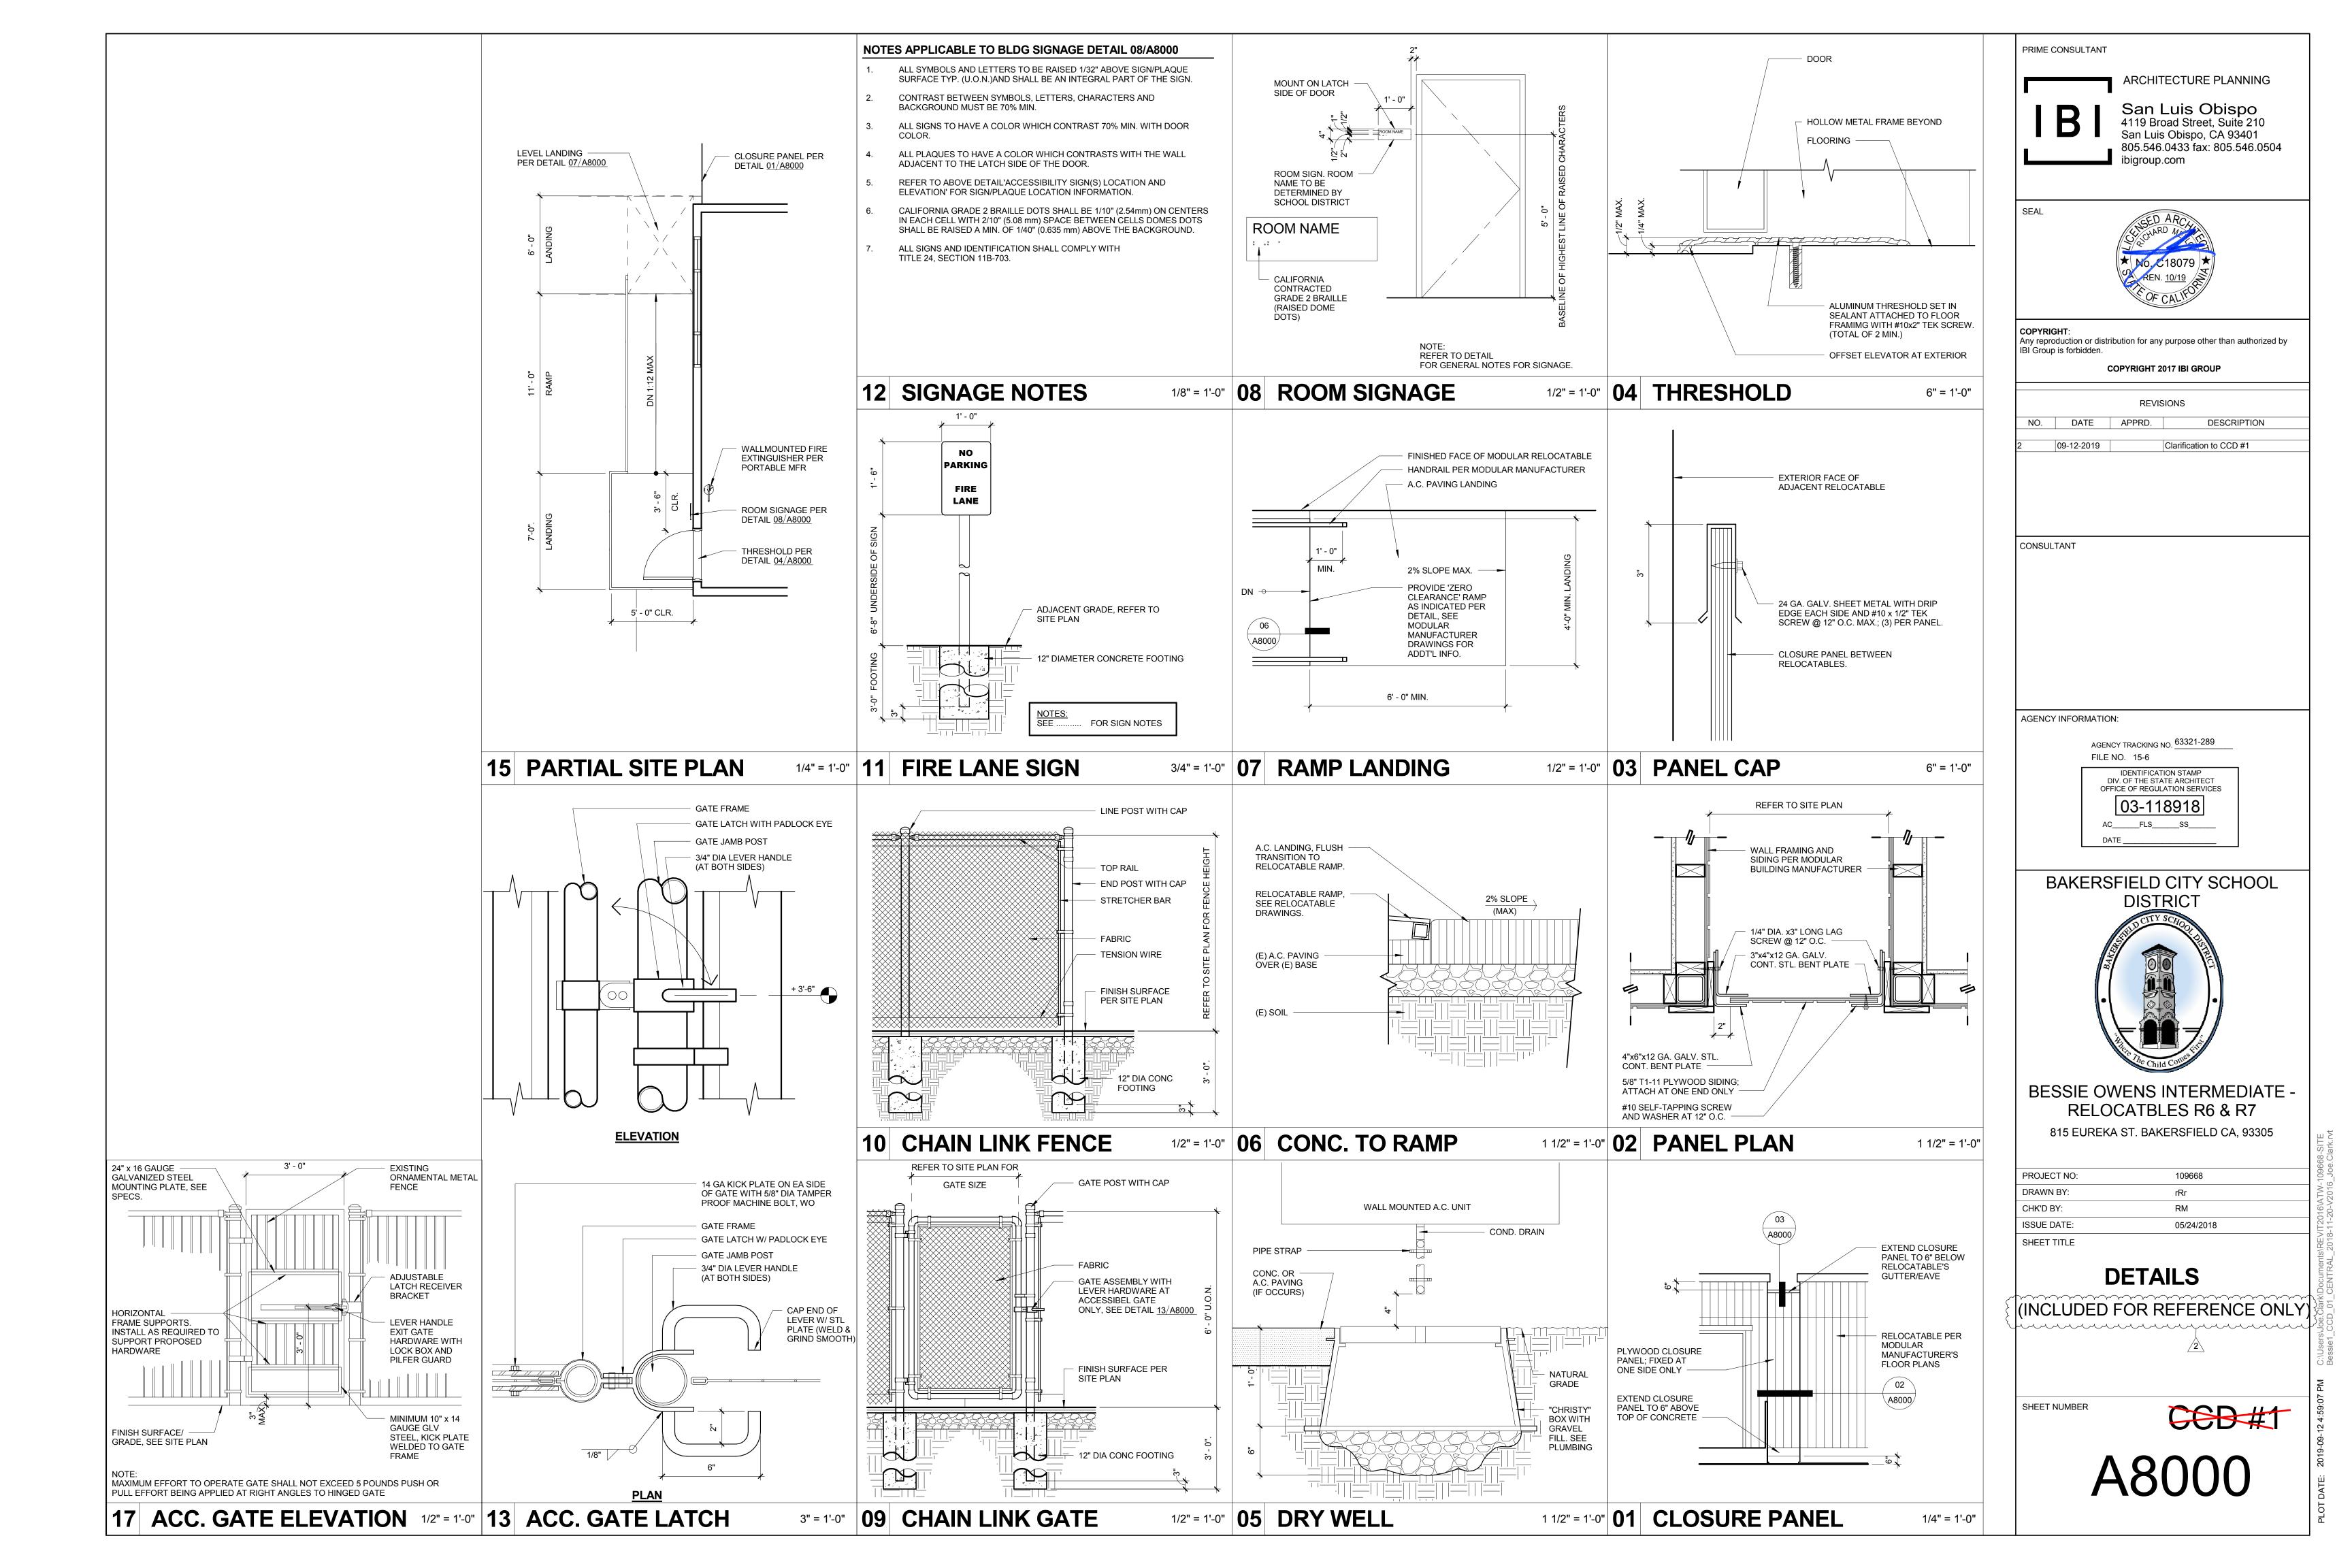

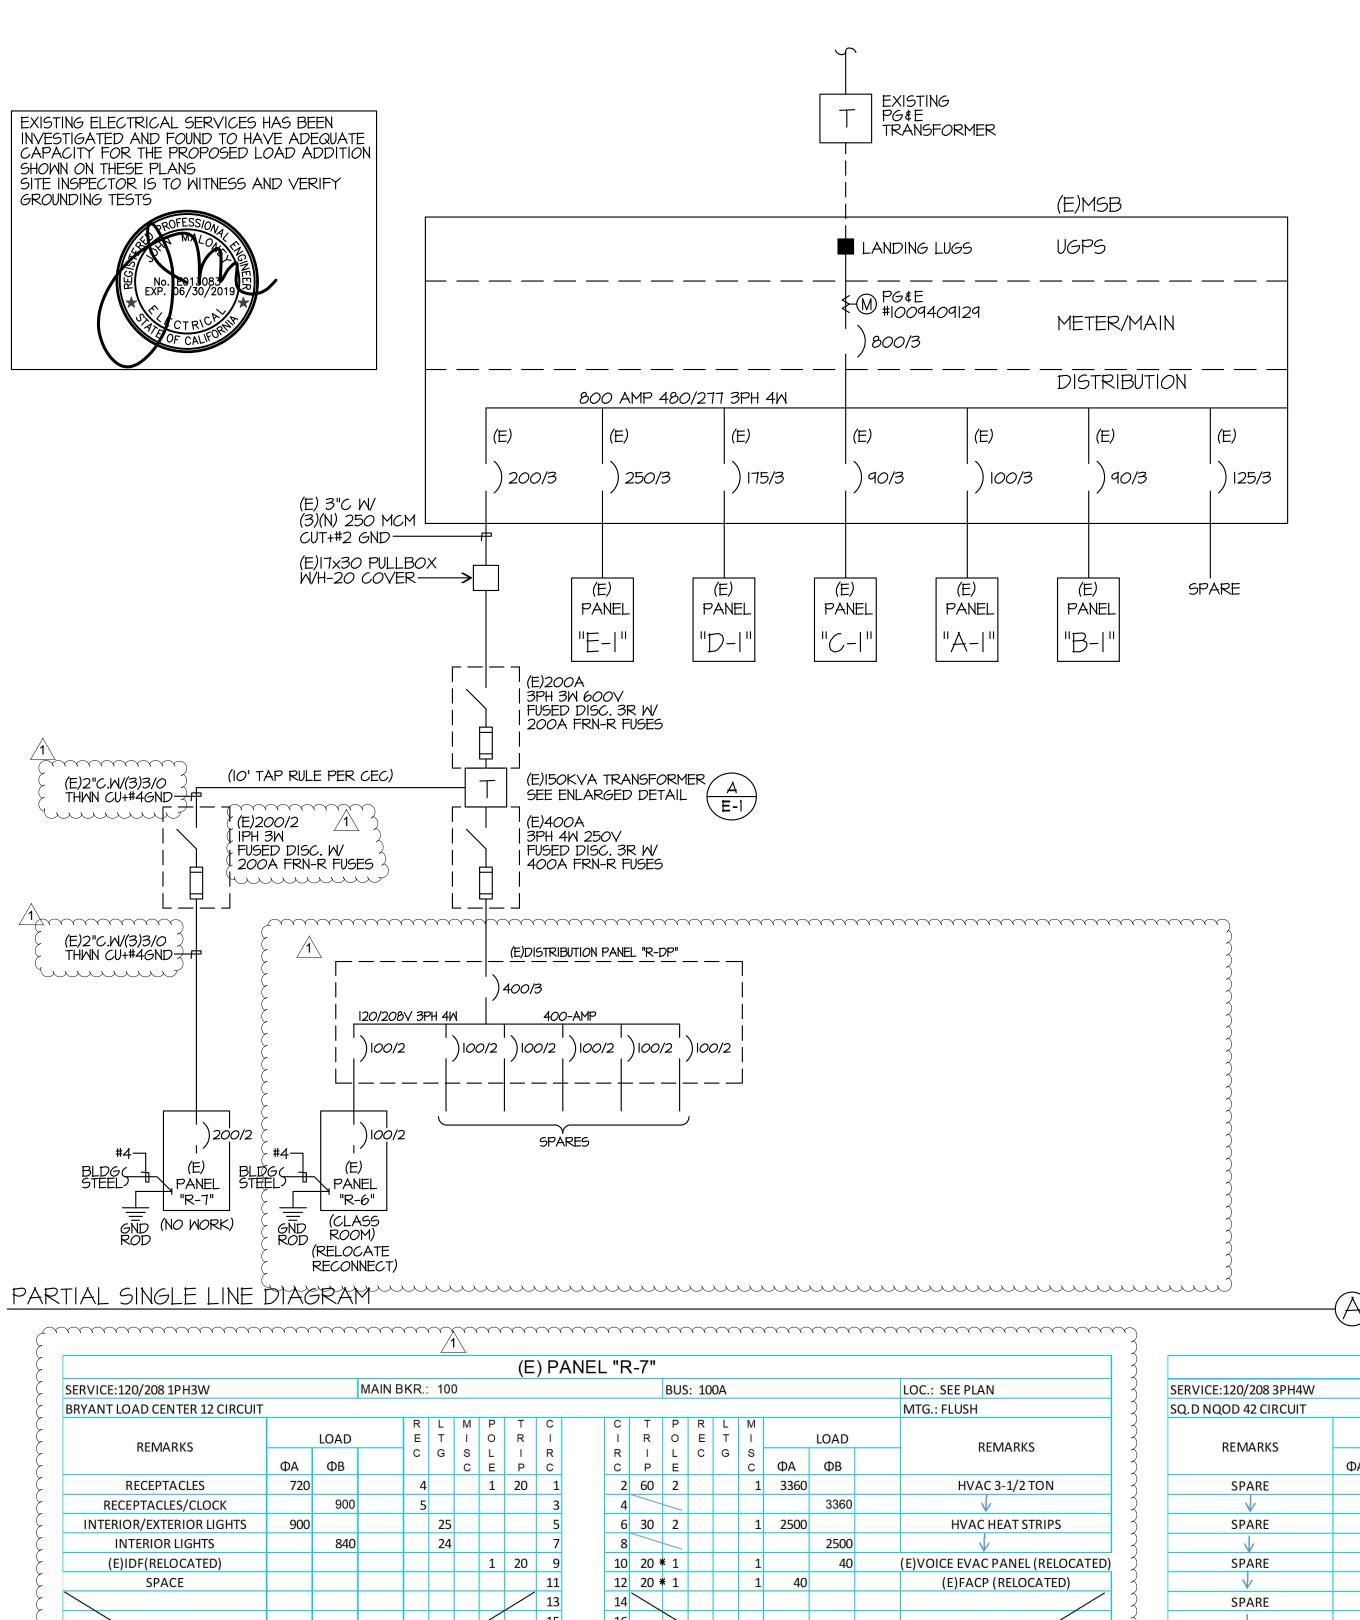

18

20

3360 3400

MINIMUM BKR A.I.C. RATING= 10,000 AMPS SYM

720

TOTAL WATTS= 15160

AMPS= 72.884

900

* PR40VIDE RED HANDLE AND LOCK-ON DEVICE

ФА= 7520

GENERAL NOTES

- I. VISIT JOB SITE AND VERIFY EXISTING CONDITIONS PRIOR TO BID.
- 2. THE ELECTRICAL WORK SHALL BE INSTALLED IN ACCORDANCE WITH THE 2013 CALIFORNIA ELECTRICAL CODE AND ALL APPLICABLE LOCAL ORDINANCES.
 WHERE PLANS CALL FOR A HIGHER STANDARD THAN APPLICABLE CODES,
 THE PLANS SHALL GOVERN.
- 3. CONDUIT RUNS ARE SHOWN DIAGRAMMATICALLY. EXACT LOCATIONS SHALL BE DETERMINED IN THE FIELD TO SUIT FIELD CONDITIONS.
- 4. ALL ELECTRICAL EQUIPMENT SHALL BE LISTED BY A RECOGNIZED TEST LAB AND BEAR THAT LABEL OF APPROVAL.
- 5. CONTRACTOR SHALL FURNISH, INSTALL AND CONNECT ALL MATERIAL AND EQUIPMENT FOR THIS WORK UNLESS OTHERWISE NOTED.
- 6. ALL SPACES AS INDICATED ON PANELS OR SWITCHBOARDS SHALL BE COMPLETE WITH HARDWARE AND BUSSING FOR FUTURE BREAKER OR
- 7. GROUNDING AND BONDING SHALL BE PER CODE PLUS ANY ADDITIONAL PROVISIONS SPECIFIED OR SHOWN ON DRAWINGS.
- 8. ALL CONDUIT RUNS SHALL CONTAIN A CODE SIZED GREEN GROUND
- 9. ALL CONDUCTORS SHALL BE IN CONDUIT.
- 10. ALL CONDUCTORS SHALL BE COPPER WITH TYPE THHN/THWN INSULATION.
- PROVIDE 48 HOURS NOTIFICATION BEFORE COMMENCING ANY BACKHOE OR TRENCHING WORK.
 NO FIRE ALARM CABLE SHALL BE SPLICED IN FLUSH PULLBOXES. SPLICING

SHALL OCCUR IN BOXES ABOVE GRADE.

PERFORMANCE OF THE WORK OF THIS CONTRACT SHALL CONFORM TO THE REQUIREMENTS OF APPLICABLE GOVERNING CODES AND ORDINANCES INCLUDING THE FOLLOWING:

CODE REQUIREMENTS


- 2016 BUILDING STANDARDS ADMINISTRATIVE CODE, PART 1, TITLE 24, C.C.R.
- 2016 CALIFORNIA BUILDING CODE, PART 2, TITLE 24 C.C.R. (2012 IBC, VOLUMES 1-3 WITH CALIFORNIA AMENDMENTS)
- 2016 CALIFORNIA ELECTRICAL CODE, PART 3, TITLE 24 C.C.R. (2011 N.E.C. WITH CALIFORNIA AMENDMENTS)
- 2016 CALIFORNIA MECHANICAL CODE, PART 4, TITLE 24 C.C.R (2012 U.M.C. WITH CALIFORNIA AMENDMENTS)
- 2016 CALIFORNIA PLUMBING CODE, PART 5, TITLE 24 C.C.R. (2012 U.P.C. WITH CALIFORNIA AMENDMENTS)
- 2016 CALIFORNIA ENERGY CODE, PART 6, TITLE 24 C.C.R
- 2016 CALIFORNIA FIRE CODE, PART 9, TITLE 24 C.C.R. (2012 I.F.C. WITH CALIFORNIA AMENDMENTS)
- 2016 CALIFORNIA REFERENCED STANDARDS, PART 12, TITLE 24 C.C.R. TITLE 19 C.C.R. PUBLIC SAFETY, STATE FIRE MARSHAL REGULATIONS.

NFPA 13 AUTOMATIC SPRINKLER SYSTEM -----2016 EDITION

NFPA 14 STANDPIPE SYSTEM -----2015 EDITION

NFPA 24 PRIVATE SERVICE MAINS -----2015 EDITION

NFPA 72 NATIONAL FIRE ALARM CODE -----2016 EDITION (NOTE SEE UL STANDARDS 1971 FOR ("VISUAL DEVICES")

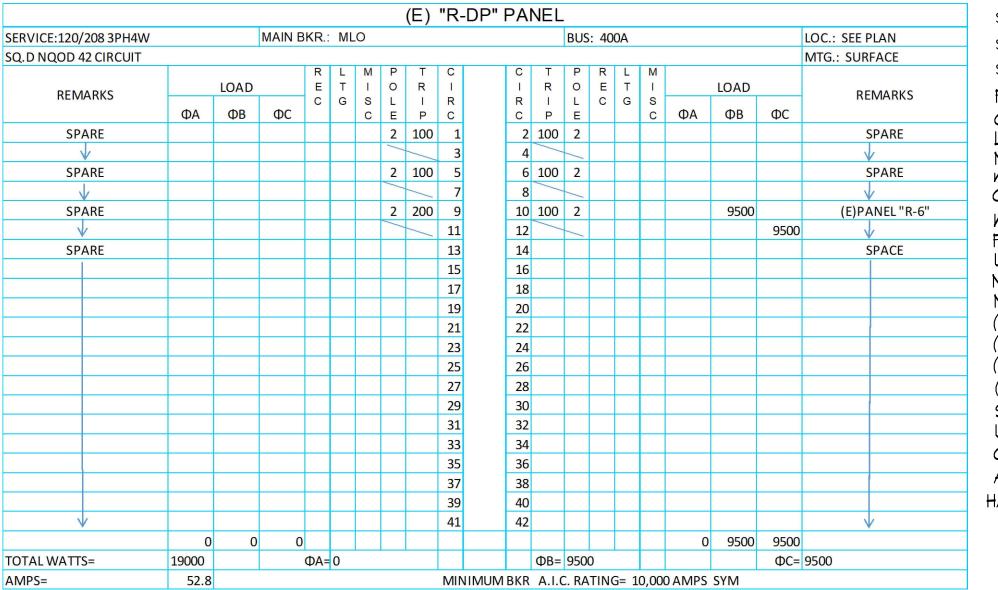

<u>SYMBOLS</u>

CONDUIT EXISTING

CONDUIT CONCEALED IN WALL OR CEILING

CONDUIT CONCEALED UNDER FLOOR OR BELOW GRADE

CONDUIT STUBBED OUT AND CAPPED

*co*nduit turned up *co*nduit turned d*o*wn

CONDUIT TURNED DOWN

HATCH MARKS INDICATE NO. OF #12 WIRES IN CODE SIZED

CONDUIT (3) MAX. IN 1/2" C., (5) MAX. IN 3/4" C.,

HOME RUN: LETTER INDICATES PANEL, NUMBER(S) INDICATES CIRCUIT(S).

(3) MAX. IN 1"C., NO MARKS = 2 # | 2 |

SAWCUT GROUND CONNECTION

DISTRIBUTION SWITCHBOARD OR PANEL

PANEL, BRANCH CIRCUIT TYPE, SURFACE AND FLUSH SIGNAL TERMINAL CABINET, SURFACE & FLUSH

FLUORESCENT FIXTURE

 \bowtie

OUTLET DATA: BAR INDICATES WALL MOUNT, LETTER INDICATES SWITCH CONTROL, NO. INDICATES CIRCUIT.

SURFACE FIXTURE ON FLUSH OUTLET.

RECESSED FIXTURE WITH JUNCTION BOX FOR THRU WIRING

EXIT LIGHT WITH ARROWS AS SHOWN ON PLANS, WALL AND CEILING MOUNT.

LOW LEVEL EXIT SIGN, +6" AFF, +4" FROM DOOR JAMP

LIGHT FIXTURE DESIGNATION, LETTER INDICATES TYPE,

NO. INDICATES WATTAGE. SEE FIXTURE SCHEDULE.

MECHANICAL EQUIPMENT DESIGNATION. SEE MECHANICAL DRAWINGS. SPECIAL RECEPTACLE - SEE PLAN

METER
FLUSH FLOOR RECEPTAGLE
RECEPTAGLE, DUPLEX, 15A, 125V, NEMA 5-15R +18" UNO.

RECEPTACLE, DUPLEX, 15A, 125V, NEMA 5-15R +18" UND.

DUPLEX RECEPTACLE MTD. ABOVE BACKSPLASH

DUPLEX RECEPTACLE W/LOWER HALF SWITCHED

GROUND FAULT CIRCUIT INTERRUPTING RECEPTACLE

DOUBLE DUPLEX RECEPTACLE

CEILING RECEPTACLE

RECEPTACLE, DUPLEX, 20A, 125V, NEMA 5-20R +18" UNO.

JUNCTION BOX 4" SQUARE, I-1/2" DEEP U.N.O.

THERMOSTAT F.B.O. +48"

MOTOR, NO. INDICATES HORSEPOWER

CLOCK OUTLET +7'-6" U.N.O. DISCONNECT SWITCH, NON-FUSED

DISCONNECT SWITCH FUSED HORSEPOWER RATED OR SIZED AS

COMBINATION MAGNETIC STARTER WITH DISCONNECT SWITCH AND

MAGNETIC MOTOR STARTER W/OVERLOADS IN EACH PHASE

MAGNETIC MOTOR STARTER W/OVERLOADS IN EX DIMMER W/INTEGRAL "ON-OFF" SW.

PUSHBUTTAN

PHOTOCELL SMOKE DETECTOR

TELEPHONE/COMPUTER/DATA OUTLET, TWO GANG BOX W/I GANG COVERPLATE & GROMMETED OPENING +18" U.N.O.

APPROVED DIV. OF THE STATE ARCHITE

APP. 03-118918 INC:

DATE: 09/26/2019

REVIEWED FOR

SS P FLSP ACS P

CAPLE TV OUTLET +18" U.N.O.

MOTION SENSOR SPEAKER

EXISTING SWITCH

SINGLE PALE SWITCH

DAUBLE PALE SWITCH

QUIET TOOGLE TYPE RATED AT

100/2TTV AC. +42" UNO.

THREE WAY SWITCH SWITCH W/PILOT LT.

SWITCH W/PILOT LT. __ MANUAL MOTOR STARTER FIRE ALARM CONTROL PANEL

FACP FIRE ALARM CONTROL PANEL

GFI GROUND FAULT CIRCUIT INTERRUPTING

LABOR SAVING TANDEM

LABOR SAVING TANDEM

MAIN LUGS ONLY

WITH

CONDUIT ONLY
WEATHERPROOF

FURNISHED BY OTHERS, INSTALL & CONNECT UNLESS NOTED OTHERWISE

NATIONAL ELECTRICAL CODE
NOT IN CONTRACT

EXISTING

NEW

REMOVE

RELOCATE

SURFACE MOUNT

SURFACE MOUNT UNDERGROUND COLD WATER PIPE

> ABOVE FINISHED FILOOR HEATING AND AIR CONDITIONING RATED CIRCUIT BREAKER

HEATING AND AIR CONDITIONING RATED CIRCUIT PREARER

NIGHT LIGHT

NOTE: NOT ALL SYMBOLS SHOWN ARE USED ON THIS PROJECT.

NOTE: SEE BUILDING SPECIFIC SYMBOL LIST FOR R-7 DETAIL (A) SHEET E-0.3 PRIME CONSULTANT

ARCHITECTURE PLANNING

B San Luis Obispo 4119 Broad Street, Suite 210 San Luis Obispo, CA 93401 805.546.0433 fax:805.546.0504

SEAL




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REVISIONS					
NO.	DATE	APPRD.	DESCRIPTION		
1	08-30-2019		DSA CCD #1		
NO. 1		APPRD.			

CONSULTAN



AGENCY INFORMATION:

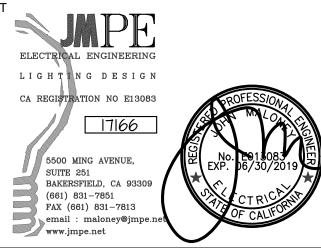AGENCY TRACKING NO. <u>63321-241</u> FILE NO. 15-6



BAKERSFIELD CITY SCHOOL



BESSIE OWENS
INTERMEDIATE 815 EUREKA ST. BAKERSFIELD CA, 93305

 OPSC or OSHPD PROJ. NO:

 PROJECT NO:
 109668

 DRAWN BY:
 AC

 CHK'D BY:
 WR

 ISSUE DATE:
 03/27/2018

 SHEET TITLE

SYMBOLS, CODES, AND NOTES


SHEET NUMBER

CCD #1


E-0.0

E:\2017 DWGS\17166\17166 E-0.0.dwg, 8/27/2018 3:11:27 PM, And

PLOT DATE: 5/2/2017

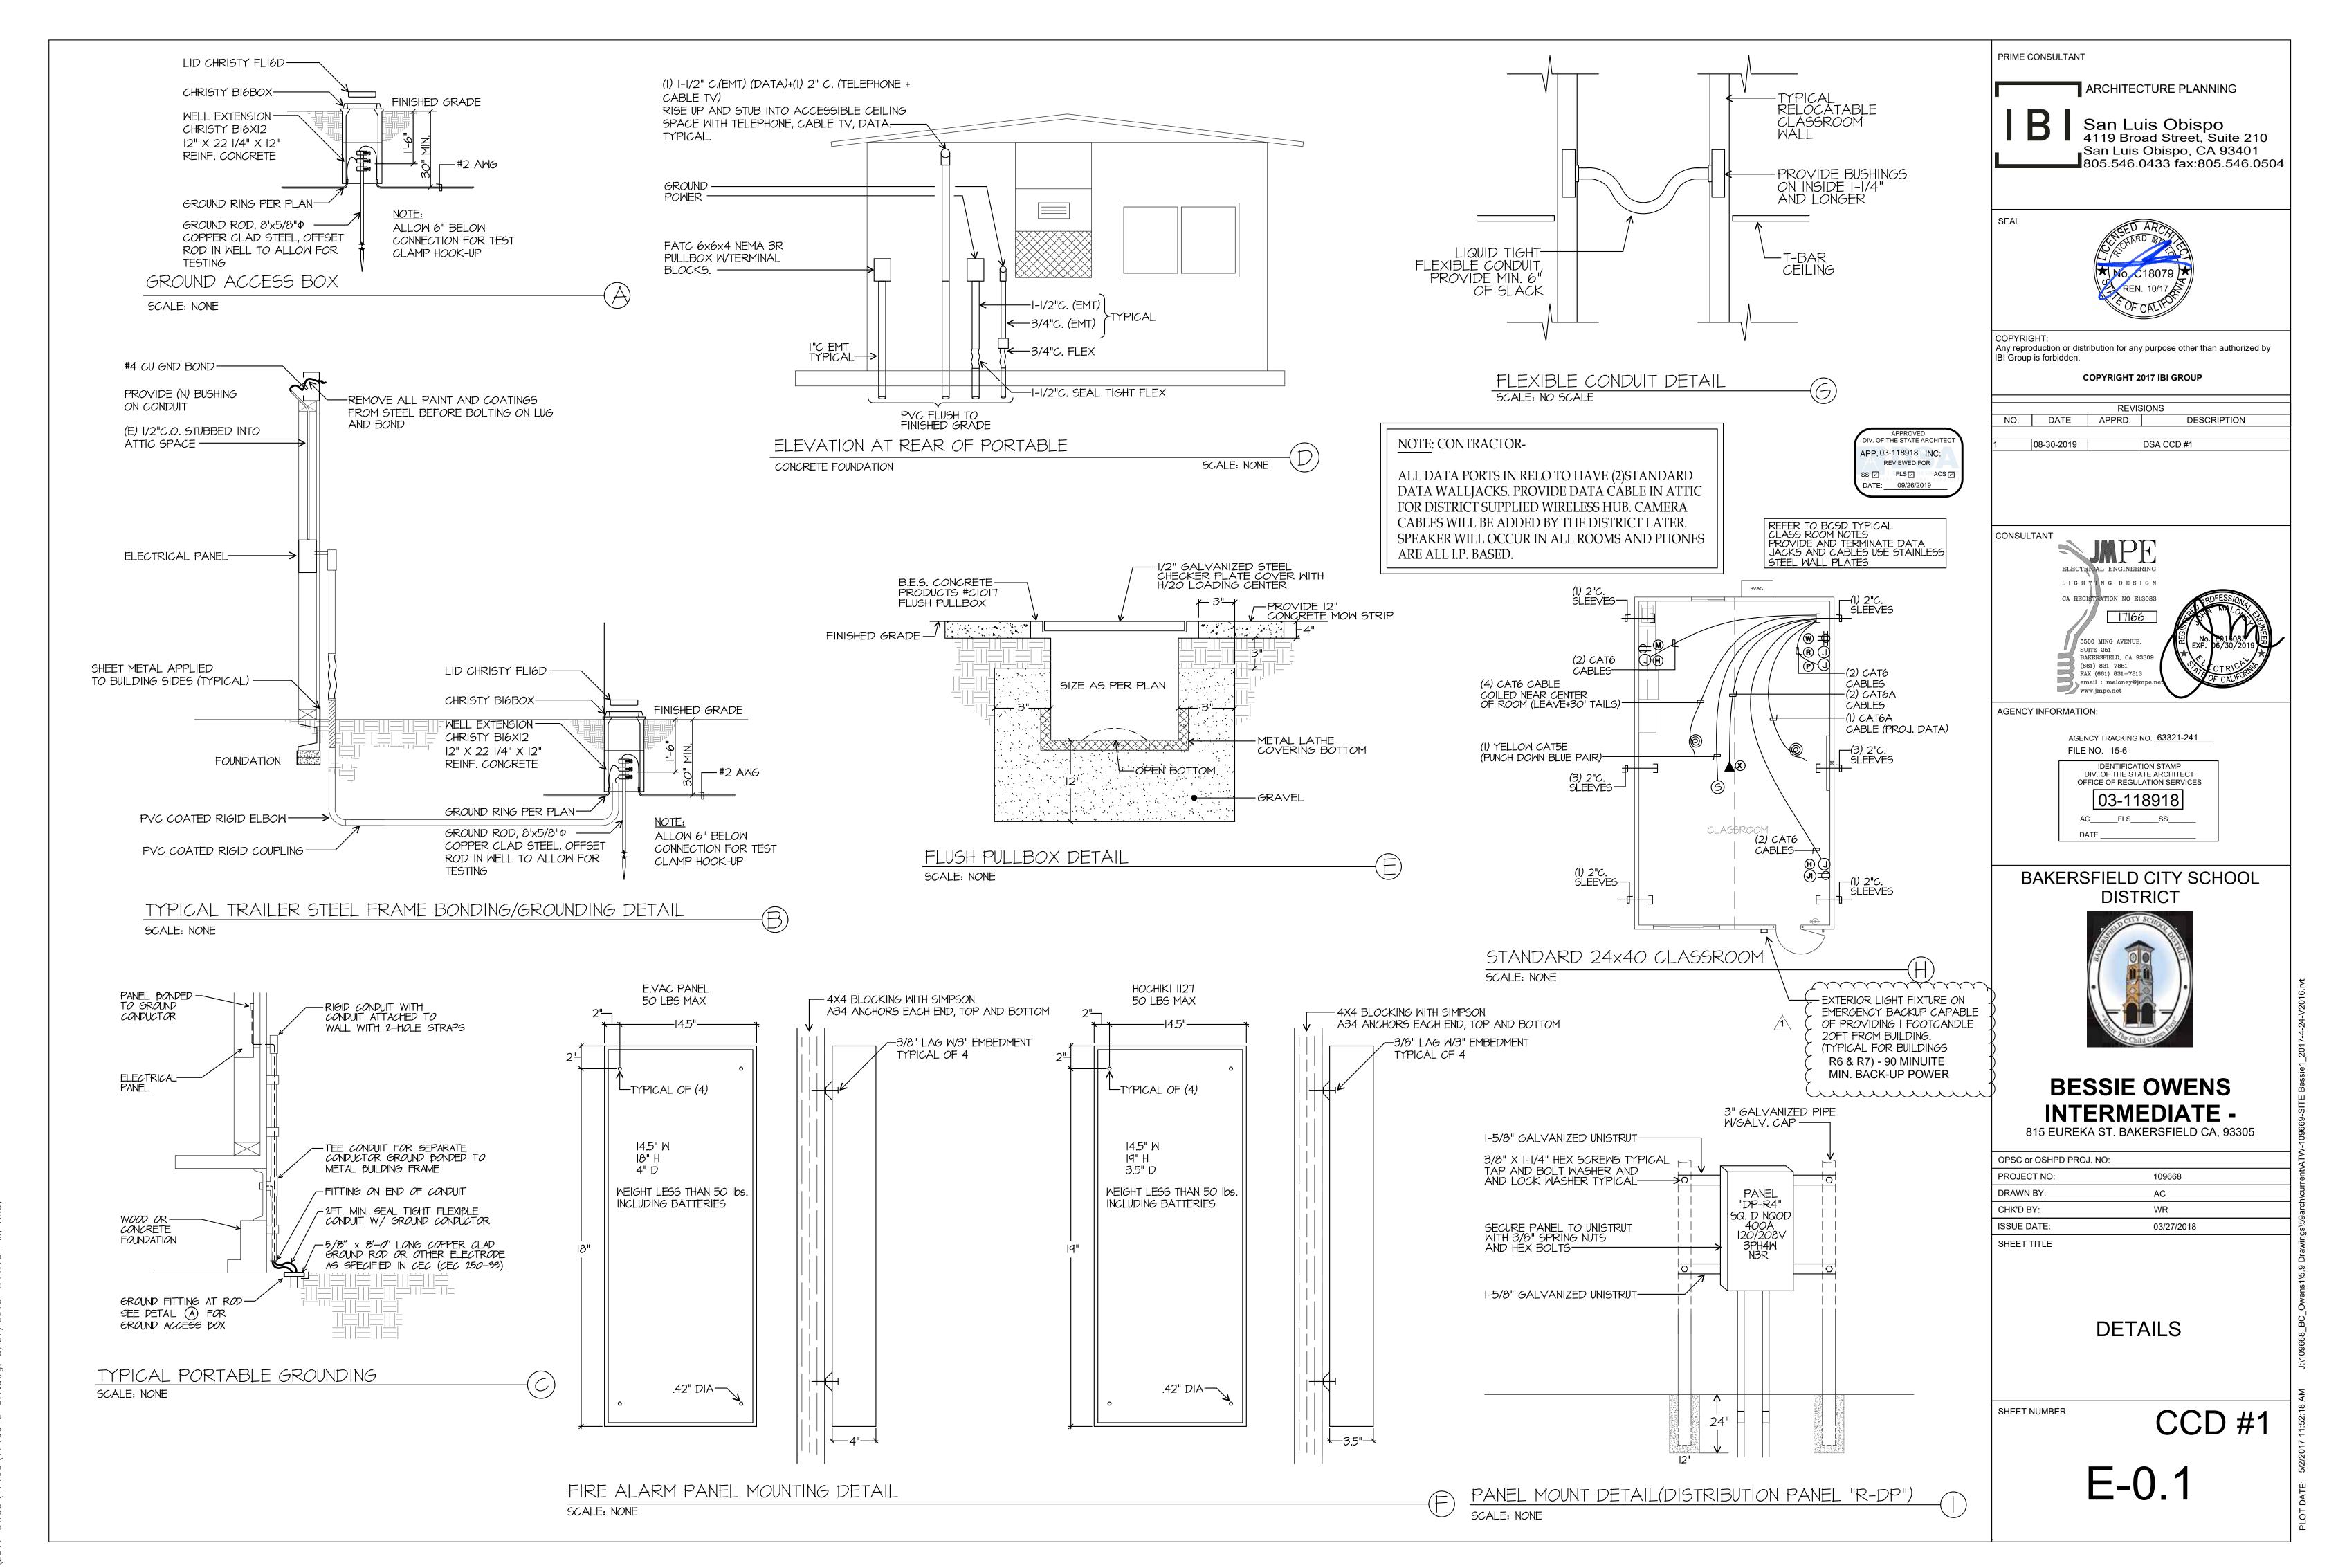

F:\2017 DWGS\17166\17166 F-0.1.dwg. 8/27/2018 4:44:15 PM. Ar

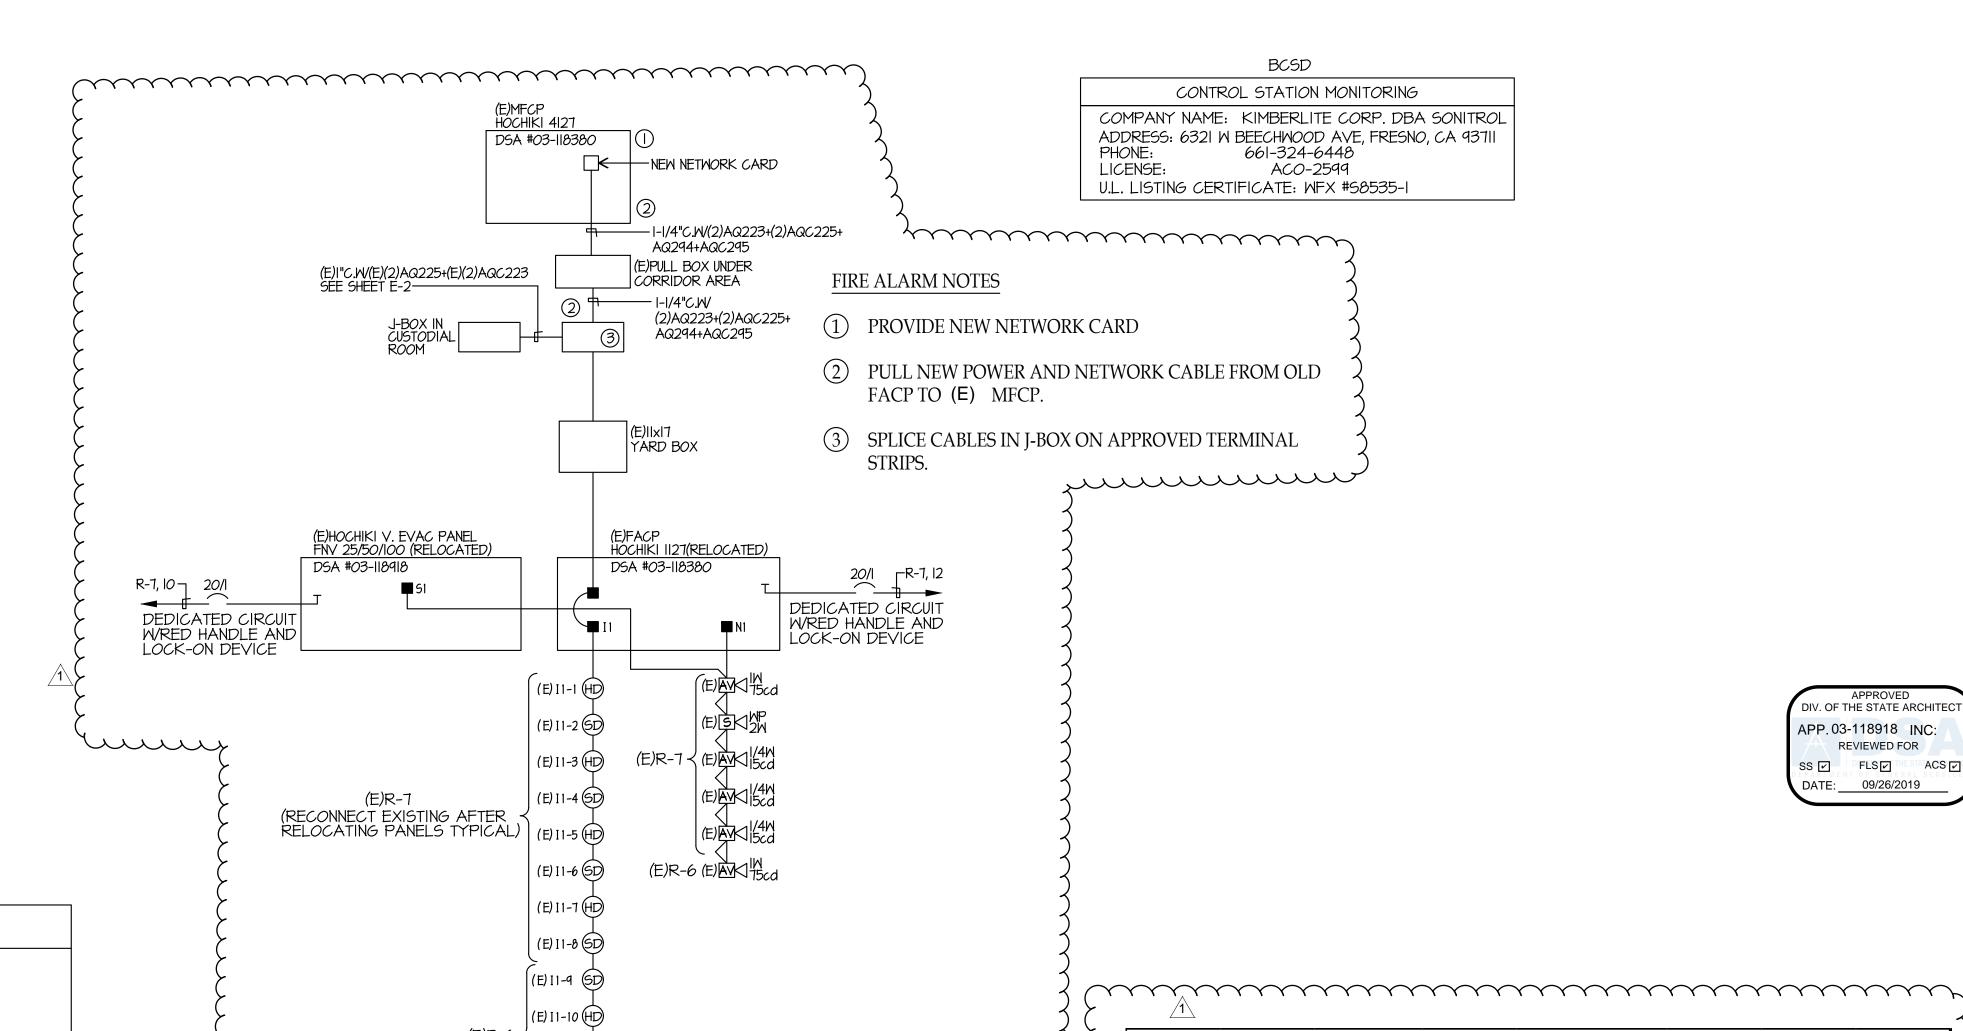

<u> </u>	FI	RE ALARM SYMBOL L	IST MATRIX	
SYMBOL	DEVICE	MFR & CAT#	REMARKS	CSFM LISTING
	(E) FACP	HOCHIKI 1127	EXISTING	7165-0410:0180
DVC	(E)VOICE PANEL	HOCHIKI EVAX-50	SURFACE MOUNT 7Ah	6911-0410:0176
SD	SMOKE DETECTOR	HOCHIKI ALN-V	PROVIDE BASE B210 LP ON 4"SQ. DEEP BOX	7272-0410:0204
HD	EXISTING HEAT DETECTOR (IN ATTIC SPACE)	HOCHIKI ATJ-EA	PROVIDE BASE B210 LP ON 4"SQ. DEEP BOX 190 DEGREE	7270-0410:0203
AV	SPEAKER STROBE	HOCHIKI HSSPK24WLPR	PROVIDE DEEP SQ. J-BOX	7320-0410:0195
S WP	SPEAKER STROBE	HOCHIKI HSSPKCPLW	PROVIDE MWBB BACKBOX	7320-0410:0194
E.O.L	END OF LINE RESISTOR			
	FLP CABLE	WEST PENN 975		7161-0859:0101
	FLP CABLE	WEST PENN 998		7161-0859:0101

WEST PENN AQ294

WEST PENN AQC 294

WEST PENN AQ223

WEST PENN AQ225

FLP CABLE

FLP CABLE

DEVICE NUMBERING LEGEND

DEVICE SYMBOL
DEVICE REFERENCE NUMBER

CANDELA SETTING

—CIRCUIT NUMBER —NOTIFICATION

- DEVICE SYMBOL - DEVICE REFERENCE NUMBER

7161-0859:0101

7161-0859:0101

DEVICE ADDRESS:

SCALE: NONE					
FIRE ALARM SEQUENCE OF OPERATION					
INITIATION RESPONSE	AREA SMOKE DETECTOR	AREA THERMAL DETECTOR	PULL STATION	AC POWER FAILURE	
ANNUNCIATE AT FIRE CONTROL ROOM ALARM AND TROUBLE	YES	YES	YES	YES (TROUBLE)	
ANNUNCIATE AT 24 HOUR ATTEND LOCATION ALARM AND TROUBLE	YES	YES	YES	YES (TROUBLE)	
ACTIVATE AUDIO VISUAL THROUGHOUT FLOOR OF ALARM	YES	YES	YES	YES	
CENTRAL STATION MONITORING	YES	YES	YES	YES	
ACTIVATE VOICE EVACUATION THROUGHOUT	YES	YES	YES	NO	

PARTIAL FIRE ALARM RISER DIAGRAM

FIRE WATCH, FIRE MARSHAL REQUIREMENTS;

REQUIREMENTS FOR DISABLING THE FIRE ALARM SYSTEM;

- As required by the 2016 CALIFORNIA FIRE CODE, Section 901.7, standby personnel or systems temporarily "OUT OF SERVICE". The local Fire Marshal is authorized to require the Contractor to provide standby personnel as set forth in these sections, until the system is restored to operation.
- Such individual shall be subject to the local Fire Marshal's order at all times when so employed and shall remain on duty during the time such places are open to the public or when such public activity is being conducted. Fire watch personnel shall be provided with at least one approved means for notification of the Fire Department.
- 3. Such individuals shall keep a diligent watch for fires and be able to take prompt and appropriate action in the event of a fire. Such individuals shall not be required or permitted, while on duty, to perform any other duties than these herein specified.

CIRCUIT	2x	LENGTH x	AMPS	x RES	ISTANC	$E[\mathbf{x}] = V$	OLTS V	OLTAG	E DROP
N1	2	650	0.5	14	0.00	205	1.370	5.71	%
EVISTING VO	NCE DANEL I	BATTERY CALCU	II ATION	E)/AY 50		•	•	·	
EXISTING VO	ICE PANEL I	BATTERT CALCO	LATION -	EVAX-50		SUPER	RVISORY		ALARM
Е	QUIPMENT I	DESCRIPTION		QUAN	ПТҮ		JRRENT		JRRENT
							PERES)		PERES)
			_	EXISTING	NEW	•	SUB-TOTAL		SUB-TOTAI
EVAX-50				1	0	0.13	0.13	1	1 10 10
1/4 Watt Spea	ker			3	0	0	0	0.017	0.05
1/2 Watt Speak				0	0	0	0	0.034	
1 Watt Speake				2	0	0	0	0.068	0.13
2 Watt Speak				1	0	0	0	0.132	0.13
SUB TOTAL A	MPERES						AMPS		AMPS
ALIS = 2 = 2		170				x 24 HOUF		X 0.25 HOL	
SUB TOTAL A	MPERE-HOU	JRS				3.12	A.H.	0.32975	A.H.
and the same of th		RE-HOURS FOR D				Ē		3.44975	A.H.
DATTE DV NO	ALLINIE AD DE	SCHARGE CHAR	ACTERIST	IC FACTO	R				x 1.2
TOTAL MINIM	UM AMPERE	HOURS REQUIR						4.1397	A.H.
	UM AMPERE	HOURS REQUIR						4.1397 7.00	A.H. A.H.
TOTAL MINIM PROVIDED BA	UM AMPERE ATTERY CAF	HOURS REQUIR	RED		27 FACP	QUIDE		7.00	A.H.
TOTAL MINIM PROVIDED BA EXISTING FIR FACP	UM AMPERE ATTERY CAF	HOURS REQUIR	RED	OCHIKI 11			RVISORY	7.00	A.H.
TOTAL MINIM PROVIDED BA EXISTING FIR FACP	UM AMPERE ATTERY CAF	HOURS REQUIF	RED			Cl	JRRENT	7.00	A.H. ALARM JRRENT
TOTAL MINIM PROVIDED BA EXISTING FIR FACP	UM AMPERE ATTERY CAF	HOURS REQUIR	ATION- H	OCHIKI 11 QUAN	TITY	Cl (AM	JRRENT PERES)	7.00 Cl (AM	A.H. ALARM JRRENT PERES)
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TOTAL MINIM PROVIDED BA EXISTING FIR FACP E FIRE ALARM	UM AMPERE ATTERY CAF RE ALARM BA QUIPMENT I	HOURS REQUIRED ACITY ATTERY CALCUL DESCRIPTION	ATION- H	OCHIKI 11 QUAN	TITY NEW 0	(AM EACH 0.35	JRRENT PERES) SUB-TOTAL 0.35	7.00 CI (AM EACH 0.62	A.H. ALARM JRRENT PERES) SUB-TOTA 0.6
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TOTAL MINIM PROVIDED BA EXISTING FIR FACP FIRE ALARM DIGITAL ALAR SOM & MANU SMOKE DETE HEAT DETECT 1/4 Watt Speak	UM AMPERE ATTERY CAF RE ALARM BA EQUIPMENT DE PANEL RM COMMUN JAL PULL ECTOR TOR ker Ler	HOURS REQUIRED ACITY ATTERY CALCUL DESCRIPTION	ATION- H	OCHIKI 11 QUAN EXISTING 1 0 6 6	NEW O O O O O O O	(AM EACH 0.35 0.02 0.00022 0.00039 0.00055	URRENT PERES) SUB-TOTAL 0.35 0.02 0 0.00234 0.0033	7.00 (AM EACH 0.62 0.006 0.00054 0.00066 0.017 0.034	A.H. ALARM JRRENT PERES) SUB-TOTA 0.6 0.00 0.0032 0.0039
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EXISTING FIRE FACP FIRE ALARM INDIGITAL ALAR SOM & MANUSMOKE DETECTAL Watt Speaker 1 Watt Speaker 2 Watt Speaker 2 Watt Speaker 1 SUB TOTAL A	UM AMPERE ATTERY CAF RE ALARM BA EQUIPMENT DE PANEL RM COMMUN JAL PULL ECTOR TOR ker er er er MPERES	HOURS REQUIRED ACITY ATTERY CALCULATION ICATOR JRS	ATION- H	OCHIKI 11 QUAN EXISTING 1 0 6 6 3 0 2 0	NEW O O O O O O O O O	CI (AM EACH 0.35 0.002 0.00039 0.00055 0 0 0 0 0 0.37564 x 24 HOUF 9.01536	URRENT PERES) SUB-TOTAL 0.35 0.02 0 0.00234 0.0033 0 0 0 AMPS	7.00 (AM EACH 0.62 0.006 0.00054 0.00066 0.017 0.034 0.068 0.132 0.8342 X 0.25 HOU 0.20855	A.H. ALARM JRRENT PERES) SUB-TOTA 0.6 0.00 0.0032 0.0039 0.013 AMPS JRS A.H.
EXISTING FIRE FACP FIRE ALARM DIGITAL ALAR SOM & MANU SMOKE DETE HEAT DETECT 1/4 Watt Speak 1 Watt Speak 2 Watt Speak 2 Watt Speak 5 Watt Speak 5 Watt Speak 6 SUB TOTAL A SUB TOTAL A	UM AMPERE ATTERY CAF RE ALARM BA EQUIPMENT D PANEL RM COMMUN JAL PULL ECTOR TOR Ker Ler Ler Ler Ler Ler Ler Ler Ler Ler L	E HOURS REQUIRED ACITY ATTERY CALCULATION ICATOR JRS RE-HOURS FOR I	ATION- H	OCHIKI 11 QUAN EXISTING 1 0 6 6 7 0 2 0	NEW O O O O O O O O R MODULE	CI (AM EACH 0.35 0.002 0.00039 0.00055 0 0 0 0 0 0.37564 x 24 HOUF 9.01536	URRENT PERES) SUB-TOTAL 0.35 0.02 0 0.00234 0.0033 0 0 0 AMPS	7.00 (AM EACH 0.62 0.0054 0.00054 0.00066 0.017 0.034 0.068 0.132 0.8342 X 0.25 HOU 0.20855	A.H. ALARM JRRENT PERES) SUB-TOTA 0.6 0.00 0.0032 0.0039 0.013 AMPS JRS A.H. A.H.
EXISTING FIRE FACP FIRE ALARM I DIGITAL ALAR SOM & MANU SMOKE DETE HEAT DETECT 1/4 Watt Speak 1 Watt Speak 2 Watt Speak 2 Watt Speak SUB TOTAL A SUB TOTAL A TOTAL REQUI BATTERY NO	UM AMPERE ATTERY CAF RE ALARM BA QUIPMENT D PANEL RM COMMUN JAL PULL ECTOR TOR ker er er er er er IMPERES IMPERE-HOL IRED AMPER N-LINEAR DIS	HOURS REQUIRED ACITY ATTERY CALCULATION ICATOR JRS	ATION- H	OCHIKI 11 QUAN EXISTING 1 0 6 6 7 0 2 0	NEW O O O O O O O O R MODULE	CI (AM EACH 0.35 0.002 0.00039 0.00055 0 0 0 0 0 0.37564 x 24 HOUF 9.01536	URRENT PERES) SUB-TOTAL 0.35 0.02 0 0.00234 0.0033 0 0 0 AMPS	7.00 (AM EACH 0.62 0.0054 0.00054 0.00066 0.017 0.034 0.068 0.132 0.8342 X 0.25 HOU 0.20855	A.H. ALARM JRRENT PERES) SUB-TOTAI 0.6 0.00 0.0032 0.0039 0.05 AMPS JRS A.H.

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ARCHITECTURE PLANNING

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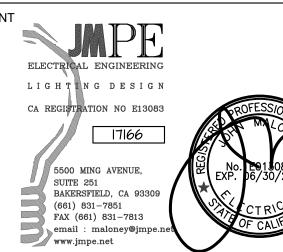
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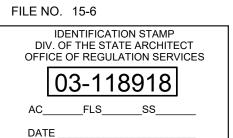
APP. 03-118918 INC:

DATE: 09/26/2019



AGENCY INFORMATION:

AGENCY TRACKING NO. 63321-241



BAKERSFIELD CITY SCHOOL



BESSIE OWENS INTERMEDIATE -815 EUREKA ST. BAKERSFIELD CA, 93305


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PROJECT NO:	109668
DRAWN BY:	AC
CHK'D BY:	WR
ISSUE DATE:	03/27/2018
SHEET TITLE	

FIRE ALARM RISER CALCULATIONS

SHEET NUMBER

CCD #1

E-0.2

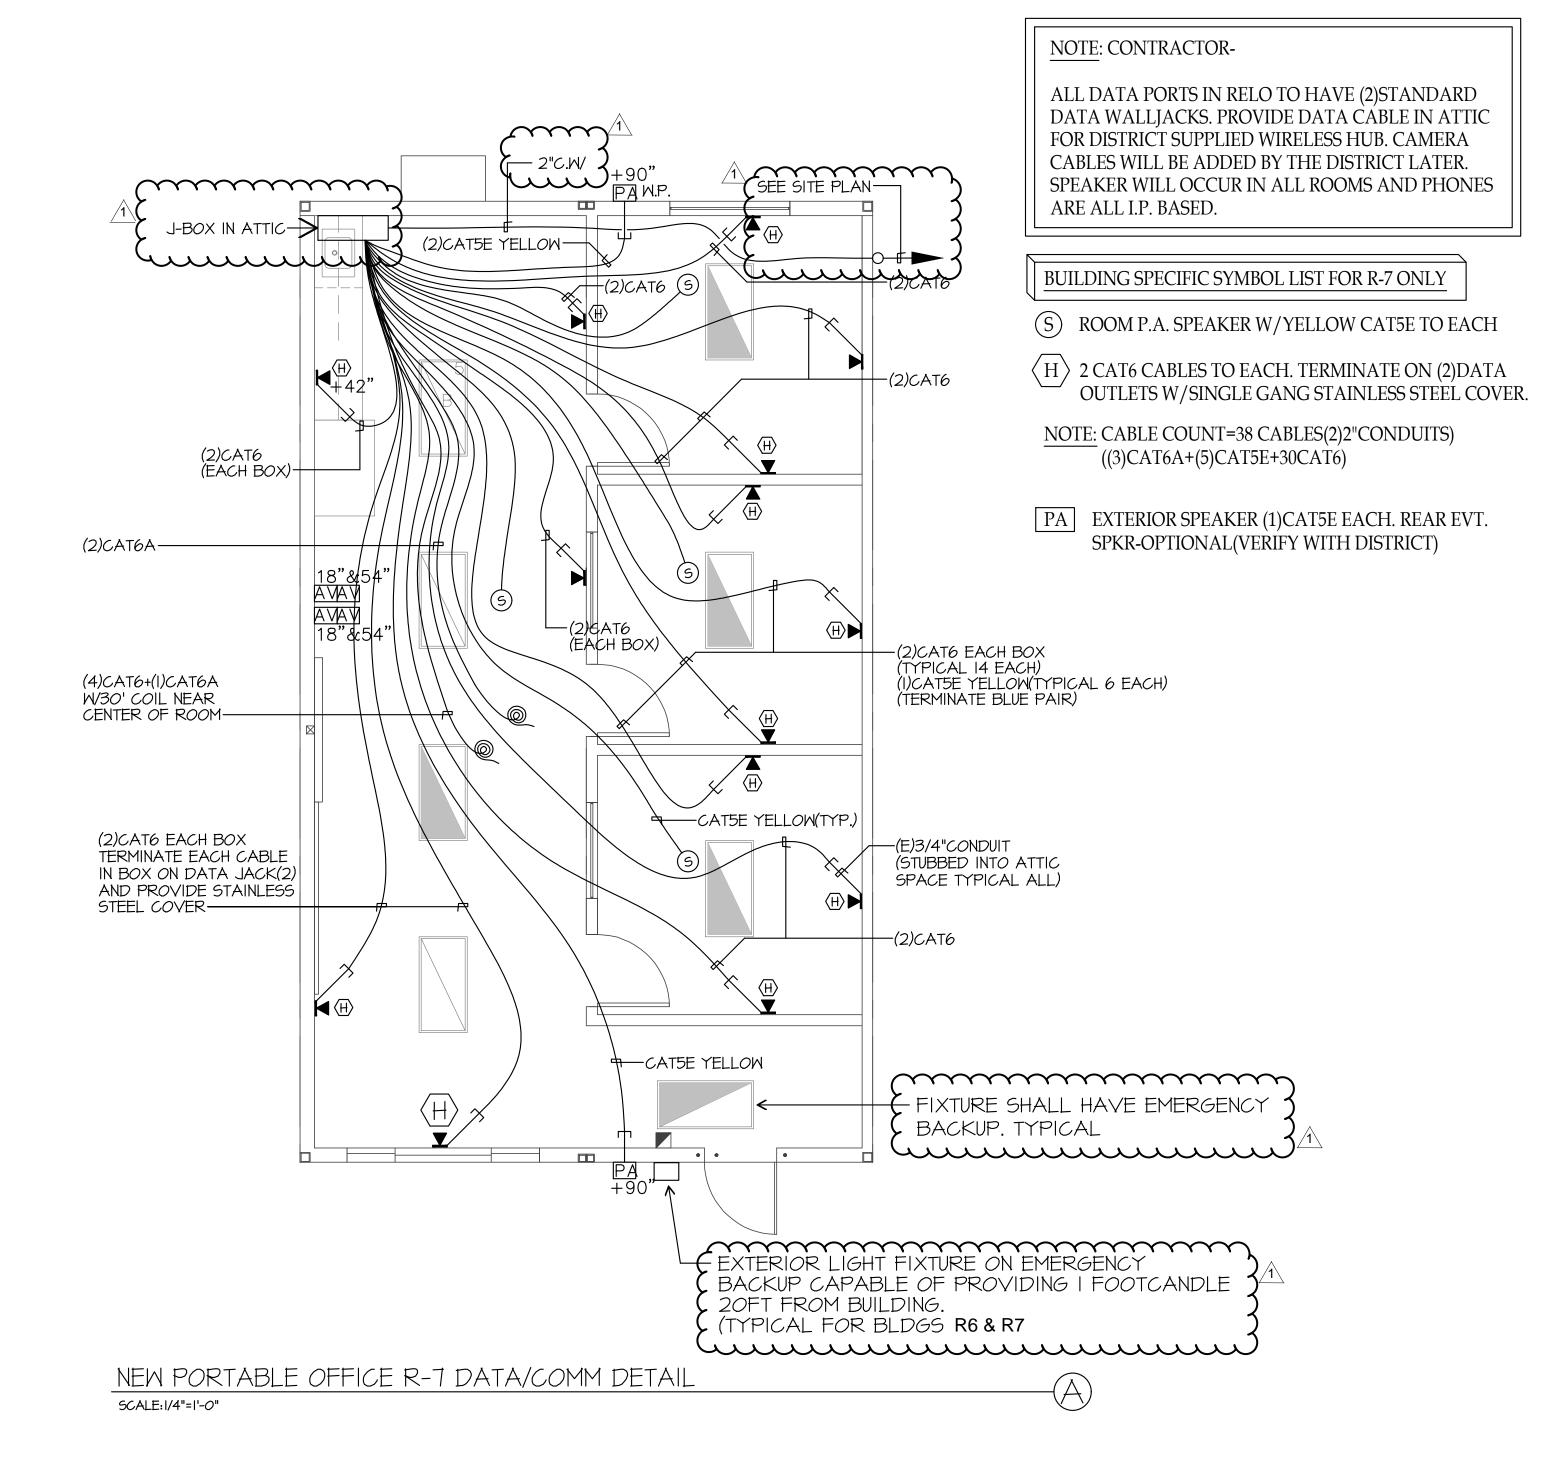

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CONSULTANT

ELECTRICAL ENGINEERING

LIGHTING DESIGN

CA REGISTRATION NO E13083

17166

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SUITE 251
BAKERSFIELD, CA 93309
(661) 831-7851
FAX (661) 831-7813
email: maloney@jmpe.net
www.jmpe.net

APPROVED
DIV. OF THE STATE ARCHITECT

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DATE: 09/26/2019

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AGENCY TRACKING NO. 63321-241
FILE NO. 15-6



BAKERSFIELD CITY SCHOOL DISTRICT



BESSIE OWENS INTERMEDIATE -

815 EUREKA ST. BAKERSFIELD CA, 93305

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 PROJECT NO:
 109668

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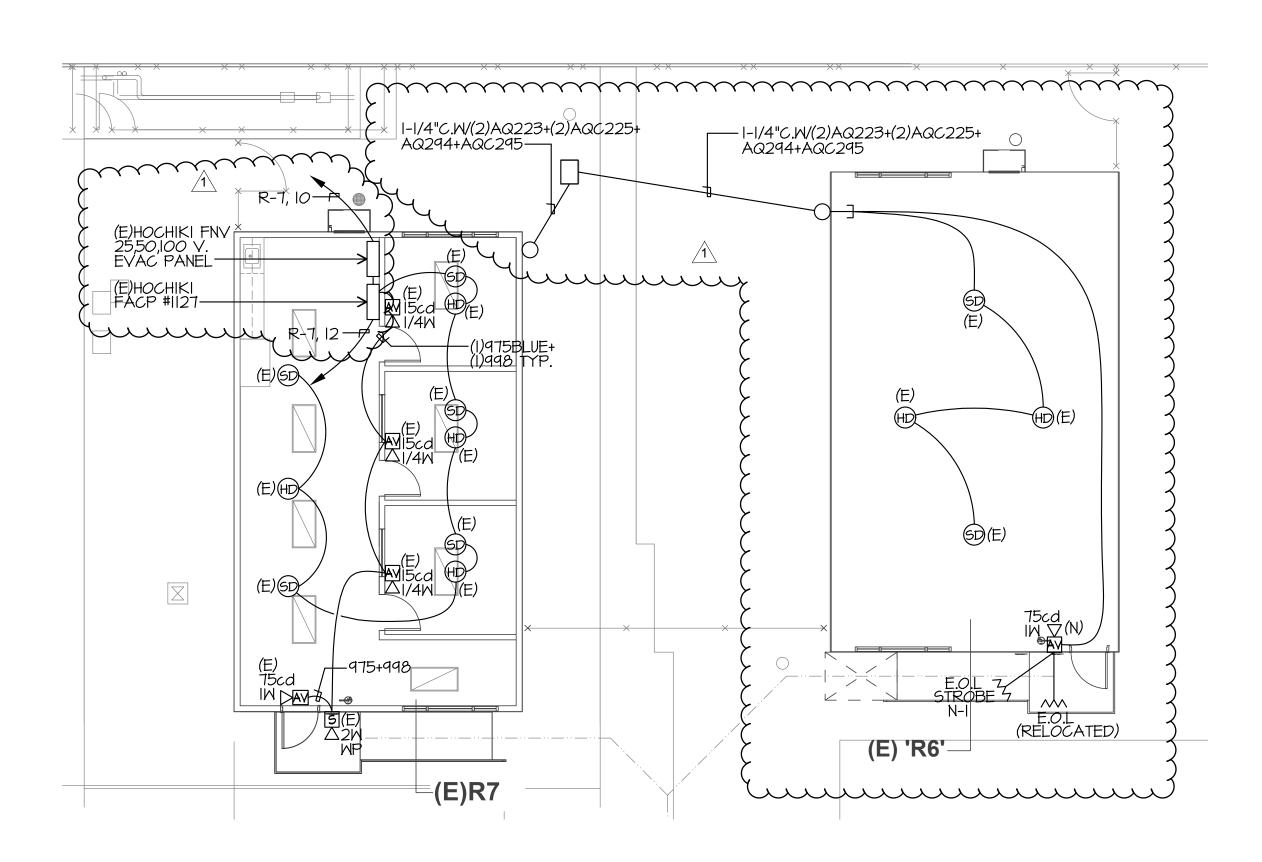
 SHEET TITLE

DATA PLAN

SHEET NUMBER

CCD #1

E-0.3



FIRE ALARM PORTABLE PLAN TYPICAL

SCALE: 1/8"=1'-0"

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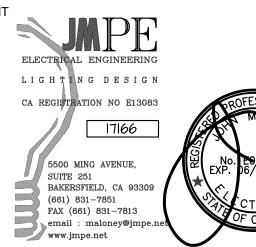
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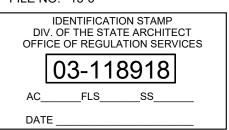
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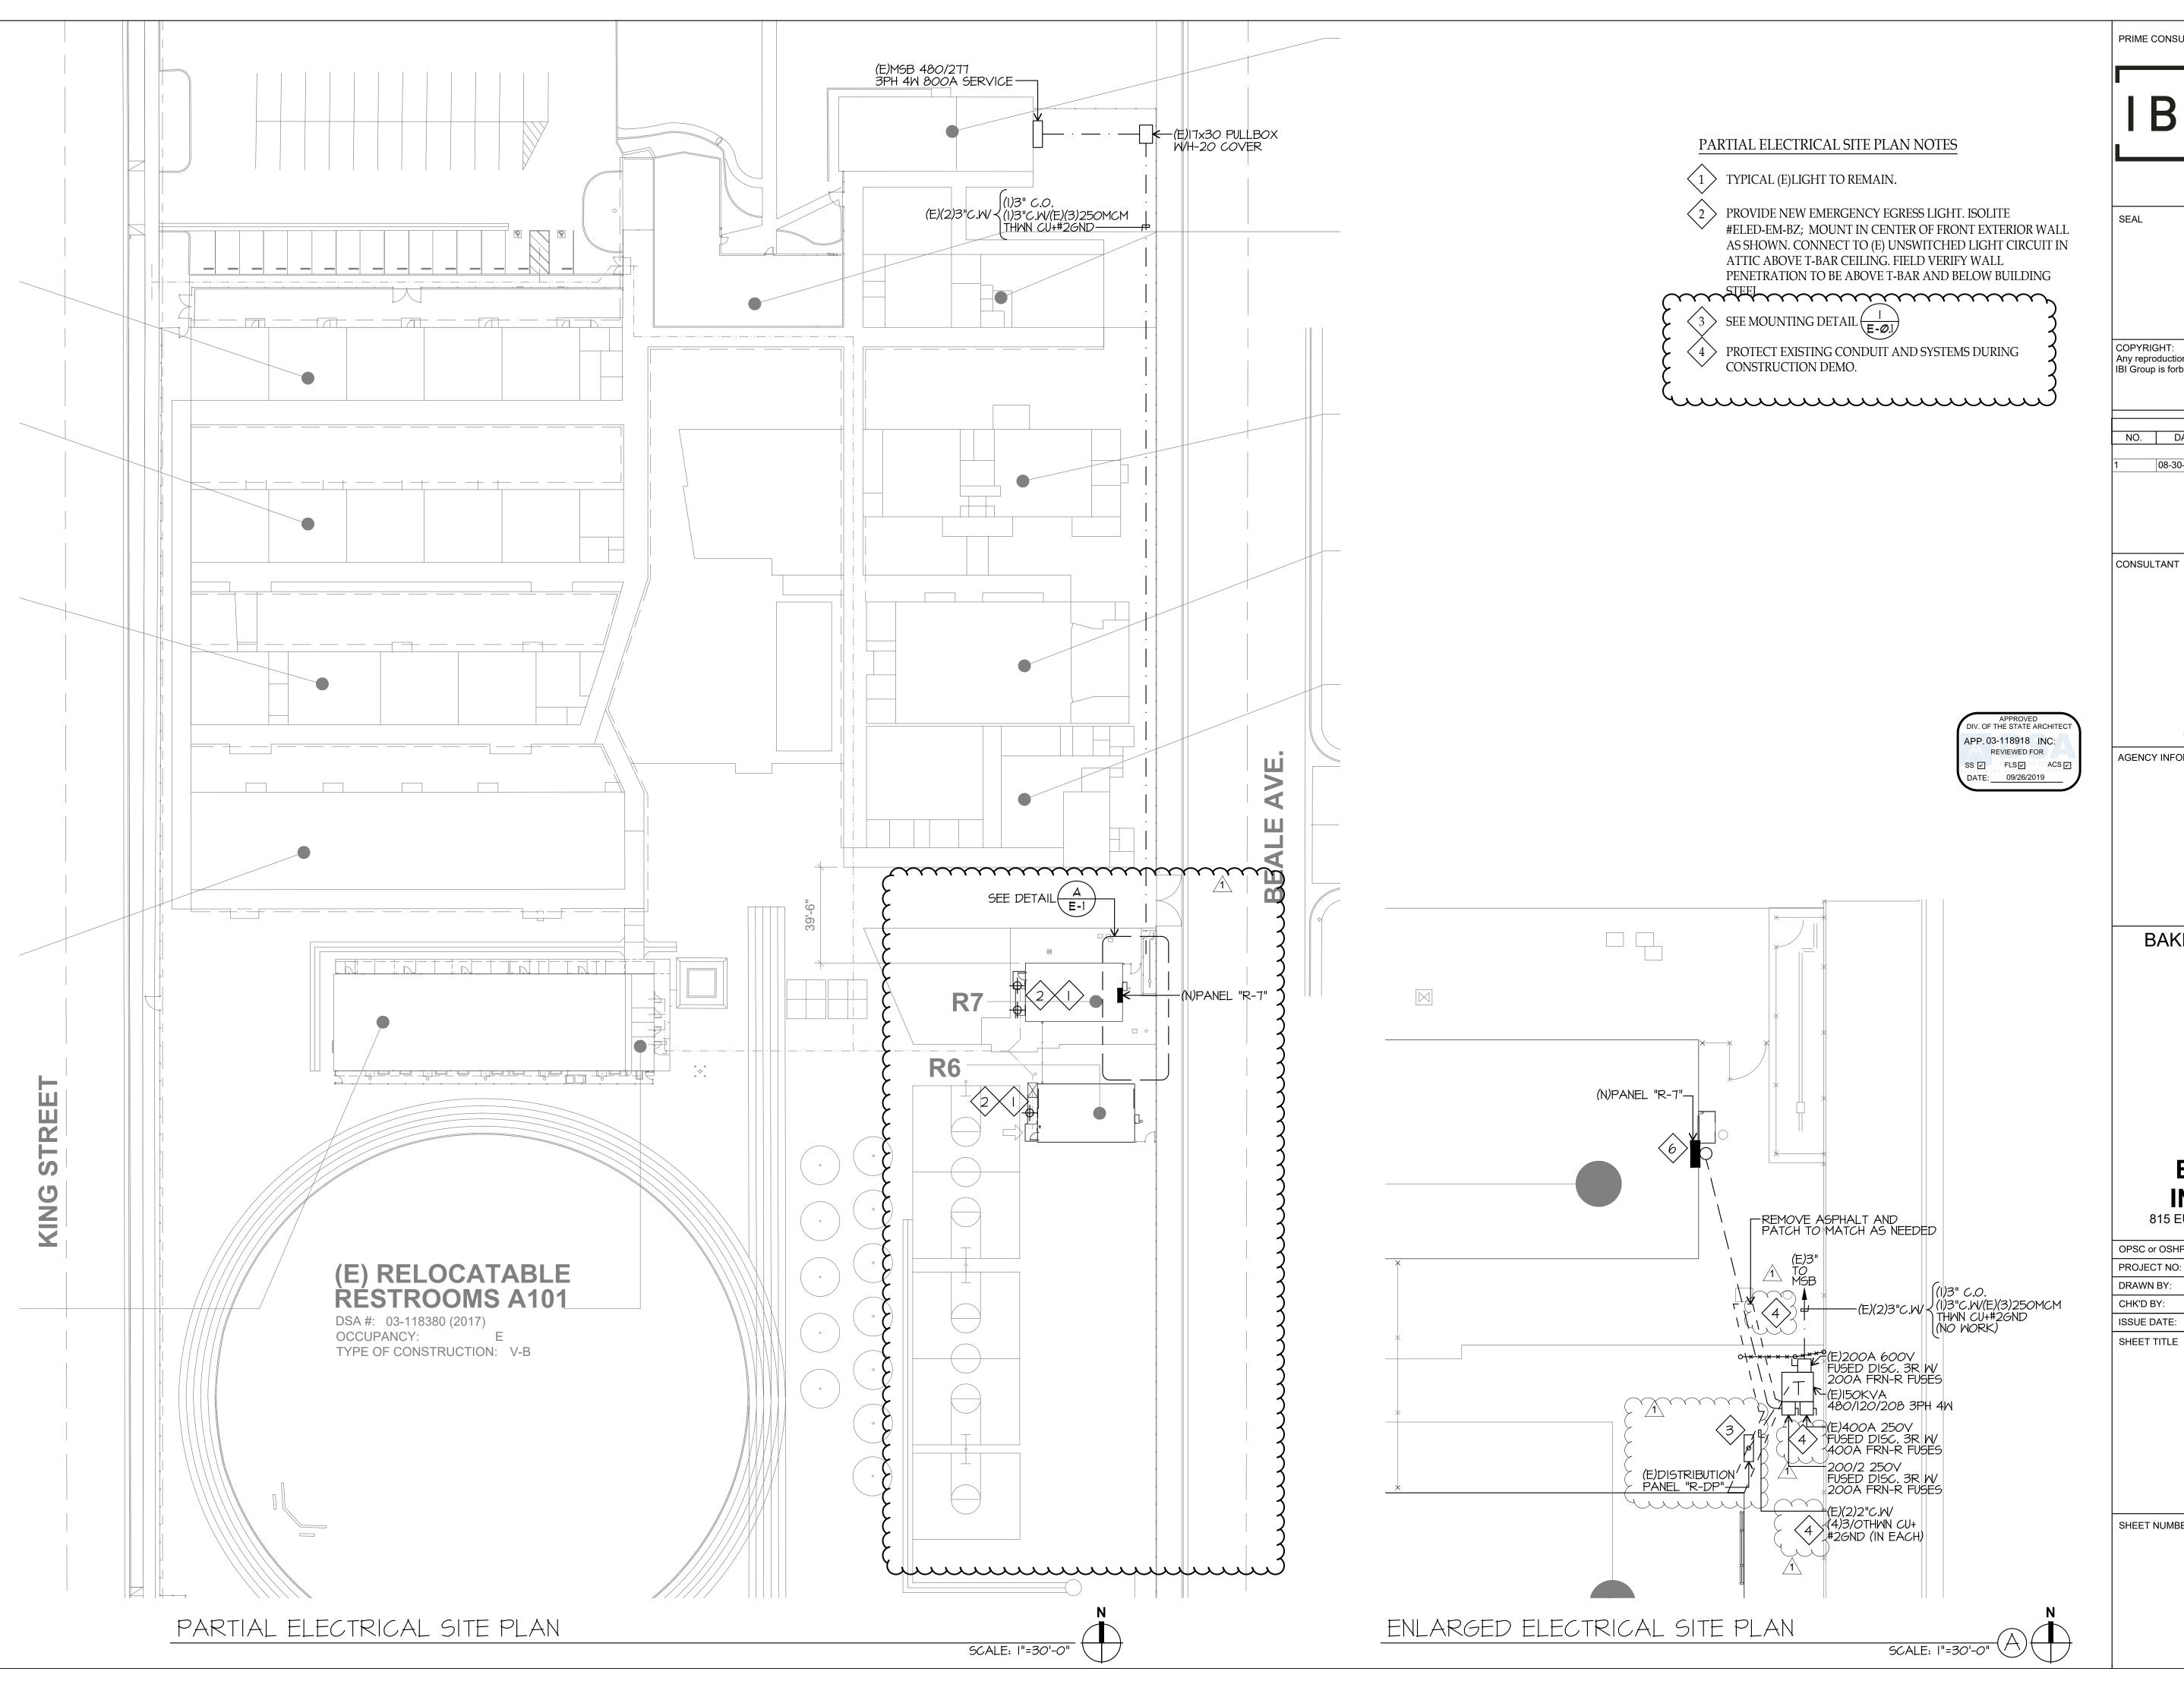
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ISSUE DATE:	03/27/2018
SHEET TITLE	

FIRE ALARM PORTABLE PLAN

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FILE NO. 15-6 IDENTIFICATION STAMP
DIV. OF THE STATE ARCHITECT
OFFICE OF REGULATION SERVICES 03-118918 AC____FLS____SS__ DATE _

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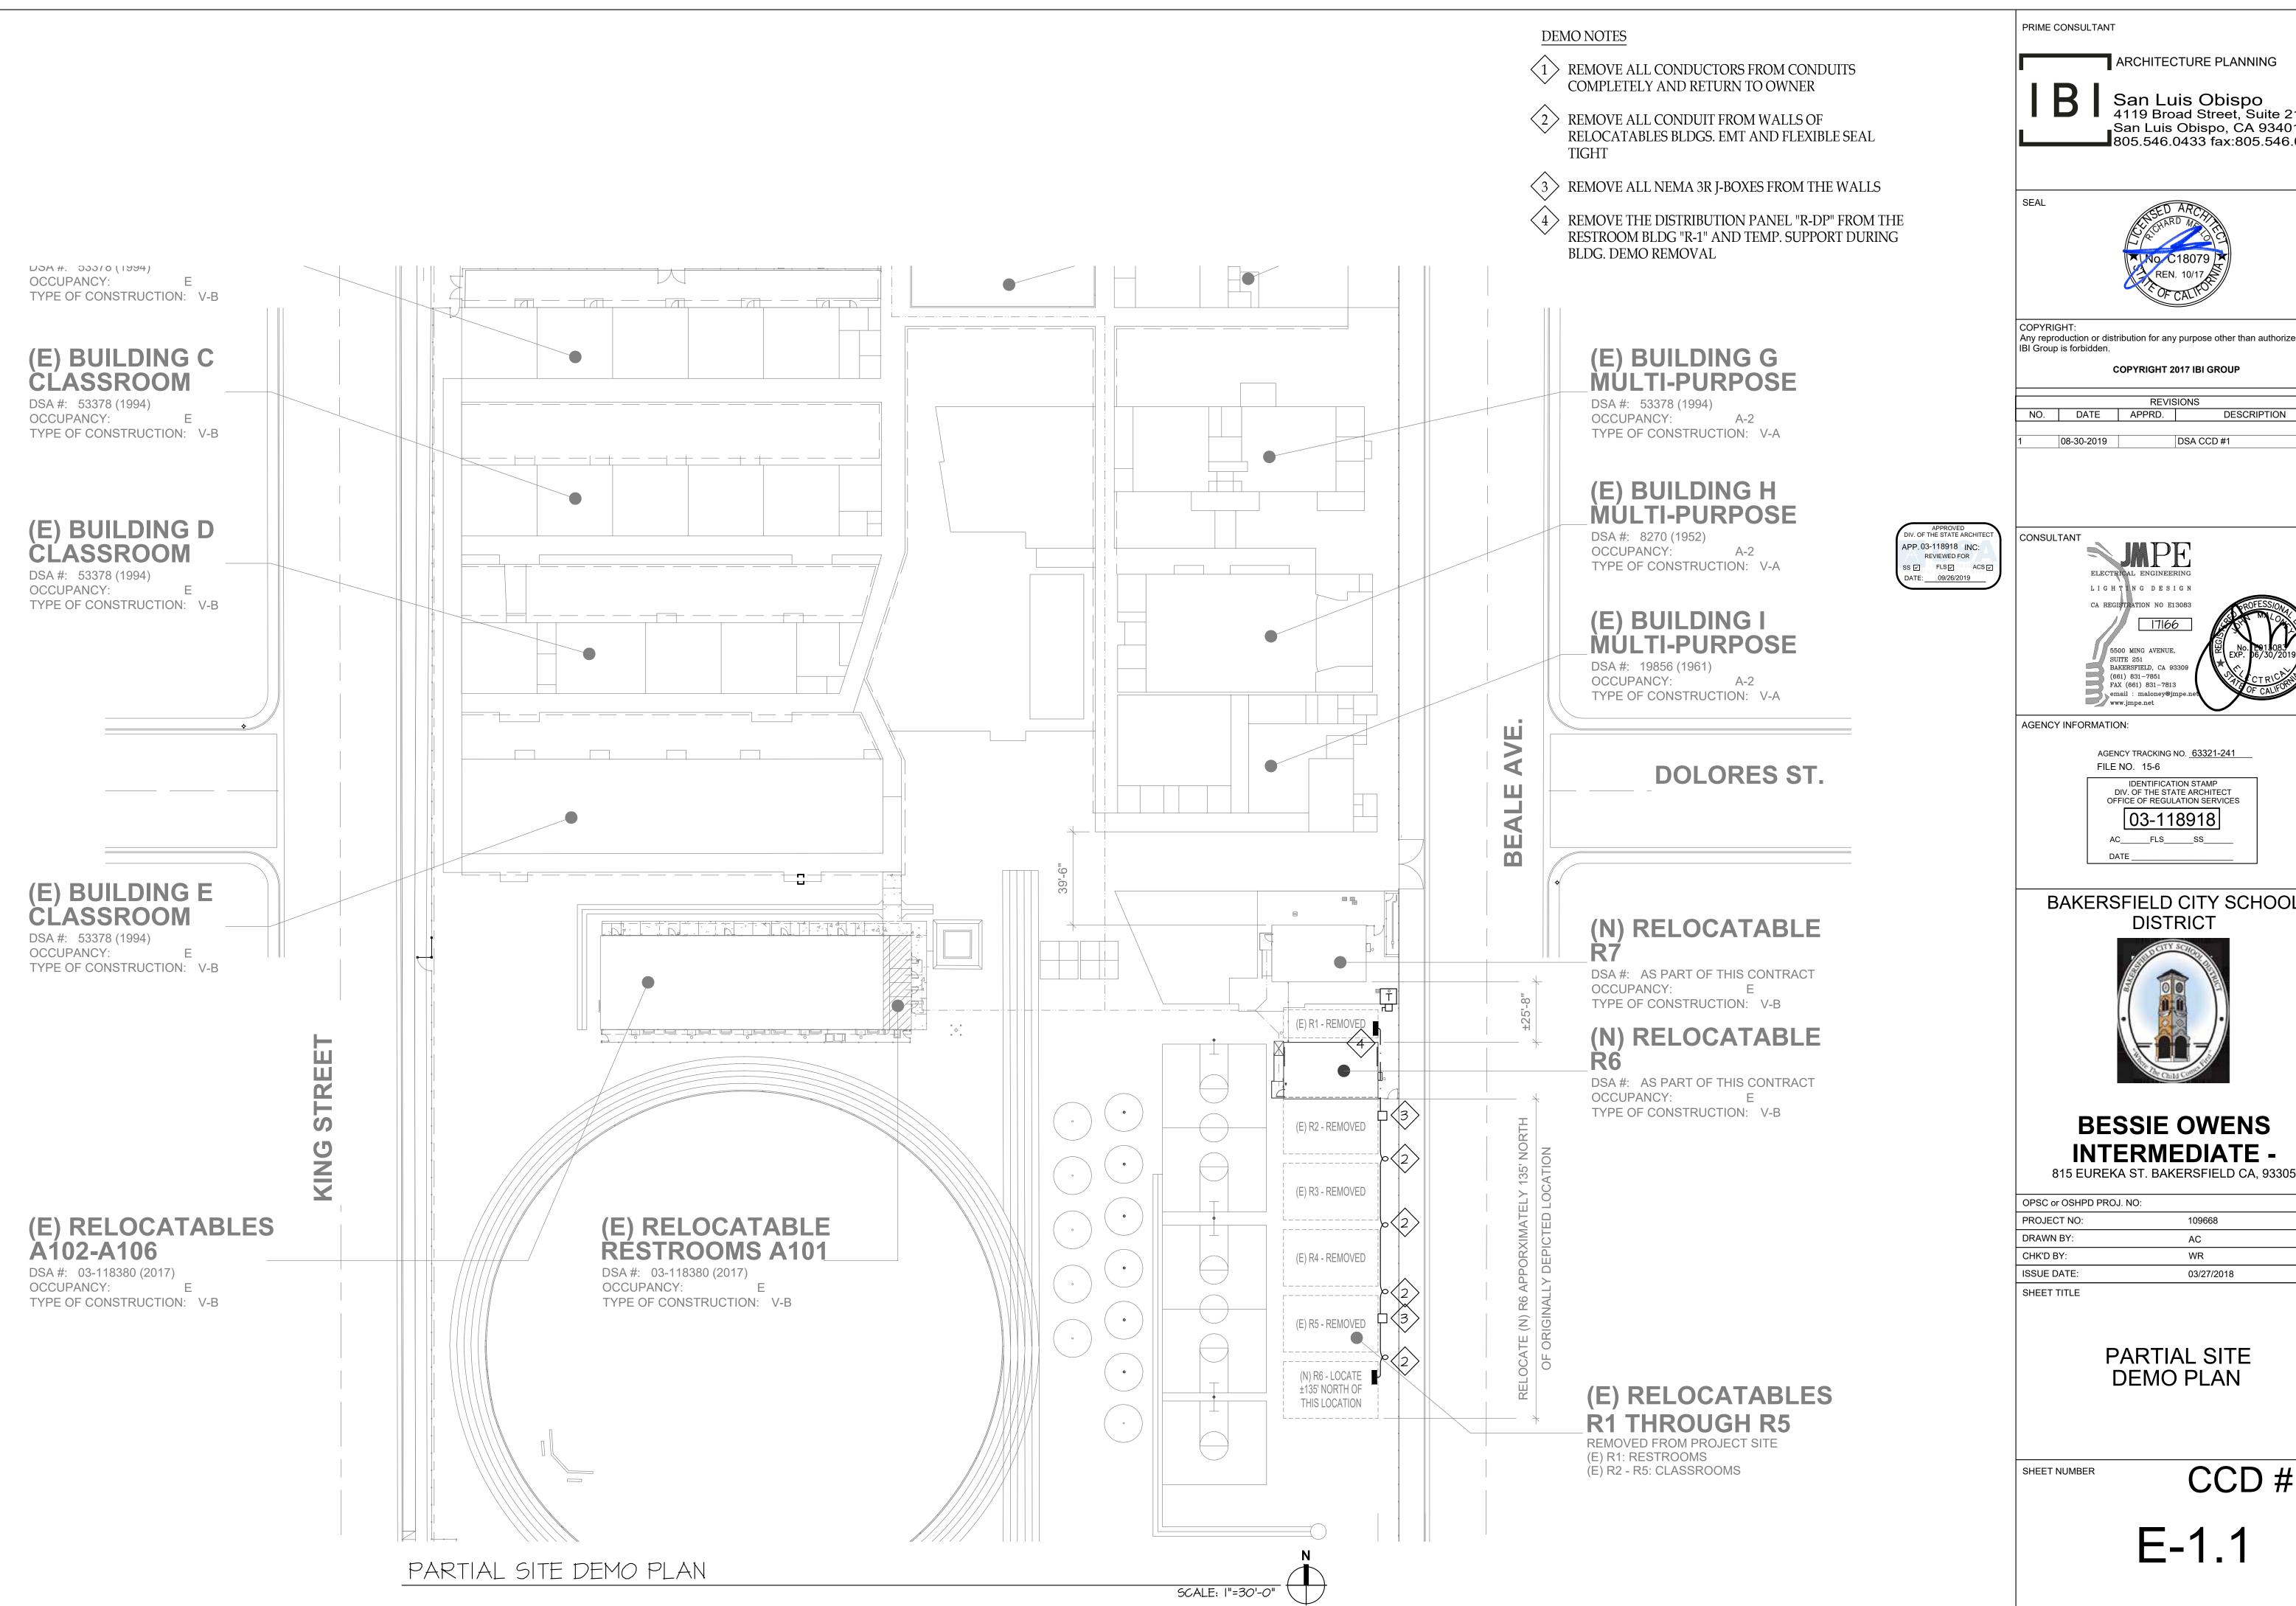
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PARTIAL SITE ELECTRICAL PLAN

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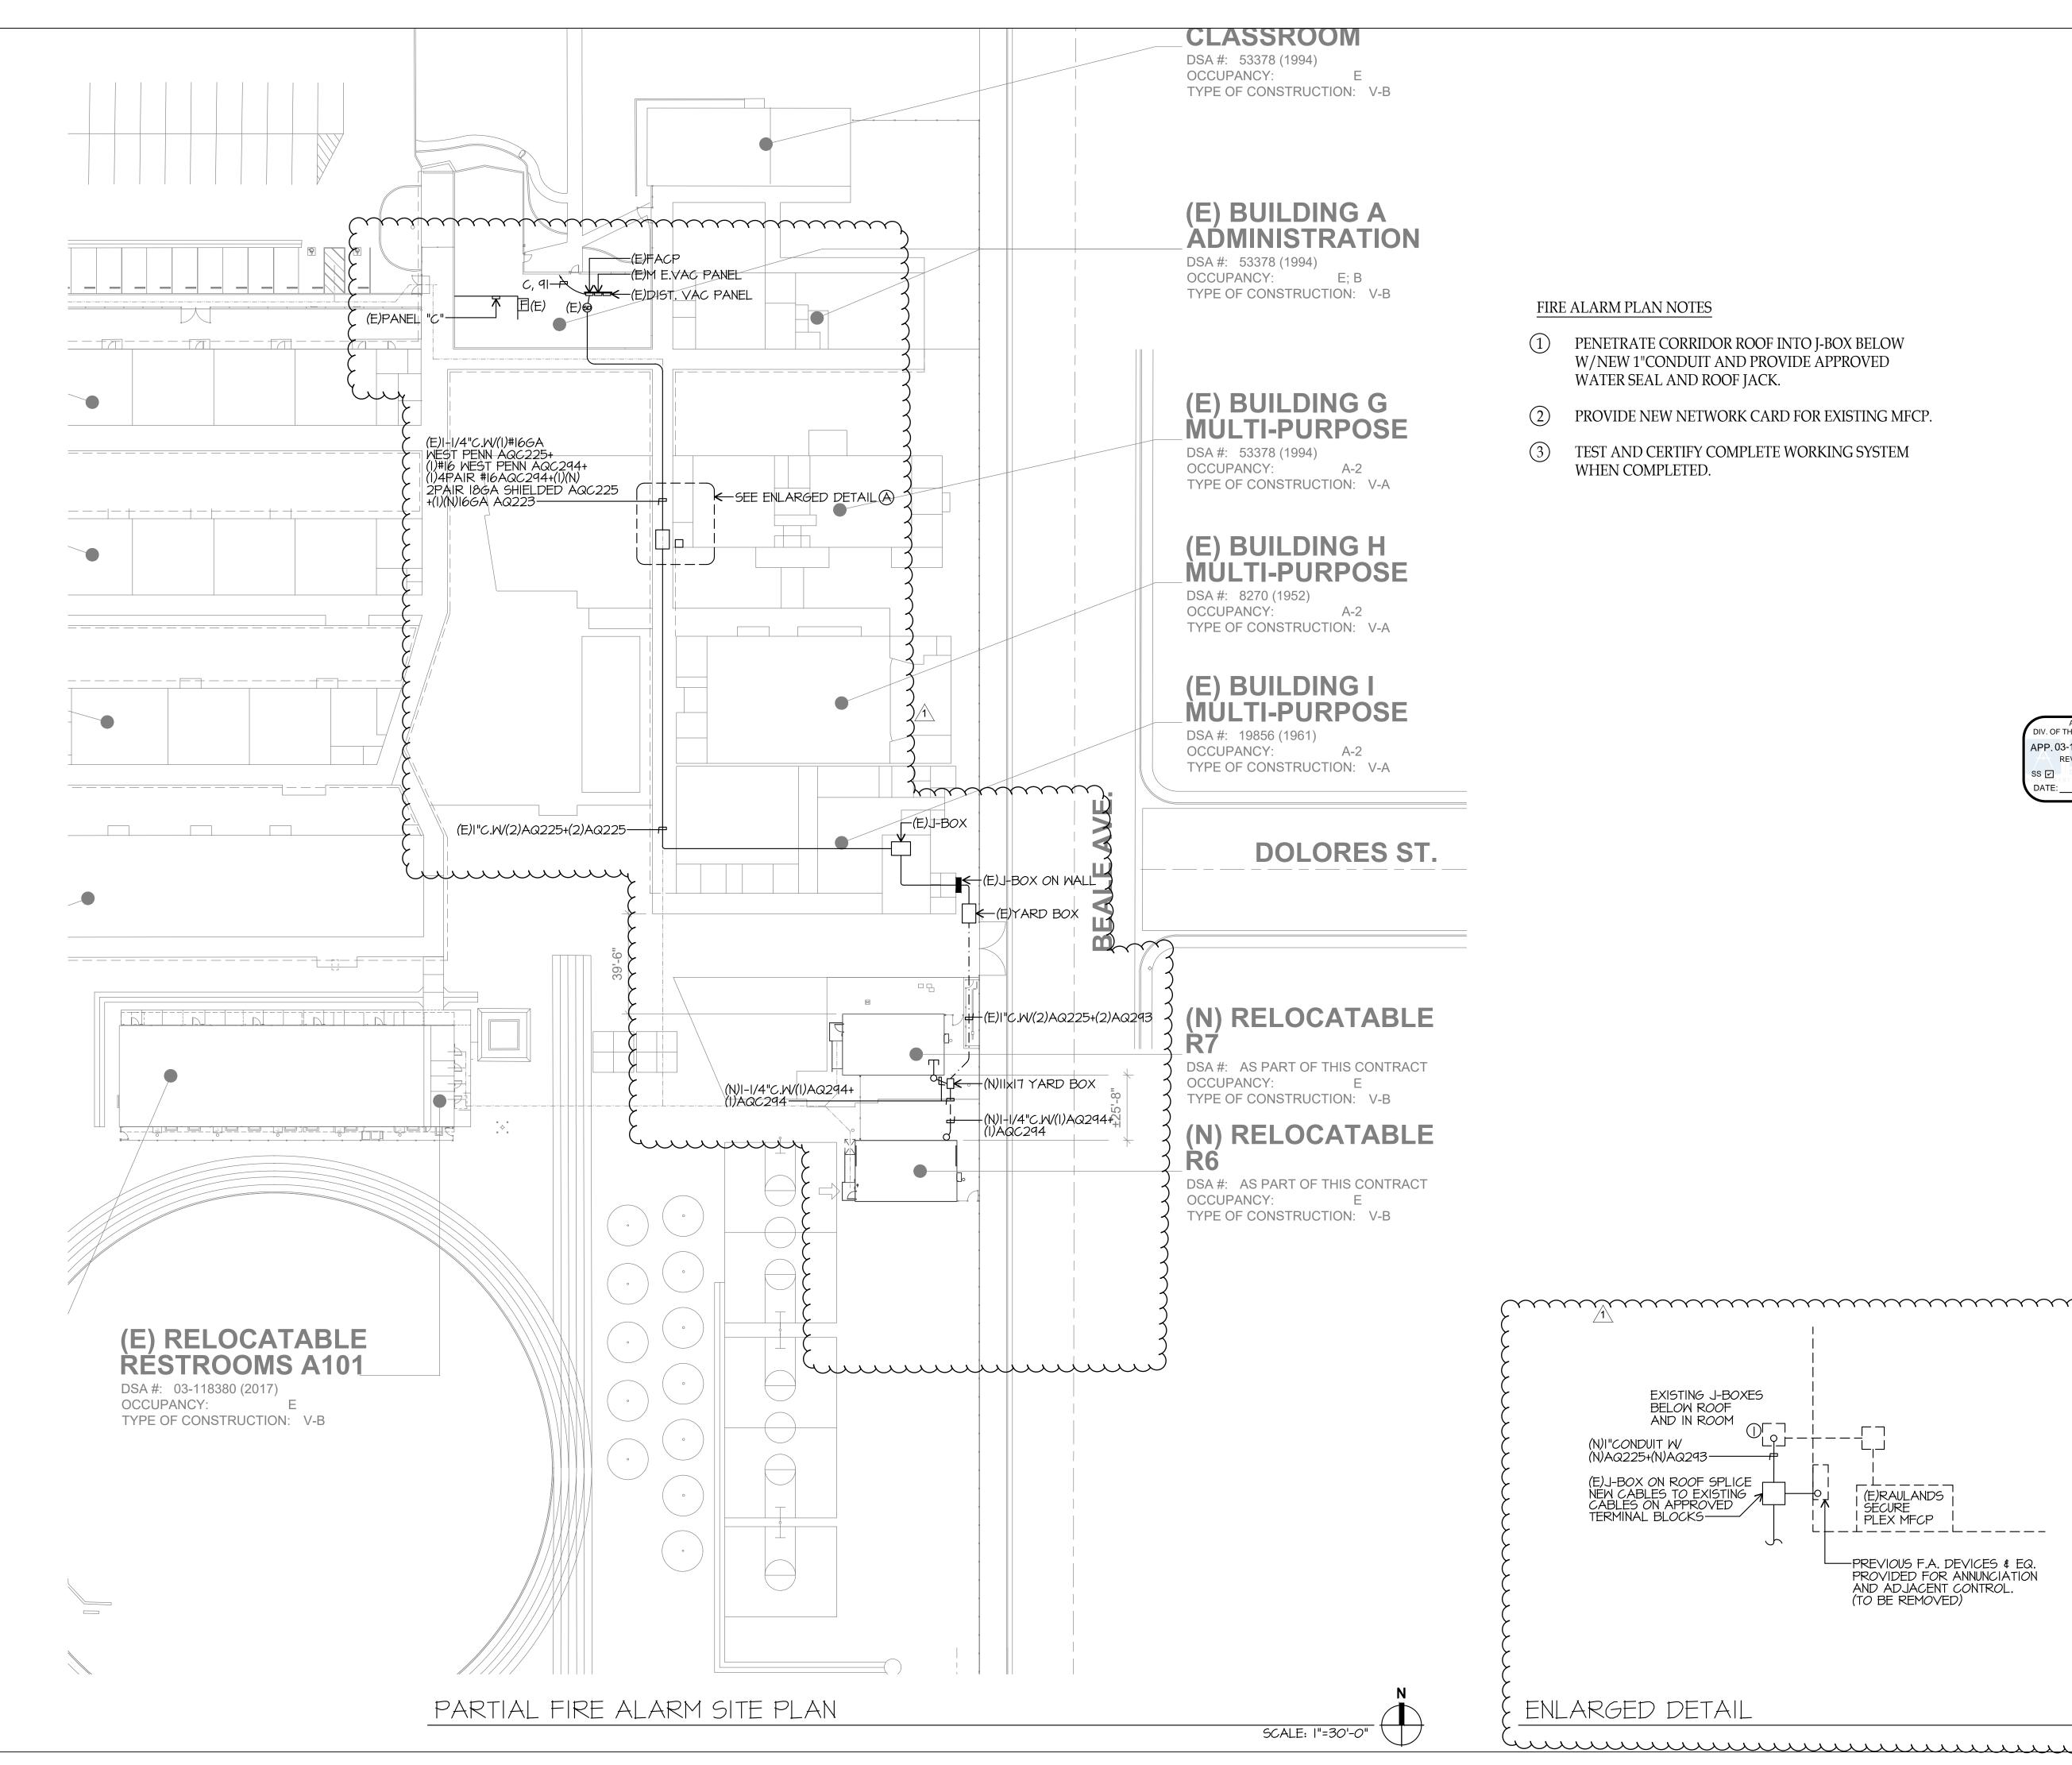
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PARTIAL SITE DEMO PLAN

SHEET NUMBER

CCD #1

E-1.1



FIRE ALARM PLAN NOTES

- PENETRATE CORRIDOR ROOF INTO J-BOX BELOW W/NEW 1"CONDUIT AND PROVIDE APPROVED WATER SEAL AND ROOF JACK.
- PROVIDE NEW NETWORK CARD FOR EXISTING MFCP.
- TEST AND CERTIFY COMPLETE WORKING SYSTEM WHEN COMPLETED.


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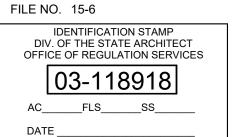
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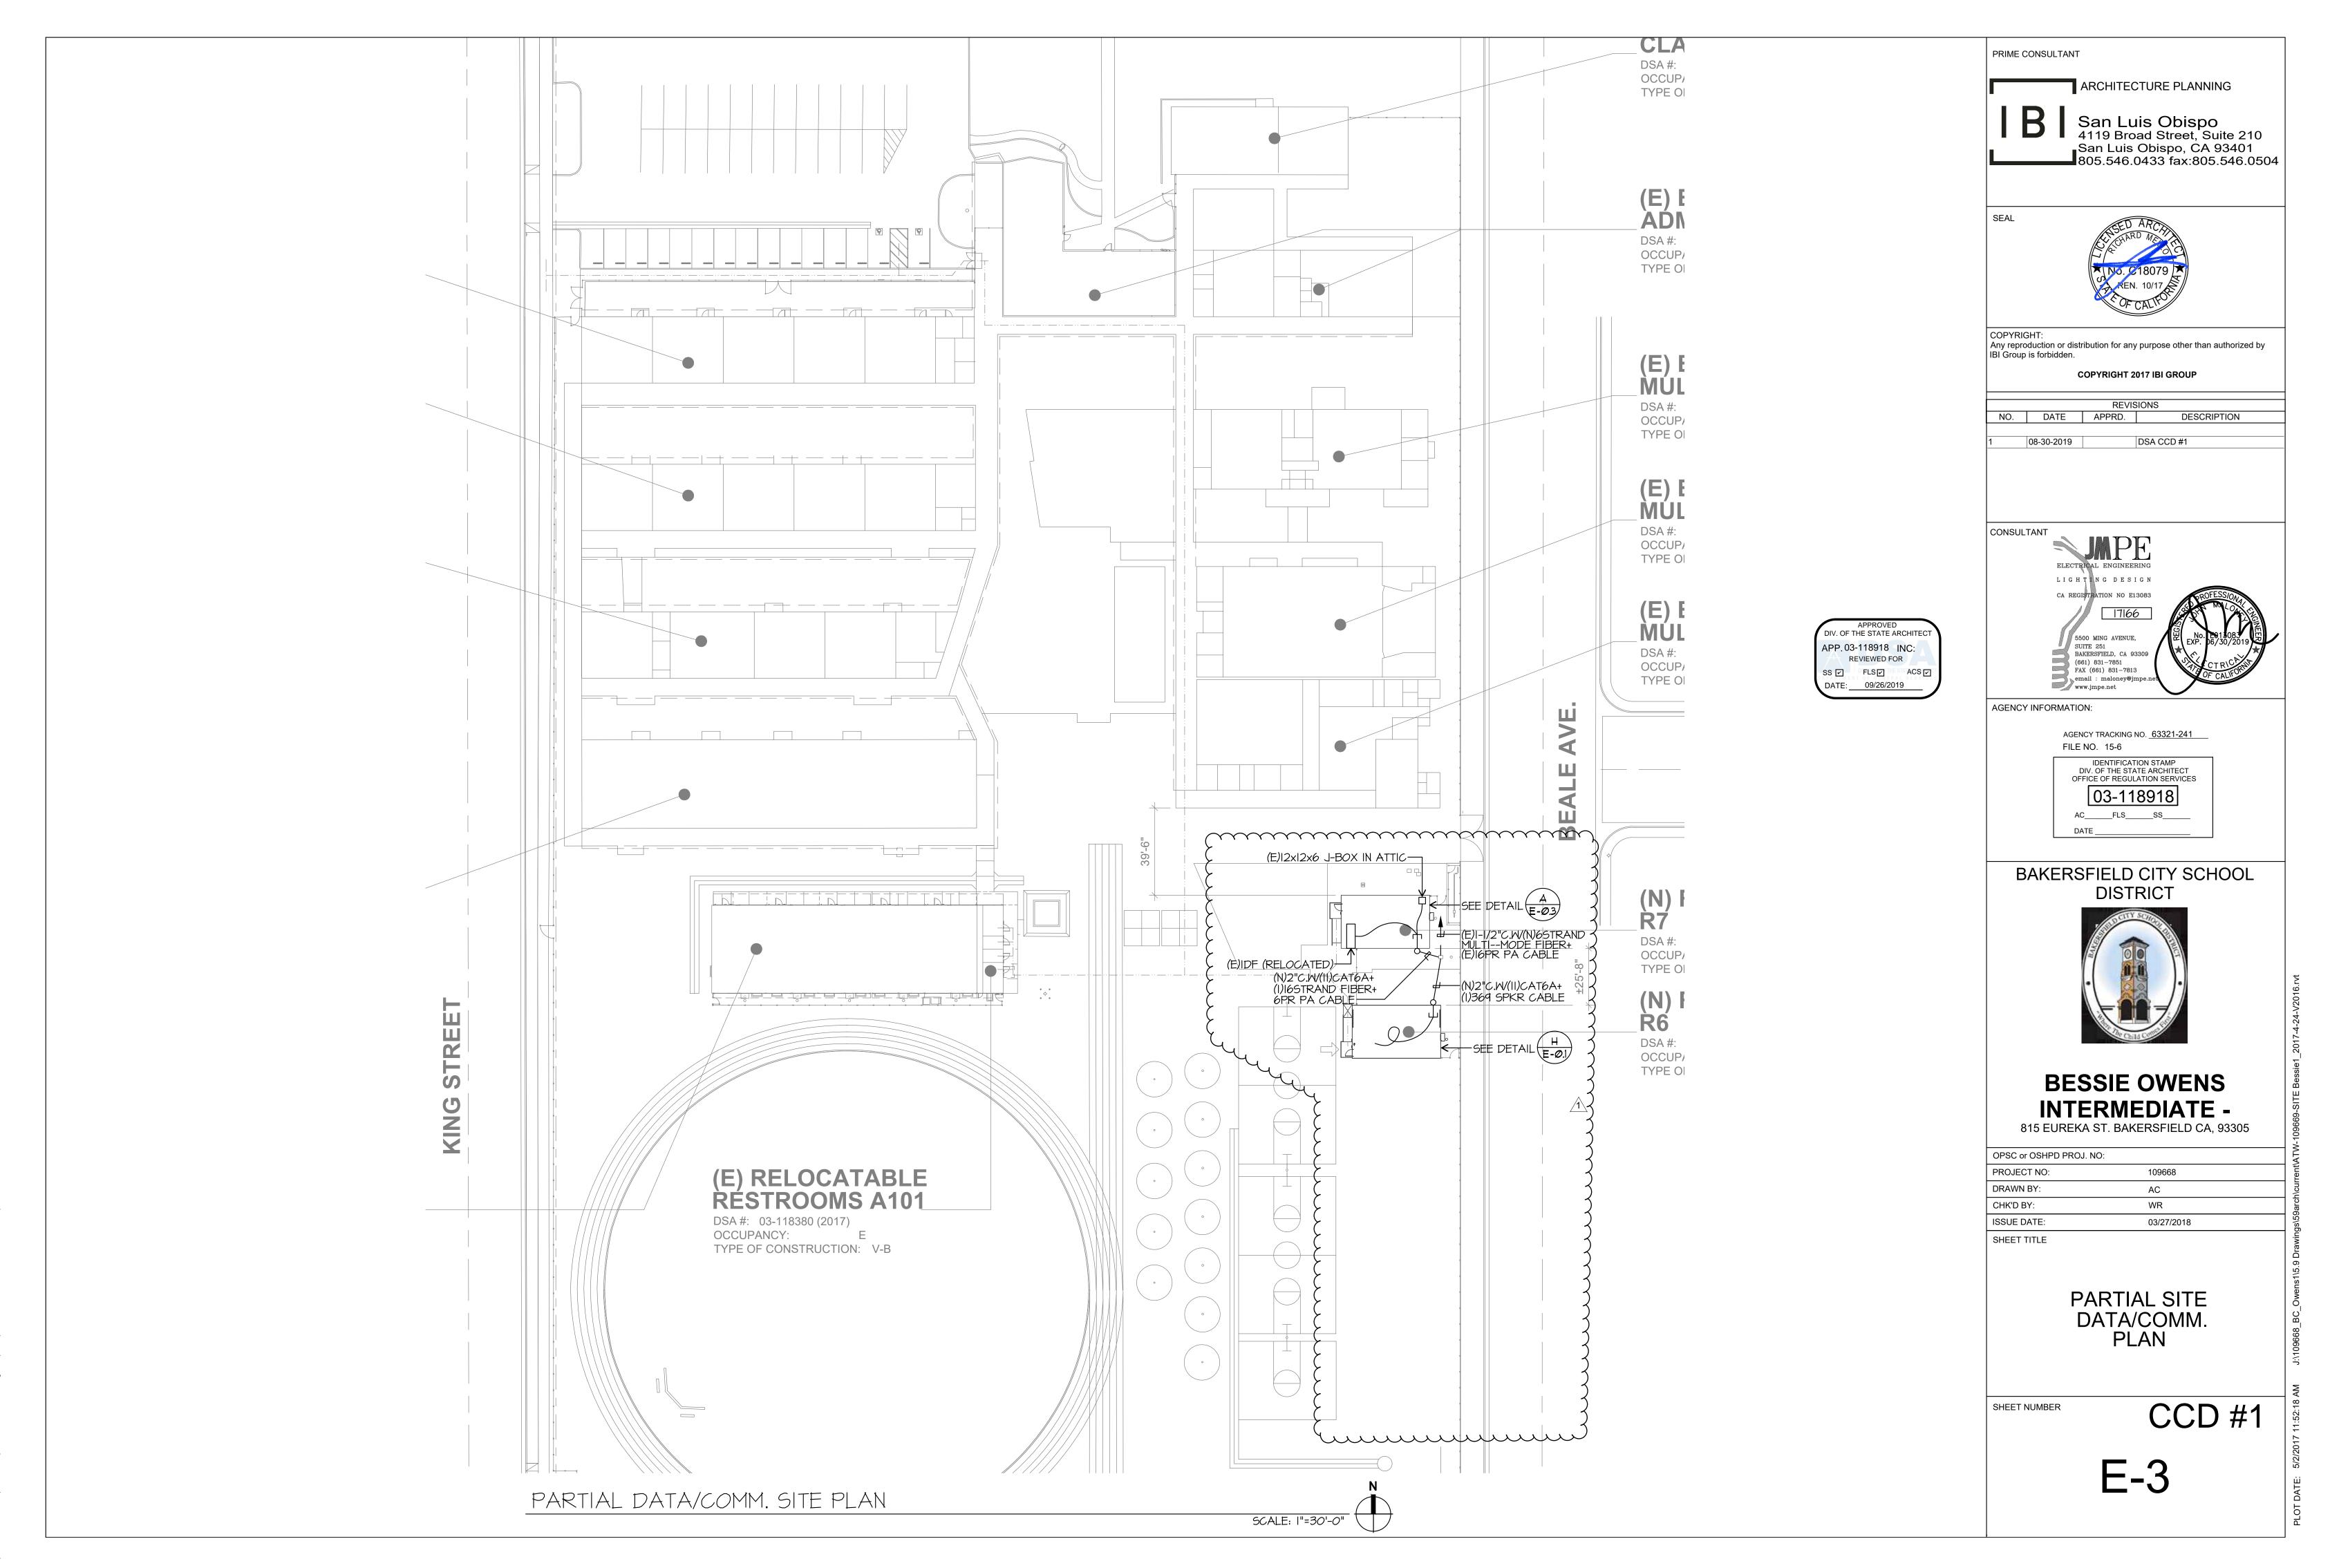
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ISSUE DATE:	03/27/2018
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PARTIAL SITE FIRE ALARM PLAN

SHEET NUMBER

CCD #1

EXISTING J-BOXES BELOW ROOF AND IN ROOM (N)I"CONDUIT W/ (N)AQ225+(N)AQ293-(E)J-BOX ON ROOF SPLICE NEW CABLES TO EXISTING CABLES ON APPROVED TERMINAL BLOCKS (E)RAULANDS SECURE PLEX MFCP PREVIOUS F.A. DEVICES & EQ.
PROVIDED FOR ANNUNCIATION
AND ADJACENT CONTROL.
(TO BE REMOVED) ENLARGED DETAIL

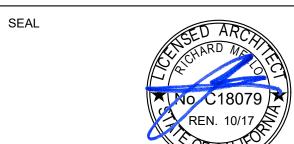

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