TO THE NUMBER OF POWER AND LIGHTING (ARTICLES 210, 215, 220, AND 230) CONDUCTORS ONLY. EXCEPTION NO. 2: FOR CONDUCTORS INSTALLED IN CABLE TRAYS, THE PROVISIONS OF SECTION 392.11

EXCEPTION NO. 3: DERATING FACTORS SHALL NOT APPLY TO CONDUCTORS IN NIPPLES HAVING A

ABA					NOT EXCEE) FOUR.				
	CEC WIRE FILL TABLE 370-16 HINGTON BOX DIMENSION MIN. MAXIMUM NUMBER OF CONDUCTORS									
JUNCTION BOX DIMENSION, INCHES TRADE SIZE OR TYPE	CU. IN.	NO. 14	NO. 12	NO. 10	NO. 8	NO. 6				
4 x1-1/4 ROUND OR OCTAGONAL	12.5	6	5	5	5	2				
4 X1-1/2 ROUND OR OCTAGONAL	15.5	7	6	6	5	3				
4 X2-1/8 ROUND OR OCTAGONAL	21.5	10	9	. 8	7	4				
4 x1-1/4 SQUARE	18.0	9	8	7	6	3				
4 X1-1/2 SQUARE	21.0	10	9	8	7	4				
4 X2-1/8 SQUARE	30.3	15	13	12	10	6				
4-11/16 x1-1/4 SQUARE	25.5	12	11	10	8	5				
4-11/16 X1-1/2 SQUARE	29.5	14	13	11	9	5				
4-11/16 X2-1/8 SQUARE	42.0	21	18	16	14	8				
3 x2 x1-1/2 DEVICE	7.5	3	3	3	2	1				
3 x2 x2 DEVICE	10.0	5	4	4	3	2				
3 x2 x2-1/4 DEVICE	10.5	5	4	4	3	2				
3 x2 x2-1/2 DEVICE	12.5	6	5	5	4	2				
3 x2 x2-3/4 DEVICE	14.0	7	-6	5	4	2				
3 x2 x3-1/2 DEVICE	18.0	9	8	7	6	3				
4 X2-1/8 X1-1/2 DEVICE	10.3	5	4	4	3	2				
4 X2-1/8 X1-7/8 DEVICE	13.0	6	5	5	4	2				
4 X2-1/8 X2-1/8 DEVICE	14.5	7	6	5	4	2				
3-3/4 x2 x2-1/2 MASONRY BOX / GANG	14.0	7	6	5	4	2				
3-3/4 x2 x3-1/2 MASONRY BOX / GANG	21.0	10	9	8	7	4				
FS - MINIMUM INTERNAL DEPTH 1-3/4 SINGLE COVER / GANG	13.5	6	6	5	4	2				

1-3/4 MULTIPLE COVER / GANG 18.0 9 8 7 6 3

2-3/8 MULTIPLE COVER / GANG 24.0 12 10 9 8 4

18.0 9 8 7 6 3

1-3/4 SINGLE COVER / GANG 13.5 6
FD - MINIMUM INTERNAL DEPTH 18.0

2-3/8 SINGLE COVER / GANG 18.0 9 6 /
FS - MINIMUM INTERNAL DEPTH 19.0 9 8 7

GENERAL ELECTRICAL NOTES THE DRAWINGS AND THESE GENERAL NOTES DESCRIBE THE SCOPE OF WORK AND SYSTEMS. THE MATERIAL REQUIRED FOR THE WORK SHALL BE CONTRACTOR FURNISHED AND CONTRACTOR INSTALLED, UNLESS SPECIFICALLY NOTED OTHERWISE. THE WORK INCLUDES BUT IS NOT LIMITED TO THE FOLLOWING PRINCIPAL

PERMITS AND CHARGES:
OBTAIN AND PAY FOR ALL NECESSARY CONSTRUCTION PERMITS, INSPECTION FEES, AND OTHER CHARGES BY REGULATIONS AND CODES:
PROVIDE AND INSTALL ALL MATERIALS IN CONFORMANCE WITH THE NATIONAL ELECTRICAL CODE, CALIFORNIA ADMINISTRATIVE CODE TITLE 8, AND OTHER CODES AND REGULATIONS HAVING JURISDICTION. INSTALL ALL EQUIPMENT IN ACCORDANCE WITH THE REQUIREMENTS OF THE INSPECTING AUTHORITY AND MANUFACTURERS

VERIFYING EXISTING CONDITIONS:
BEFORE SUBMITTING BID, BECOME THOROUGHLY FAMILIAR WITH ACTUAL EXISTING CONDITIONS AT THE
BUILDING SITE. THE INTENT OF THE WORK IS SHOWN ON THE DRAWINGS AND DESCRIBED HEREINAFTER. BY
THE ACT OF SUBMITTING A BID PROPOSAL FOR THE WORK, THE CONTRACTOR SHALL BE DEEMED TO HAVE
MADE SUCH STUDY AND EXAMINATION AND TO ACCEPT ALL CONDITIONS PRESENT AT THE SITE. NO REQUEST
FOR ADDITIONAL PAYMENT WILL BE CONSIDERED AS VALID, DUE TO FAILURE TO ALLOW FOR CONDITIONS

COORDINATION:
COORDINATE ALL WORK WITH OTHER TRADES, OBTAIN ALL DRAWINGS THAT WILL REQUIRE COORDINATION AND PROVIDE ALL ELECTRICAL CONNECTIONS REQUIRED WHETHER SHOWN ON ELECTRICAL DRAWINGS OR NOT. ELECTRICAL EQUIPMENT LOCATIONS INDICATED ARE SHOWN DIAGRAMMATICALLY, EXACT LOCATION SHALL BE

SERVICE CONTINUITY:
UNINTERRUPTED EXISTING ELECTRICAL POWER SHALL BE MAINTAINED TO OTHER TRADES FOR TEMPORARY
POWER AREAS OF THE SITE DURING CONSTRUCTION. PROVIDE ANY TEMPORARY SERVICES AS MAY BE
REQUIRED. IDENTIFY AT BID TIME, ALL WORK TO BE DONE ON PREMIUM TIME AND THE TOTAL OVERTIME MAN-HOURS REQUIRED FOR COMPLETION.

PROVIDE RECORD DRAWINGS TO THE OWNER WITH ALL CHANGES NOTED THERON AT THE COMPLETION OF THE PROJECT. RECORD DRAWINGS SHALL BE SIGNED AND DATED BY CONTRACTOR PRIOR TO RELEASE OF MARK PROJECT RECORD DOCUMENTS DAILY TO INDICATE ALL CHANGES MADE IN THE FIELD.

A.) IN ADDITION TO GENERAL REQUIREMENTS OF PROJECT RECORD DRAWINGS, INDICATE ON DRAWINGS, CHANGES OF EQUIPMENT LOCATIONS AND RATINGS, TRIP SIZES, AND SETTINGS ON CIRCUIT PREAKERS, ALTERATIONS IN RACEWAY RUNS AND SIZES, CHANGES IN WIRE SIZES, CIRCUIT DESIGNATIONS, NSTALLATION DETAILS, ONE—LINE DIAGRAMS, CONTROL DIAGRAMS AND SCHEDULES USE GREEN TO INDICATE DELETIONS AND RED TO INDICATE ADDITIONS. A.) USE THE SAME SYMBOLS AND FOLLOW THE SAME DRAFTING PROCEDURES USED ON THE CONTRACT

LOCATE UNDERGROUND CONDUIT STUBBED-OUT FOR FUTURE USE, UNDERGROUND FEEDER CONDUITS, AND FEEDER PULL BOX LOCATIONS USING BUILDING LINES BY INDICATING ON THE PROJECT RECORD DRAWINGS. AT THE COMPLETION OF UNDERGROUND CONDUIT INSTALLATION, PROVIDE UNDERGROUND CONDUIT RECORD DOCUMENTS TO OWNER'S REPRESENTATIVE. TWO COPIES, IN BINDER FORM, OF ALL TEST RESULTS AS REQUIRED BY THESE DOCUMENTS. TWO COPIES OF LOCAL AND/OR STATE CODE ENFORCING AUTHORITIES FINAL INSPECTION CERTIFICATES.

FIRE ALARM SYSTEM RECORDS AND TESTING REPORTS AS OUTLINED IN NFPA 72, CHAPTER 10.

CONTRACTOR SHALL UNCONDITIONALLY GUARANTEE ALL LABOR AND MATERIALS ON ALL WORK AGAINST DEFECTS IN WORKMANSHIP AND MATERIALS FOR A PERIOD OF ONE YEAR.

TWO COPIES, IN BINDER FORM, OF ELECTRICAL EQUIPMENT CUT SHEETS, MANUFACTURER'S INSTALLATION

INSTRUCTIONS, WARRANTY CERTIFICATES, AND PRODUCT LITERATURE FOR ALL PRODUCTS UTILIZED ON

SHOP DRAWINGS:
SUBMIT SHOP DRAWINGS AND MATERIAL LIST FOR REVIEW PRIOR TO COMMENCING ANY WORK, ALL EQUIPMENT TO BEAR U.L. LABEL OR THAT OF ANOTHER ACCEPTABLE TESTING LABORATORY. SHOP DRAWINGS MUST BE STAMPED BY THE CONTRACTOR FOR CONFORMANCE PRIOR TO SUBMITTAL. SUBMIT SIX SETS OF SHOP DRAWINGS FOR REVIEW PRIOR TO PURCHASING ALL BREAKER MOUNTING HARDWARE, DISCONNECT SWITCHES, FUSES, CONTROLLERS, LIGHTING FIXTURES, LIGHT SWITCHES,

CONTRACTOR'S BID SHALL BE BASED ON ALL WORK SHOWN ON THE PLANS AND AS SPECIFIED. IF CONTRACTOR PROPOSES TO SUBSTITUTE FOR EQUIPMENT SPECIFIED, HE SHALL SUBMIT HIS REQUEST FOR CONSIDERATION OF THE OWNER AND ENGINEER PRIOR TO BID IN WRITING. ALL SUBSTITUTIONS SHALL BE REVIEWED BY THE ENGINEER IN WRITING, SUCH REVIEW SHALL NOT RELIEVE THE CONTRACTOR FROM COMPLYING WITH THE REQUIREMENTS OF THE DRAWINGS AND SPECIFICATIONS, AND THE CONTRACTOR SHALL BE RESPONSIBLE AT HIS/HER OWN EXPENSE FOR ANY CHARGES RESULTING FROM HIS PROPOSED SUBSTITUTIONS WHICH AFFECT OTHER PARTS OF HIS/HER OWN WORK, THE OWNER, ENGINEER OF RECORD OR THE WORK OF OTHER CONTRACTORS.

ALL WORK AND MATERIAL SHALL CONFORM TO THE LATEST RULES OF THE GOVERNING ELECTRICAL CODE AND INSTALLATION SHALL BE OF THE LATEST INDUSTRY STANDARDS OF WORKMANSHIP.

CONDUIT SHALL BE EMT, PVC, IMC, RIGID OR FLEXIBLE STEEL TYPE. CONDUIT SHALL BE MANUFACTURED IN ACCORDANCE WITH UL-1. A GROUND WIRE IS REQUIRED IN ALL FLEXIBLE CONDUIT AND UNDERGROUND CONDUIT, BUSHINGS SHALL BE INSTALLED ON ALL UNICATION, TELEPHONE & SPEAKER CONDUITS. PROVIDE 3/16" NYLON PULL STRING IN ALL EMPTY CONDUITS. NO MC, BX, OR AC90 SHALL BE PERMITTED.

SWITCHES AND RECEPTACLES: PROVIDE 20 AMP NEMA RATED SWITCHES AND RECEPTACLES OF SPECIFICATION GRADE. ALL SWITCHES SHALL BE RATED 120 AND/OR 277 VOLT AND RECEPTACLES SHALL BE NEMA 5-20R. IN ALL OFFICES AND OFFICE AREAS, DEVICES SHALL BE DECORA TYPE WITH COLOR SELECTION BY

FEEDERS AND BRANCH CIRCUITS IDENTIFICATION:
IDENTIFY FEEDERS WITH THE CORRESPONDING CIRCUIT DESIGNATION AT THE OVER-CURRENT
DEVICE, LOAD END, AND IN PULL BOXES WITH E-Z CODE OR OTHER APPROVED WIRE MARKER. IDENTIFY BRANCH CIRCUITS WITH I.D. MARKERS, THE CORRESPONDING CIRCUIT DESIGNATION A HE OVER-CURRENT DEVICE. AT ALL SPLICES, IN JUNCTION BOXES, AND IN OUTLETS. USE PLASTIC COATED SELF-STICKING MARKERS SUCH AS THOMAS & BETTS E-Z CODE FOR IDENTIFICATION OF CONDUCTORS. IDENTIFY SIGNAL & COMMUNICATION CABLES AT TERMINAL AND OUTLET.

DELIVER ALL CONDUCTORS TO THE JOB SITE IN ORIGINAL UNBROKEN CARTON OR REEL, PROPERLY TAGGED WITH U.L. LABEL, SIZE, TYPE, MANUFACTURER, TRADE NAME AND THE DATE OF MANUFACTURE. CONDUCTORS MUST BE MANUFACTURED WITHIN 6 MONTHS. PROVIDE COPPER CONDUCTORS #12 AWG MINIMUM UNLESS SPECIFICALLY NOTED OTHERWISE ON THE DRAWINGS. PROVIDE STRANDED COPPER CONDUCTORS FOR ALL WIRING. USE CONDUCTORS WITH THHN/THWN 600 VOLTS INSULATION, UNLESS OTHERWISE NOTED. <u>LIGHTING FIXTURES:</u>
PROVIDE LIGHTING FIXTURES WITH ELECTRONIC BALLASTS PER LIGHT FIXTURE SCHEDULE,
PROVIDE WITH LAMPS BY G.E., PHILLIPS, OR SYLVANIA AS STATED IN THE LIGHT FIXTURE

ANELBOARDS:
DISTRIBUTION AND LIGHTING PANELBOARDS WITHIN PROJECT AREA SHALL BE OF THE COPPER

BUS THREE PHASE, FOUR WIRE DISTRIBUTED PHASING TYPE. CIRCUITING SHALL BE ARRANGED TO PROVIDE, AS NEARLY AS POSSIBLE, AN EVENLY BALANCED LOAD ON ALL PHASES. PANELBOARDS SHALL BE BOLT-ON CIRCUIT BREAKER TYPE. AVAILABLE FAULT CURRENT IS STATED ON PANELBOARD SCHEDULE. PROVIDE PANEL IDENTIFICATION NAMEPLATE (ENGRAVED ON -ADHESIVE 1/2" MINIMUM LETTERS) AND TYPEWRITTEN LIST OF CIRCUITS IN THE DIRECTORY

STRUCTURAL SUPPORT:
EACH SECTION OF FLOOR MOUNTED SWITCHBOARD, DISTRIBUTION BOARD, MCC, ETC. SHALL BE BOLTED TO THE CONCRETE HOUSEKEEPING PAD USING (6) 3/4"-10 GRADE 2 BOLTS AND CONICAL WASHERS TORQUED TO 70LB-FT. PROVIDE MINIMUM 4000 PSI STRENGTH CONCRETE BELOW ALL FLOOR MOUNTED ELECTRICAL EQUIPMENT. THE THE TOP OF ALL FLOOR MOUNTED ELECTRICAL EQUIPMENT TO THE BUILDING STRUCTURE IN A SEISMICALLY APPROVED MANNER.

DEMOLITION:
NOTIFY THE OWNER IMMEDIATELY WHEREVER EXISTING EQUIPMENT IS ENCOUNTERED WHICH MUST BE RELOCATED DUE TO THE NEW CONSTRUCTION, AND WHICH IS NOT INDICATED ON THE PLANS. THE OWNER. DELIVER SUCH SALVAGED MATERIALS AND EQUIPMENT ON THE PREMISES AS DIRECTED BY THE OWNER, AND NEATLY PILE OR STORE THEM AND PROTECT FROM DAMAGE. REMOVE FROM PREMISES AND DISPOSE OF ALL MATERIALS CONSIDERED BY THE OWNER TO BE SCRAP.

2. ALL DEVICES, CIRCUIT CONDUCTORS, FEEDERS, ETC., WHEN NOTED TO BE REMOVED, SHALL BE REMOVED TO THE LAST ACTIVE DEVICE. ALL OVER-CURRENT PROTECTION AND DISCONNECT DEVICES NO LONGER UTILIZED BUT REMAINING AS LAST ACTIVE DEVICE SHALL BE LABELED AS "SPARE". COORDINATE ALL OUTAGES

CAREFULLY PROTECT ALL WALLS, TRIM, FLOORS, EQUIPMENT UTILITY LINES AND MATERIALS. WHEN WORKING ON FINISHED SURFACES, LIMIT DAMAGE TO THE CONFINES AS MUCH AS POSSIBLE AND RESTORE TO THE ORIGINAL CONDITION ALL SURFACES WHICH ARE DAMAGED BECAUSE OF THE INSTALLATION OF THE WORK 1.) EQUIPMENT, MATERIALS AND SUPPLIES REMOVED FOR PROTECTION SHALL BE REPLACED IN ORIGINAL

LOCATIONS. ANY MATERIALS DAMAGED SHALL BE REPLACED WITH NEW MATERIALS OF LIKE KIND AND QUALITY.

CALIFORNIA CODE OF REGULATIONS (C.C.R.), TITLE 24 (APPLIES AFTER JANUARY 1, 2017):

NFPA 20-STANDARD FOR THE INSTALLATION OF STATIONARY 2016 EDITION

NFPA 96-STANDARD FOR VENTILATION CONTROL AND FIRE 2017 EDITION

PROTECTION OF COMMERCIAL COOKING OPERATIONS

PART 1-CALIFORNIA BUILDINGS STANDARD ADMINISTRATIVE CODE 2016 EDITION

2017 EDITION

2016 EDITION

2017 EDITION

2016 EDITION

2016 EDITION

APPLICABLE CODES AND REGULATIONS

PART 2-CALIFORNIA BUILDING CODE

PART 3-CALIFORNIA ELECTRICAL CODE

PART 4-CALIFORNIA MECHANICAL CODE

PART 8-CALIFORNIA HISTORICAL BUILDING CODE

PART 10-CALIFORNIA EXISTING BUILDING CODE

NFPA 13-AUTOMATIC SPRINKLER SYSTEM,

PART 11-CALIFORNIA GREEN BUILDING STANDARDS CODE

PART 12-CALIFORNIA REFERENCE STANDARDS CODE

PUMPS FOR FIRE PROTECTION

NFPA 72-NAT. FIRE ALARM & SIGNALING CODE

NFPA 72-NATIONAL FIRE ALARM & SIGNALING CODE

(CALIFORNIA AMENDED)

PART 5-CALIFORNIA PLUMBING CODE

PART 6-CALIFORNIA ENERGY CODE

PART 7-NO LONGER PUBLISHED

PART 9-CALIFORNIA FIRE CODE

PARTIAL LIST OF NFPA STANDARDS:

NFPA 14-STANDPIPES SYSTEMS,

NFPA 24-PRIVATE FIRE MAINS.

NFPA 17A-WET CHEMICAL SYSTEMS,

NFPA 70-NATIONAL ELECTRICAL CODE

.) DO ALL DRILLING, CUTTING, CHANNELING AND PATCHING REQUIRED TO INSTALL ELECTRICAL WORK AS INDICATED OR HEREIN SPECIFIED. ALL HOLES, CURBS, ETC., IN FLOORS, CEILINGS AND WALLS SHALL BE PATCHED, UNLESS INDICATED OTHERWISE. PAINT ALL NEW ELECTRICAL RACEWAYS, CABINETS, ENCLOSURES, AND FITTINGS PENETRATING INTO FIRE RATED ENVELOPES, SPACES, ETC. 3.) ALL CONDUIT RUNS SHALL BE CONCEALED, UNLESS SHOWN OTHERWISE. PROVIDE A PULL WIRE IN ALL 4.) EXISTING CONDITION SHOWN IS FROM AVAILABLE RECORD DRAWINGS AND VISUAL FIELD SURVEY AND IS 5.) ALL WORK SHOWN IS NEW UNLESS SPECIFICALLY INDICATED AS EXISTING (X). ALL ELECTRICAL EQUIPMENT MOUNTING AND ANCHORAGE MUST CONFORM WITH LOCAL AND STATE SEISMIC CODES.

TELEPHONE SYSTEMS:
PROVIDE RACEWAYS, AND ALL MATERIAL INCLUDING PULLING CABLE IN EACH RACEWAY AS REQUIRED FOR THE GROUNDING AND BONDING:
FURNISH AND INSTALL COMPLETE BONDING AND GROUNDING SYSTEM AS REQUIRED BY CODES. CONTINUITY
OF GROUNDING SHALL BE MAINTAINED MECHANICALLY AND ELECTRICALLY THROUGHOUT THE SYSTEM. A GREEN GROUNDING CODE SIZED CONDUCTOR SHALL BE CARRIED THROUGH IN ALL CONDUITS.

IT IS THE INTENT OF THESE DRAWINGS AND SPECIFICATIONS THAT A COMPLETE AND WORKABLE ELECTRICAL INSTALLATION BE PROVIDED FOR ALL THE EQUIPMENT DESCRIBED OR SHOWN AS BEING IN THIS CONTRACT. TOWARD THIS END FURNISH ALL LABOR AND TOOLS NECESSARY AND FURNISH AND INSTALL ALL APPARATUS MATERIALS AND EQUIPMENT IN A FASHION COMPLYING WITH ALL APPLICABLE CODES, INCLUDING ITEMS REQUIRED BUT NOT NORMALLY SHOWN, SUCH AS LAMPS, COUPLINGS, HANGERS, BRACKETS, CLAMPS, BOXES, CONNECTORS, AND HARDWARE. REFER ALSO TO WRITTEN SPECIFICATIONS FOR GENERAL, MECHANICAL AND ELECTRICAL SECTIONS. .) PROCURE ALL PERMITS FROM LEGALLY CONSTITUTED AUTHORITIES, ARRANGE FOR ALL INSPECTIONS AND PAY ALL COSTS FOR FEES AND TESTS IN CONNECTION THEREWITH. COMPLY WITH CODES: NOTHING IN THESE

DRAWINGS AUTHORIZES DEVIATION FROM APPLICABLE CODES. 2.) DETERMINE EXACT ROUTING OF CONCEALED FEEDERS AND BRANCH CIRCUIT HOMERUNS IN COOPERATION WITH OTHER TRADES TO SIMPLIFY INSTALLATION WHEREVER POSSIBLE BUT SUBJECT TO APPROVAL OF ARCHITECT FOR VISUAL AND STRUCTURAL REASONS. 5.) PROVIDE A CODE APPROVED DISCONNECT SWITCH OR CIRCUIT BREAKER WITHIN SIGHT OF EVERY MOTOR

AND FEED MOTORS NOT EQUIPPED WITH "BUILT IN" PROTECTION THROUGH A MAGNETIC OR MANUAL STARTER WITH OVERLOAD HEATERS SIZED TO COMPLY WITH MOTOR MANUFACTURER'S RECOMMENDATIONS AND 4.) FOR CONNECTIONS TO EXHAUST FANS, PUMPS, COMPRESSORS, SPACE HEATERS, WATER HEATERS, AQUASTATS, SOLENOID VALVES, AND OTHER MECHANICAL EQUIPMENT AND FOR CONDUITS AND WIRE REQUIRED BUT NOT NECESSARILY SHOWN ON THESE DRAWINGS, REFER TO MECHANICAL PLANS AND DETERMINE EXACT

5.) DO NOT RUN ANY CONDUIT IN SLAB IF ITS OUTSIDE DIAMETER EXCEEDS 1/3 THE THICKNESS OF THE SLAB. LOCATE CONDUITS WITHIN THE MIDDLE OF THE SLAB. WHERE CONDUITS ARE GROUPED IN PARALLEL RUNS, SPACE THEM 3" OR MORE APART. WHERE CONDUITS CROSS EACH OTHER, THICKEN THE SLAB PROPORTIONATELY OVER A HORIZONTAL AREA EQUAL TO TEN TIMES THE DIAMETER OF THE LARGEST CONDUIT.

6.) FOR CIRCUITS FED THROUGH FLUORESCENT FIXTURE CHANNELS AND FEEDS TO RECESSED INCANDESCENT

FIXTURES USE INSULATED WIRE OF 105 DEGREES CELSIUS RATING. 7.) SIZE OUTLET BOXES IN CONFORMITY WITH CODE FOR NUMBER AND GUAGE OF CONDUCTORS THEREIN. EXCEPT WHERE NOTED TO BE LARGER. MINIMUM BOX SIZE SHALL BE 4" SQUARE BY 1-1/2" DEEP. 8.) EXAMINE PLANS TO DISCERN CEILINGS WITH A FIRE RATING OF ONE HOUR OR MORE, PROVIDE A ONE 9.) ALL ELECTRICAL WORK SHALL BE INSTALLED SO AS TO BE READILY ACCESSIBLE FOR OPERATING, SERVICING, MAINTAINING AND REPAIRING. ALL CONDUIT SHALL BE CONCEALED WHERE POSSIBLE. EXPOSED CONDUIT SHALL BE IN STRAIGHT LINES PARALLEL WITH, OR AT RIGHT ANGLES TO, COLUMN LINES OR BEAMS AND SEPARATED BY AT LEAST THREE (3) INCHES FROM WATER LINES WHENEVER THEY RUN ALONG SIDE OR ACROSS SUCH LINES. CONDUIT SHALL NOT BE RUN BELOW CABLE TRAYS OR LIGHT FIXTURES WITHOUT

SPECIFIC APPROVAL OF THE OWNER'S REPRESENTATIVE. HANGERS SHALL BE FASTENED TO STEEL, CONCRETE OR MASONRY, BUT NOT TO PIPING. HANGERS AND SUPPORT SYSTEMS ARE AN INTEGRAL PART OF THE

VISUAL ENVIRONMENT. ALL HANGERS AND SUPPORTS EXPOSED TO PUBLIC VIEW MUST BE SHOWN IN DETAIL

ON PLANS SUBMITTED TO LANDLORD FOR APPROVAL OF APPEARANCE. ALL HANGERS MUST BE UNIFORMLY FUNCTION. CONTRACTOR SHALL SELECT ACCESSORIES AND HARDWARE WITH A SMOOTH, NEAT FINISHED APPEARANCE AND PAINT ALL EXPOSED CONDUIT HANGERS TO MATCH THE ADJACENT FINISHES. 10.) ALL WALL SWITCHES AND RECEPTACLES SHALL BE MOUNTED BETWEEN 18" AND 48" PER A.D.A. OR AREA TO CONTROL LIGHTING AND RECEPTACLE OUTLETS, APPLIANCES OR COOLING, HEATING AND VENTILATING EQUIPMENT, SHALL BE LOCATED NO MORE THAN 48" MEASURED FROM THE TOP OF OUTLET BOX NOR LESS THAN 15" MEASURED FROM THE BOTTOM OF THE OUTLET BOX TO THE LEVEL OF THE FINISHED

FROM THE BOTTOM OF THE RECEPTACLE OUTLET BOX OR RECEPTACLE HOUSING TO THE LEVEL OF THE FINISHED FLOOR OR WORKING PLATFORM. 11.) ALL DISTRIBUTION BOARDS, SWITCHBOARDS AND TRANSFORMERS THAT ARE FLOOR MOUNTED SHALL BE MOUNTED ON 4" THICK HOUSEKEEPING PAD. TRANSFORMER SHALL BE ON VIBRATION ISOLATION PADS AND CONNECTED WITH FLEXIBLE CONDUIT.

ELECTRICAL RECEPTACLE OUTLETS: ELECTRICAL RECEPTACLE OUTLETS ON BRANCH CIRCUITS OF 30 AMPERES

FROM THE TOP OF THE RECEPTACLE OUTLET BOX OR RECEPTACLE HOUSING NOR LESS THAN 15" MEASURED

OR LESS AND COMMUNICATION SYSTEM RECEPTACLES, SHALL BE LOCATED NO MORE THAN 48" MEASURED

12.) CONTRACTOR SHALL EXAMINE PLANS AND VERIFY IN FIELD LOCATIONS OF ALL FIRE RATED WALLS, CEILINGS AND FLOORS. CONTRACTOR SHALL SEAL ALL ELECTRICAL SYSTEM PENETRATIONS THROUGH FIRE RATED WALLS, CEILINGS AND FLOORS WITH U.L. LISTED MATERIAL APPROVED BY THE AUTHORITY HAVING

13.) SURFACE MOUNTED RACEWAY COMPLETENESS: CONTRACTOR SHALL PROVIDE ALL RACEWAY, FITTINGS, SUPPORTS, BOXES, DEVICES, PLATES ETC. NECESSARY FOR A COMPLETE AND WORKABLE SURFACE MOUNTED ELECTRICAL RACEWAY SYSTEM. PRIOR TO INSTALLATION, CONTRACTOR SHALL PERFORM A PRE-INSTALLATION SURFACE MOUNTED RACEWAY JOB WALK WITH OWNER & ARCHITECT FOR CONTRACTOR TO FIELD VERIFY EXACT ROUTING OF ANY & ALL SURFACE MOUNTED RACEWAYS.

ELECTRICAL SYSTEM ANCHORAGE:
ALL ELECTRICAL EQUIPMENT SHALL BE BRACED OR SEISMICALLY ANCHORED BY THE CONTRACTOR TO RESIST SEISMIC FORCES ACTING IN ANY DIRECTION. PROVIDE COMPLETE SEISMIC ANCHORAGE AND BRACING FOR SUPPORT OF ELECTRICAL RACEWAYS, CONDUITS, CABLE TRAYS, ELECTRICAL EQUIPMENT, ETC. IN ACCORDANCE WITH THE UNIFORM BUILDING CODE WITH CALIFORNIA AMENDMENTS. THE SEISMIC BRACING AND ANCHORAGE SHALL BE PROVIDED PER THE LATEST EDITION OF THE SMACNA SEISMIC RESTRAINT GUIDELINES. ALL ELECTRICAL SYSTEMS SHALL BE INSTALLED IN ACCORDANCE WITH THE LATEST EDITION OF SMACNA GUIDELINES. WHERE BRACING DETAILS ARE NOT SHOWN ON THE PLANS, THE FIELD INSTALLATIONS SHALL BE SUBJECT TO THE APPROVAL OF THE ENGINEERS, AND THE ARCHITECT. A COPY OF LATEST SMACNA GUIDELINES SHALL BE KEPT AT THE JOB SITE AT ALL TIMES.

FIRE ALARM SYSTEM (DESIGN-BUILD) BY CONTRACTOR
CONTRACTOR SHALL FURNISH AND INSTALL A FIRE ALARM SYSTEM FOR THE PROJECT AREA TO INCLUDE:

A.) SMOKE DETECTORS IN ALL REQUIRED AREAS B.) HEAT DETECTORS IN ALL REQUIRED AREAS .) DUCT DETECTORS IN ALL REQUIRED SPACES) STROBES/ALARMS IN ALL REQUIRED AREAS

E.) PULL STATIONS AT ALL LEGAL FIRE EXITS — WHERE REQUIRED
F.) TAMPER AND FLOW SWITCHES AT FIRE SPRINKLER RISERS AND BACKFLOW PREVENTERS G.) BRANCH CIRCUIT AND CONTROL WIRING TO FIRE SPRINKLER ALARM BELLS I.) SMOKE/FIRE DAMPER/HVAC UNIT SHUT—DOWN BRANCH CIRCUIT WIRING, CONTROL WIRING, CONTROL

1. CONTRACTOR SHALL SUBMIT FOR THE OWNER'S SIGNED APPROVAL, APPROVED FIRE DEPARTMENT FIRE ALARM DRAWINGS FOR THE PROJECT SPACE. 2. ALL DEVICES AND EQUIPMENT SHALL BE CALIFORNIA STATE FIRE MARSHAL APPROVED. CONTRACTOR SHALL WARRANTY ALL DEVICES AND SYSTEMS FOR A PERIOD OF TWO YEARS. 4. CONTRACTOR SHALL PROVIDE SIX (6) SETS OF FIRE ALARM MANUALS FOR ALL SYSTEMS AND DEVICES IN ADDITION TO SIX (6) SETS OF A SYSTEM OPERATIONAL MANUAL TAILORED FOR THE PROJECT SPACE.


5. CONTRACTOR SHALL PROVIDE AN INDIVIDUALLY ADDRESSABLE, TOTALLY SUPERVISED SYSTEM WITH BATTERY BACK-UP FOR 24 HOURS OF MONITORING INITIATING CIRCUITS PLUS 30 MINUTES OF ALARM WITH 5. CONTRACTOR SHALL PROVIDE A SATISFACTORY TEST IN THE PRESENCE OF THE OWNER, FIRE PREVENTION 7. CONTRACTOR SHALL PROVIDE A CENTRAL MASTER ANNUNCIATOR PANEL IN THE ELECTRICAL ROOM PER

8. CONTRACTOR SHALL PROVIDE ALL CONNECTION TO POWER PANELS, CONDUIT AND WIRE AND CONNECTIONS REQUIRED TO PROVIDE AN OPERATIONAL PR-EACTION FIRE CONTROL SYSTEM AND CONNECTIONS TO BUILDING FIRE ALARM EVACUATION SYSTEM.

SUBMITTAL DOCUMENTS FOR DEFERRED ITEMS SHALL BE SUBMITTED TO THE REGISTERED DESIGN PROFESSIONAL IN RESPONSIBLE CHARGE, WHO SHALL REVIEW THEM AND FORWARD THEM TO THE BUILDING OFFICIAL WITH A NOTATION INDICATING THAT THEY HAVE BEEN FOUND TO BE IN GENERAL CONFORMANCE WITH DESIGN OF THE BUILDING. THE DEFERRED ITEMS SHALL NOT BE INSTALLED UNTIL THEIR DESIGN AND

ELECTRICAL SYMBOL LIST

DIMENSIONS INDICATED ARE MEASURED TO CENTERLINE OF ENCLOSURE, UNLESS OTHERWISE NOTED NOTE: SOME SYMBOLS SHOWN MAY NOT APPLY TO THIS PROJECT

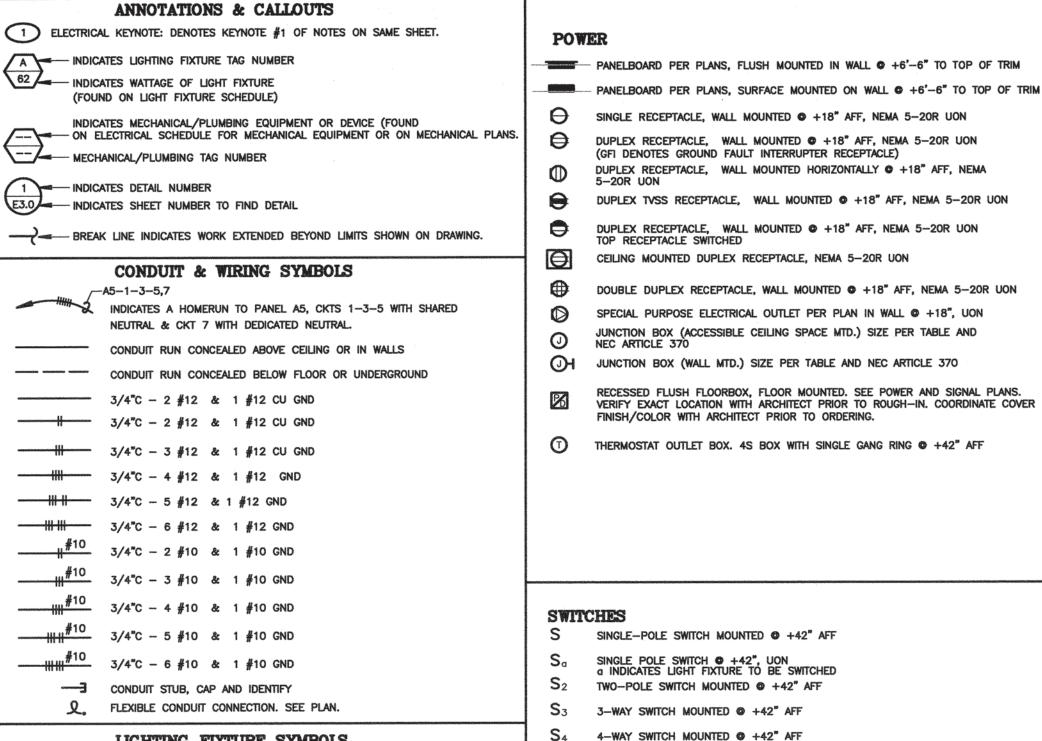

	LIGHTING	FIXTURE	SYMBOLS			
Company of	2'X4' CEILING M	IOUNTED FLUOR	RESCENT LIGHT	FIXTURE	W/OUTLET	вох

(RECESSED, SURFACE MOUNTED) a & b, ETC. INDICATES SWITCH IDENTIFICATION NUMBER INDICATES LIGHT FIXTURE BRANCH CIRCUIT

2'X2' CEILING MOUNTED FLUORESCENT LIGHT FIXTURE W/OUTLET BOX (RECESSED, SURFACE MOUNTED) O CEILING MOUNTED FLUORESCENT LIGHTING FIXTURE WITH 4S OUTLET BOX RECESSED, SURFACE MOUNTED) FLUORESCENT LIGHT FIXTURE WITH INTEGRAL 90 MINUTE EMERGENCY BATTER PACK WITH 4S OUTLET BOX. (RECESSED, SURFACE MOUNTED)

SURFACE MOUNTED FLUORESCENT STRIP LIGHTING FIXTURE WITH 4S BOX CEILING SURFACE MOUNTED LIGHTING FIXTURE WITH OUTLET BOX CEILING RECESSED DOWNLIGHT FIXTURE

TRACK LIGHTING (TRIANGLES INDICATE # OF HEADS) LIGHT FIXTURE, WALL MOUNTED WITH OUTLET BOX

CEILING RECESSED WALL WASH DOWNLIGHT FIXTURE

EXIT SIGN WITH OUTLET BOX -ARROW DENOTES DIRECTIONAL CHEVRON EXIT SIGN, END MOUNT ON WALL, WITH OUTLET BOX.

VOICE/DATA SYSTEM

-SHADING DENOTES FACE OF EXIT SIGN. EMERGENCY LIGHTING UNIT WITH OUTLET BOX.

EXIT-EMERGENCY LIGHTING UNIT COMBO WITH OUTLET BOX. PENDANT MOUNTED LIGHT FIXTURE WITH OUTLET BOX.

FIRE ALARM SYMBOLS

SK KEYED SWITCH MOUNTED @ +42" AFF

S_M HORSEPOWER RATED SWITCH MOUNTED ♥ +42" AFF

Sp single-pole switch (with pilot light) • +42" Aff

CS CHELSEA DIGITAL WALL SWITCH MOUNTED @ +42" AFF

PUSH BUTTON WALL SWITCH MOUNTED 9 +42" AFF

150 AMP TRIP RATING, 3-POLE

100A UTILITY METER (OR AS NOTED)

WITH OVERCURRENT PROTECTION UON

60AS DISCONNECT SWITCH, 60AMP SWITCH, 35 AMP FUSES, 3—POLE WITH OVERCLIRRENT PROTECTION 1001

EXHAUST FAN/MOTOR, SIZE AS INDICATED ON PLANS

COMBINATION STARTER / DISCONNECT SWITCH SIZED PER PLAN

CIRCUIT BREAKERS AND FUSES

DIMMER SWITCH MOUNTED @ +42" AFF, 0-10V DIMMER COMPATIBLE WITH LED LIGHT FIXTURE, UON.

SO OCCUPANCY SENSOR WALL SWITCH PER PLANS, MOUNTED +42" AFF

TIME SWITCH, FLUSH MOUNTED @ +42" AFF. WATTSTOPPER, TS-400-W

MOLDED CASE CIRCUIT BREAKER 225 AMP FRAME,

FUSED SWITCH, 100 AMP SWITCH RATING WITH 60 AMP FUSES, 3-POLE

CEILING MOUNTED OCCUPANCY SENSOR COMPLETE WITH OUTLET BOX, PER PLANS

(3) NUMBER INDICATES NUMBER OF CABLES TERMINATED & NUMBER OF DATA JACKS REQUIRED. WALL DATA OUTLET AT +18" AFF. PROVIDE HUBBELL WHITE RJ-45 JACKS & WHITE FACEPLATE WITH BLUE CAT6E CABLES ROUTED TO IDF PATCH PANEL & TERMINATED. PROVIDE 1"CO TO ACCESSIBLE CEILING SPACE WITH BUSHING.

TELE/DATA OUTLET BOX IN WALL @ +18", STUB A 1" CO UP 12" ABOVE

TELE/DATA OUTLET BOX, MOUNTED IN WALL +6" ABOVE COUNTER OR SPLASH STUB A 1" CO UP 12" ABOVE ACCESSIBLE CEILING WITH BUSHING, 5S BOX

FLUSH CEILING MOUNT PLASTER RING, UON FLUSH CEILING MOUNTED TELE/DATA OUTLET, 5S BOX WITH SINGLE GANG TELEVISION OUTLET IN WALL @ +84", 5S BOX WITH 1-GANG RING, UON

CEILING SPEAKER-RAULAND, #ACC1401 W/#ACC1000 BAFFLE. PROVIDE BACKBOX & CEILING SUPPORT, AS REQUIRED. PROVIDE CAT 50 YELLOW

SURFACE, #P875X FOR RECESS) BACK BOX W/SQLK GRILL. PROVIDE CAT5e YELLOW CABLE TO 66 BLOCK & TERMINATE. EXTERIOR WALL MOUNT SECURITY CAMERA. ROUGH—IN DATA JACK & MOUNTING BACKBOX. PROVIDE ONE CAT6A CABLE & TERMINATE AT IDF PATCH PANEL.

SWP OUTDOOR SPEAKER-ATLAS #APF15 HORN W/XFMR & LOWELL (#CB84 FOR

FIRE ALARM CONTROL PANEL

SMOKE DETECTOR W/ BASE F PULL STATION

WALL MOUNT STROBE WALL MOUNT HORN/STROBE

DUCT DETECTOR CEILING MOUNT SPEAKER/STROBE

CEILING MOUNT STROBE HD HEAT DETECTOR W/ BASE

₹ END-OF-LINE RESISTOR

HORN WITH WEATHERPROOF ENCLOSURE

M MINI-HORN WALL MOUNT SPEAKER/STROBE OUTDOOR WALL MOUNT SPEAKER

SHEET NUMBER

OPSC or OSHPD PROJ. NO:

PROJECT NO

DRAWN BY:

CHK'D BY:

ISSUE DATE:

SHEET TITLE

AGENCY INFORMATION:

AGENCY TRACKING NO. __63321-355

IDENTIFICATION STAMP

DIV. OF THE STATE ARCHITECT OFFICE OF REGULATION SERVICES

FLS SPH SS

DATE SEP 3 0 2019

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BAKERSFIELD CITY SCHOOL

BESSIE OWENS E.S. TEMPORARY

MODULAR BUILDINGS

118932

V.Z.

D.F.

SYMBOLS, GENERAL NOTES,

ABBREVIATIONS


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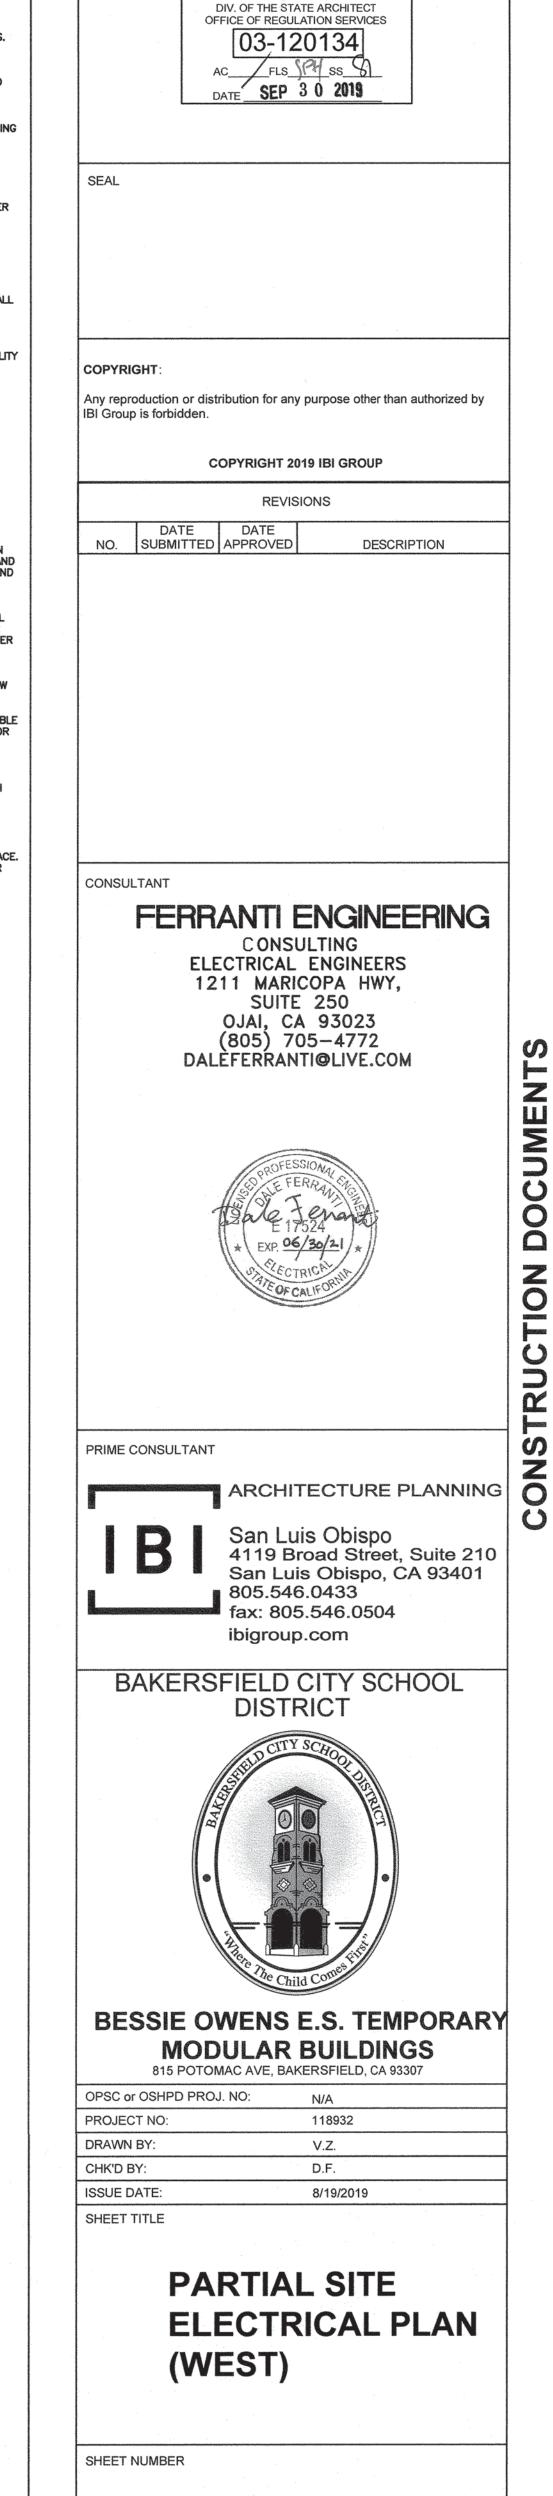
OJAI, CA 93023


NO. SUBMITTED APPROVED

CONSULTANT

PRIME CONSULTANT



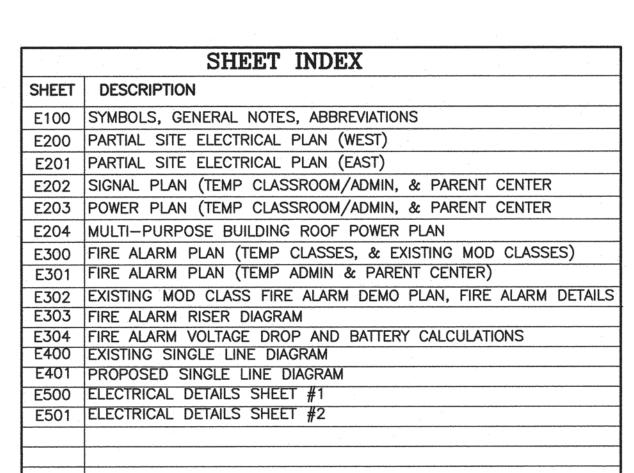

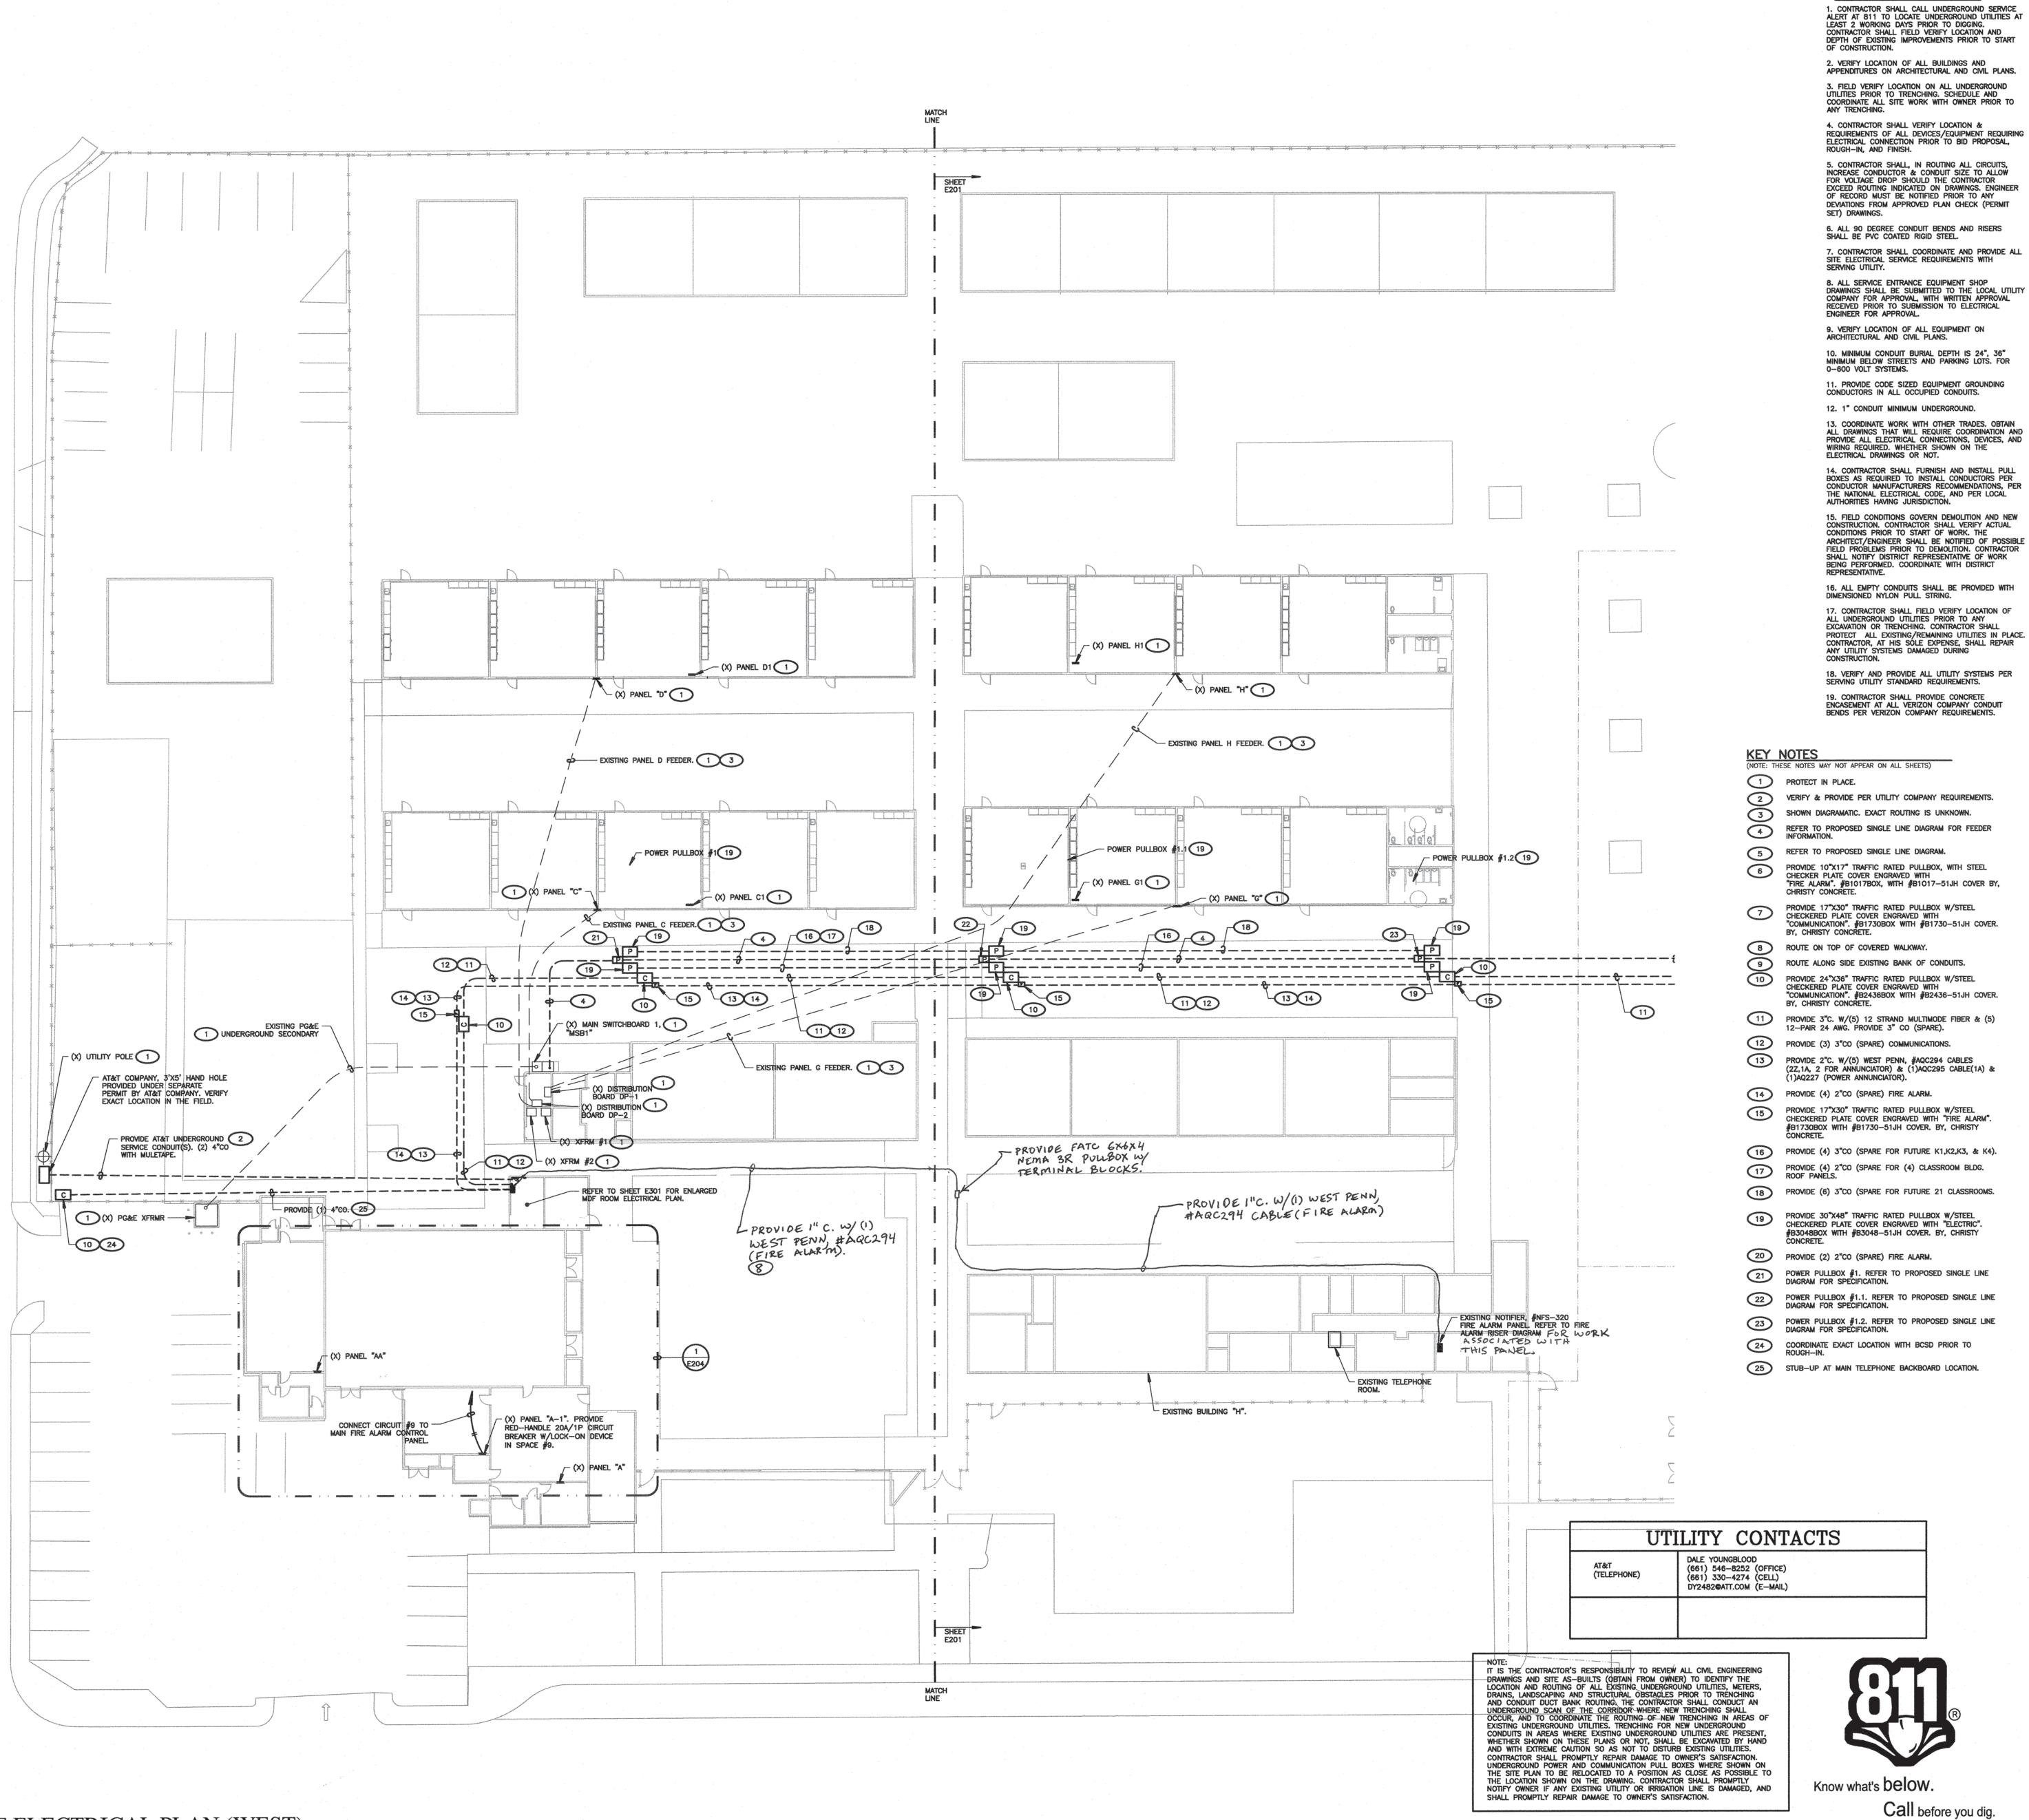

PARTIAL SITE ELECTRICAL PLAN (WEST)


SCALE: I" = 20'-0"


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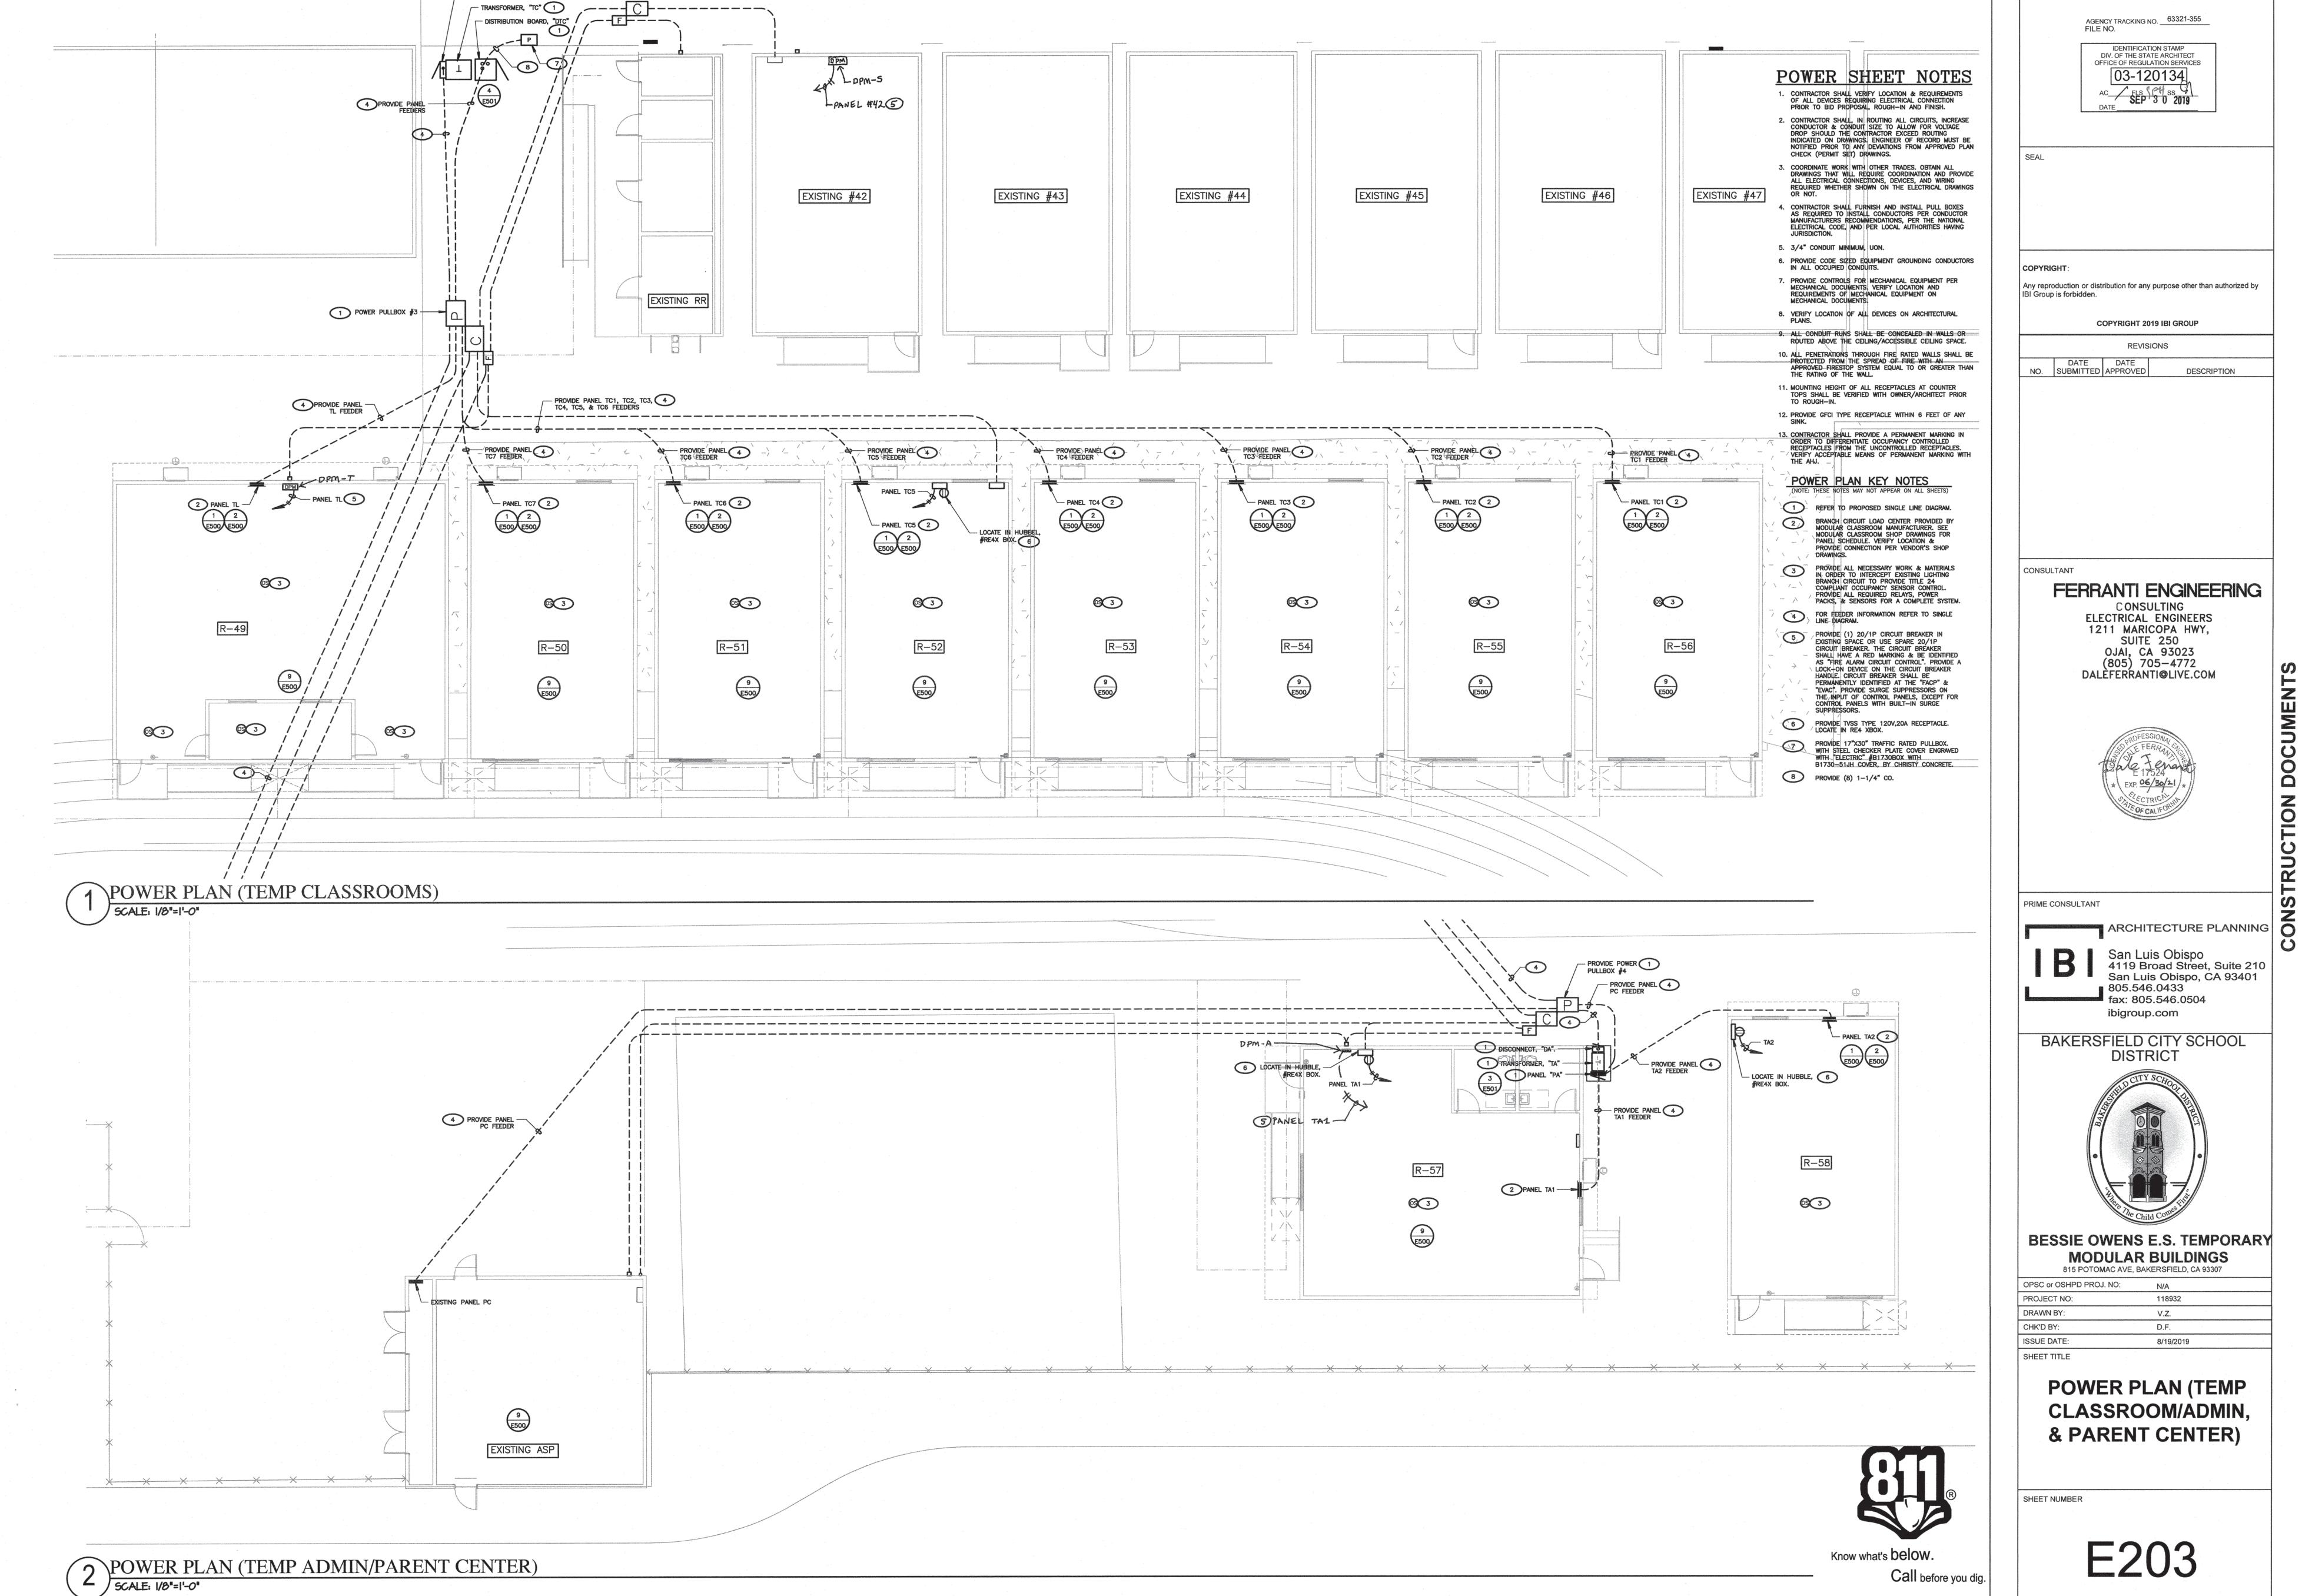
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SHEET NOTES





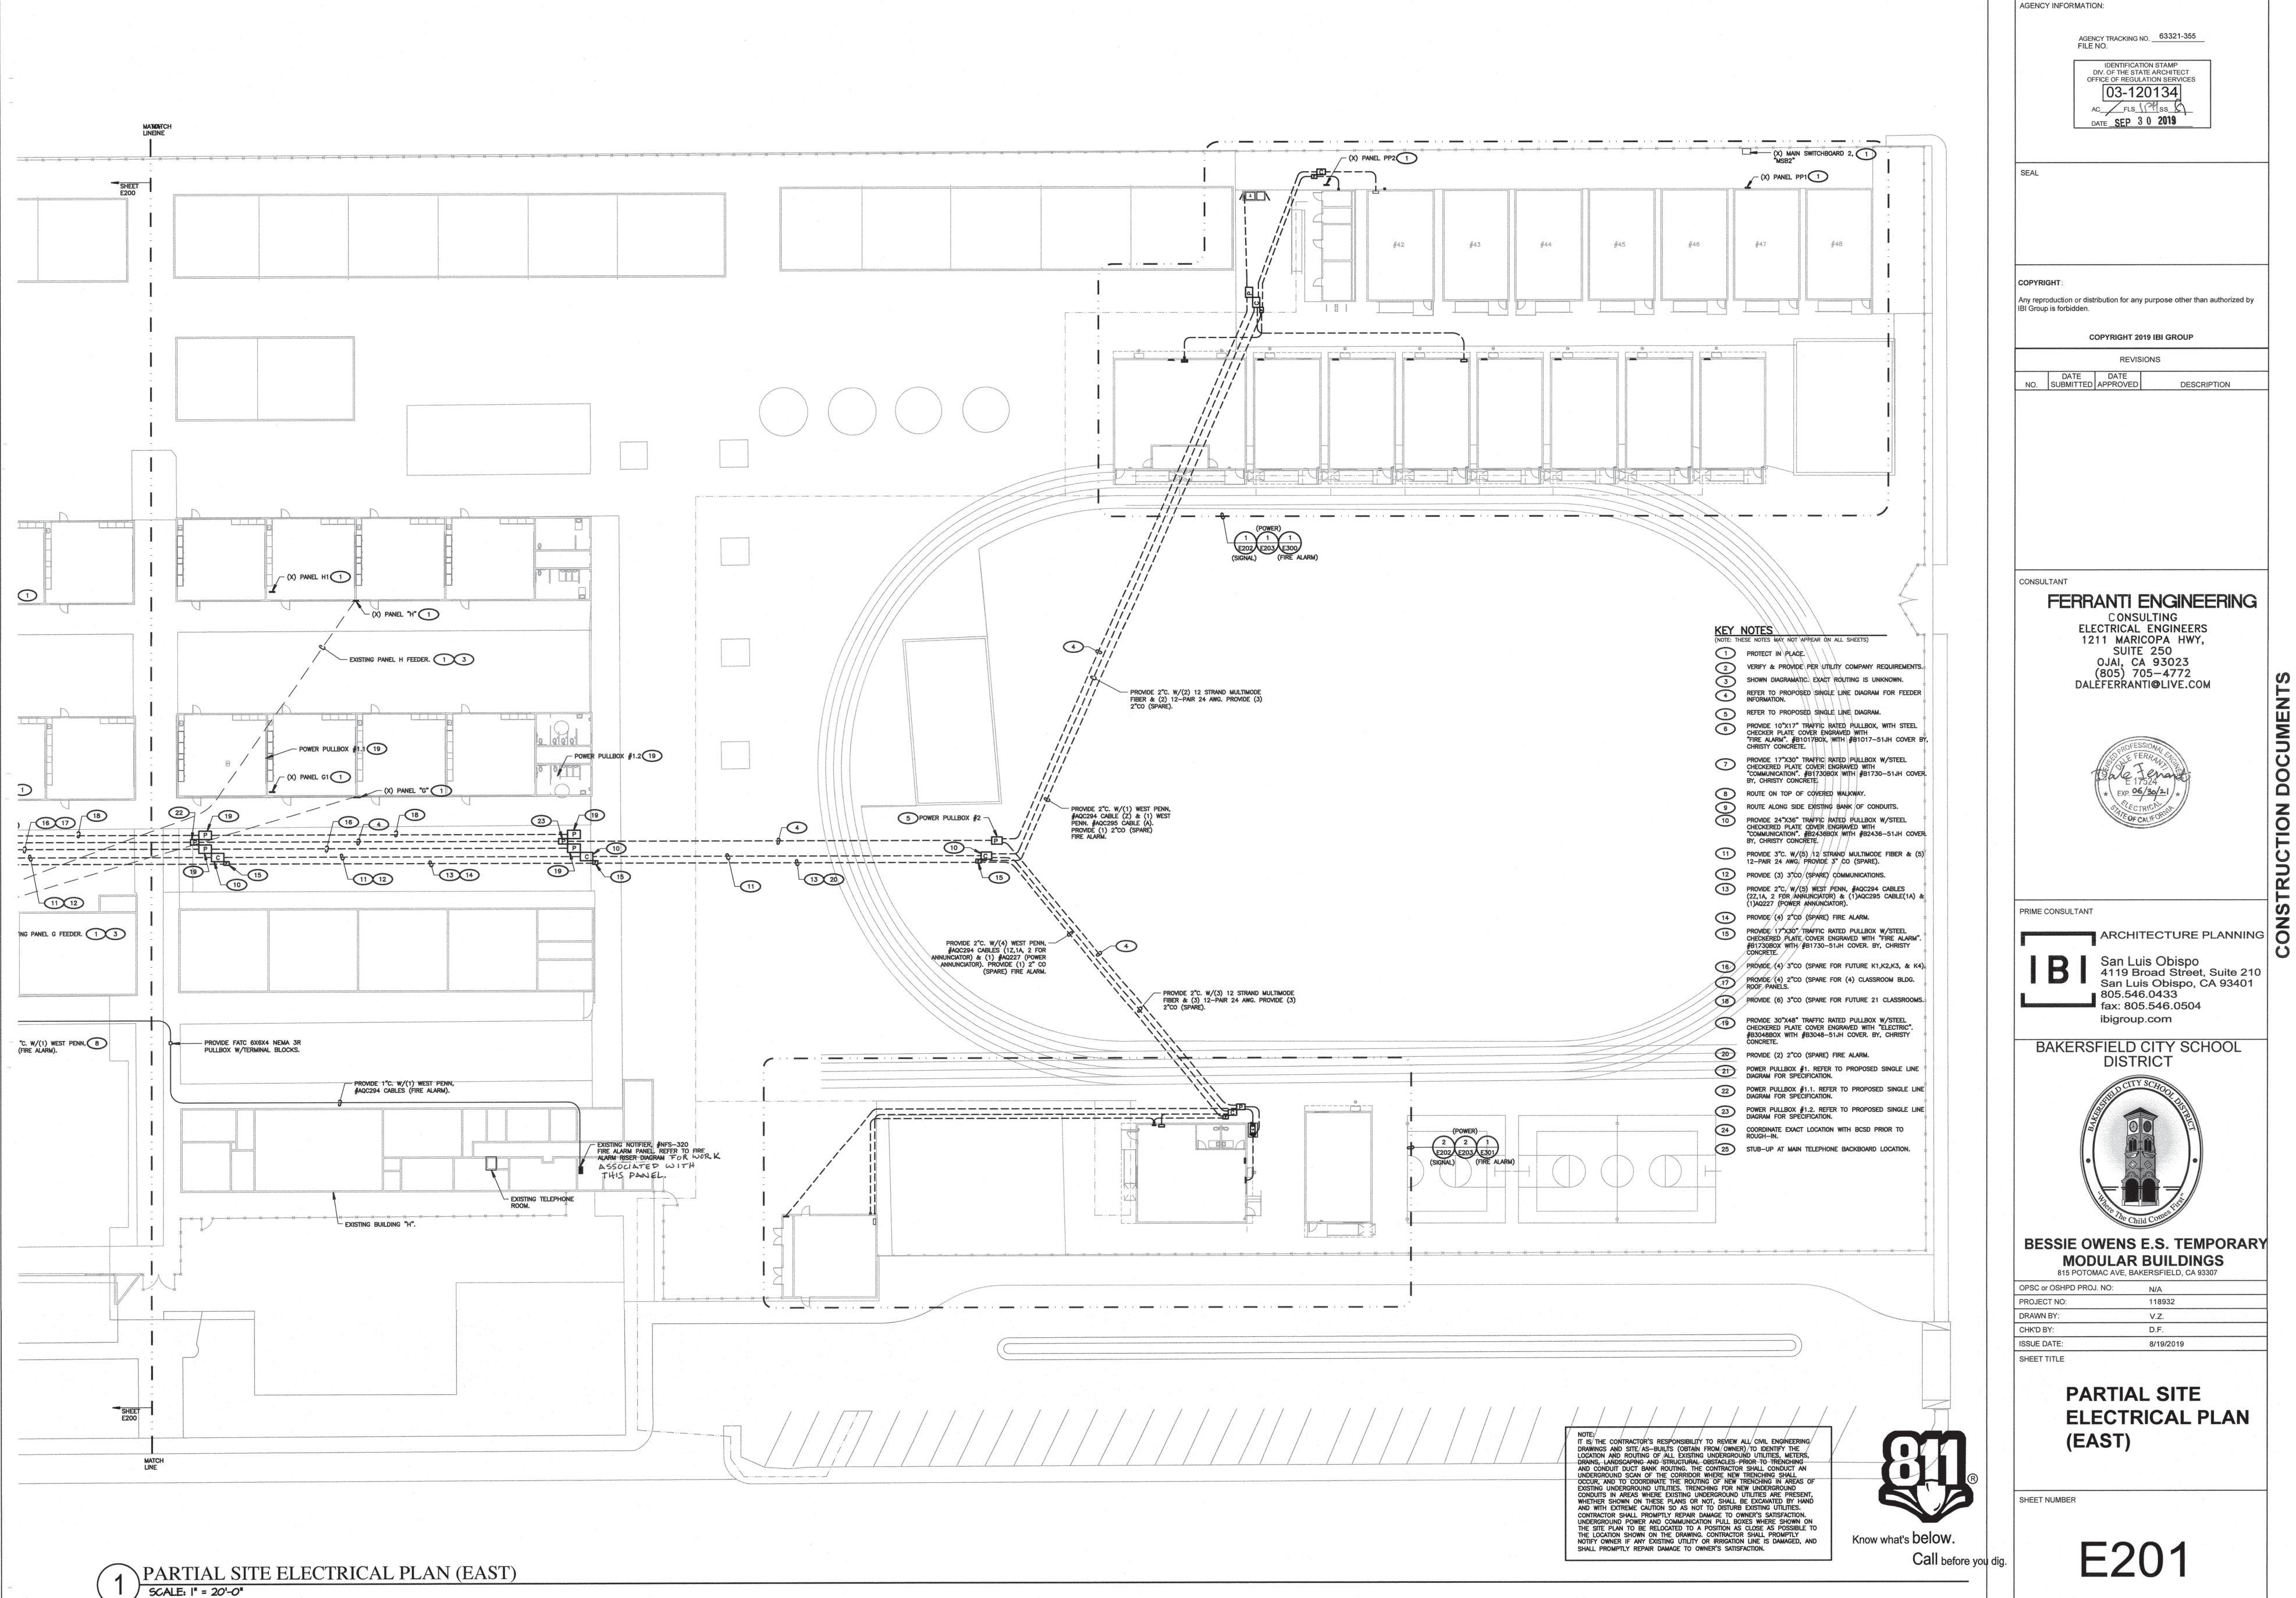

- DISCONNECT, "DC"
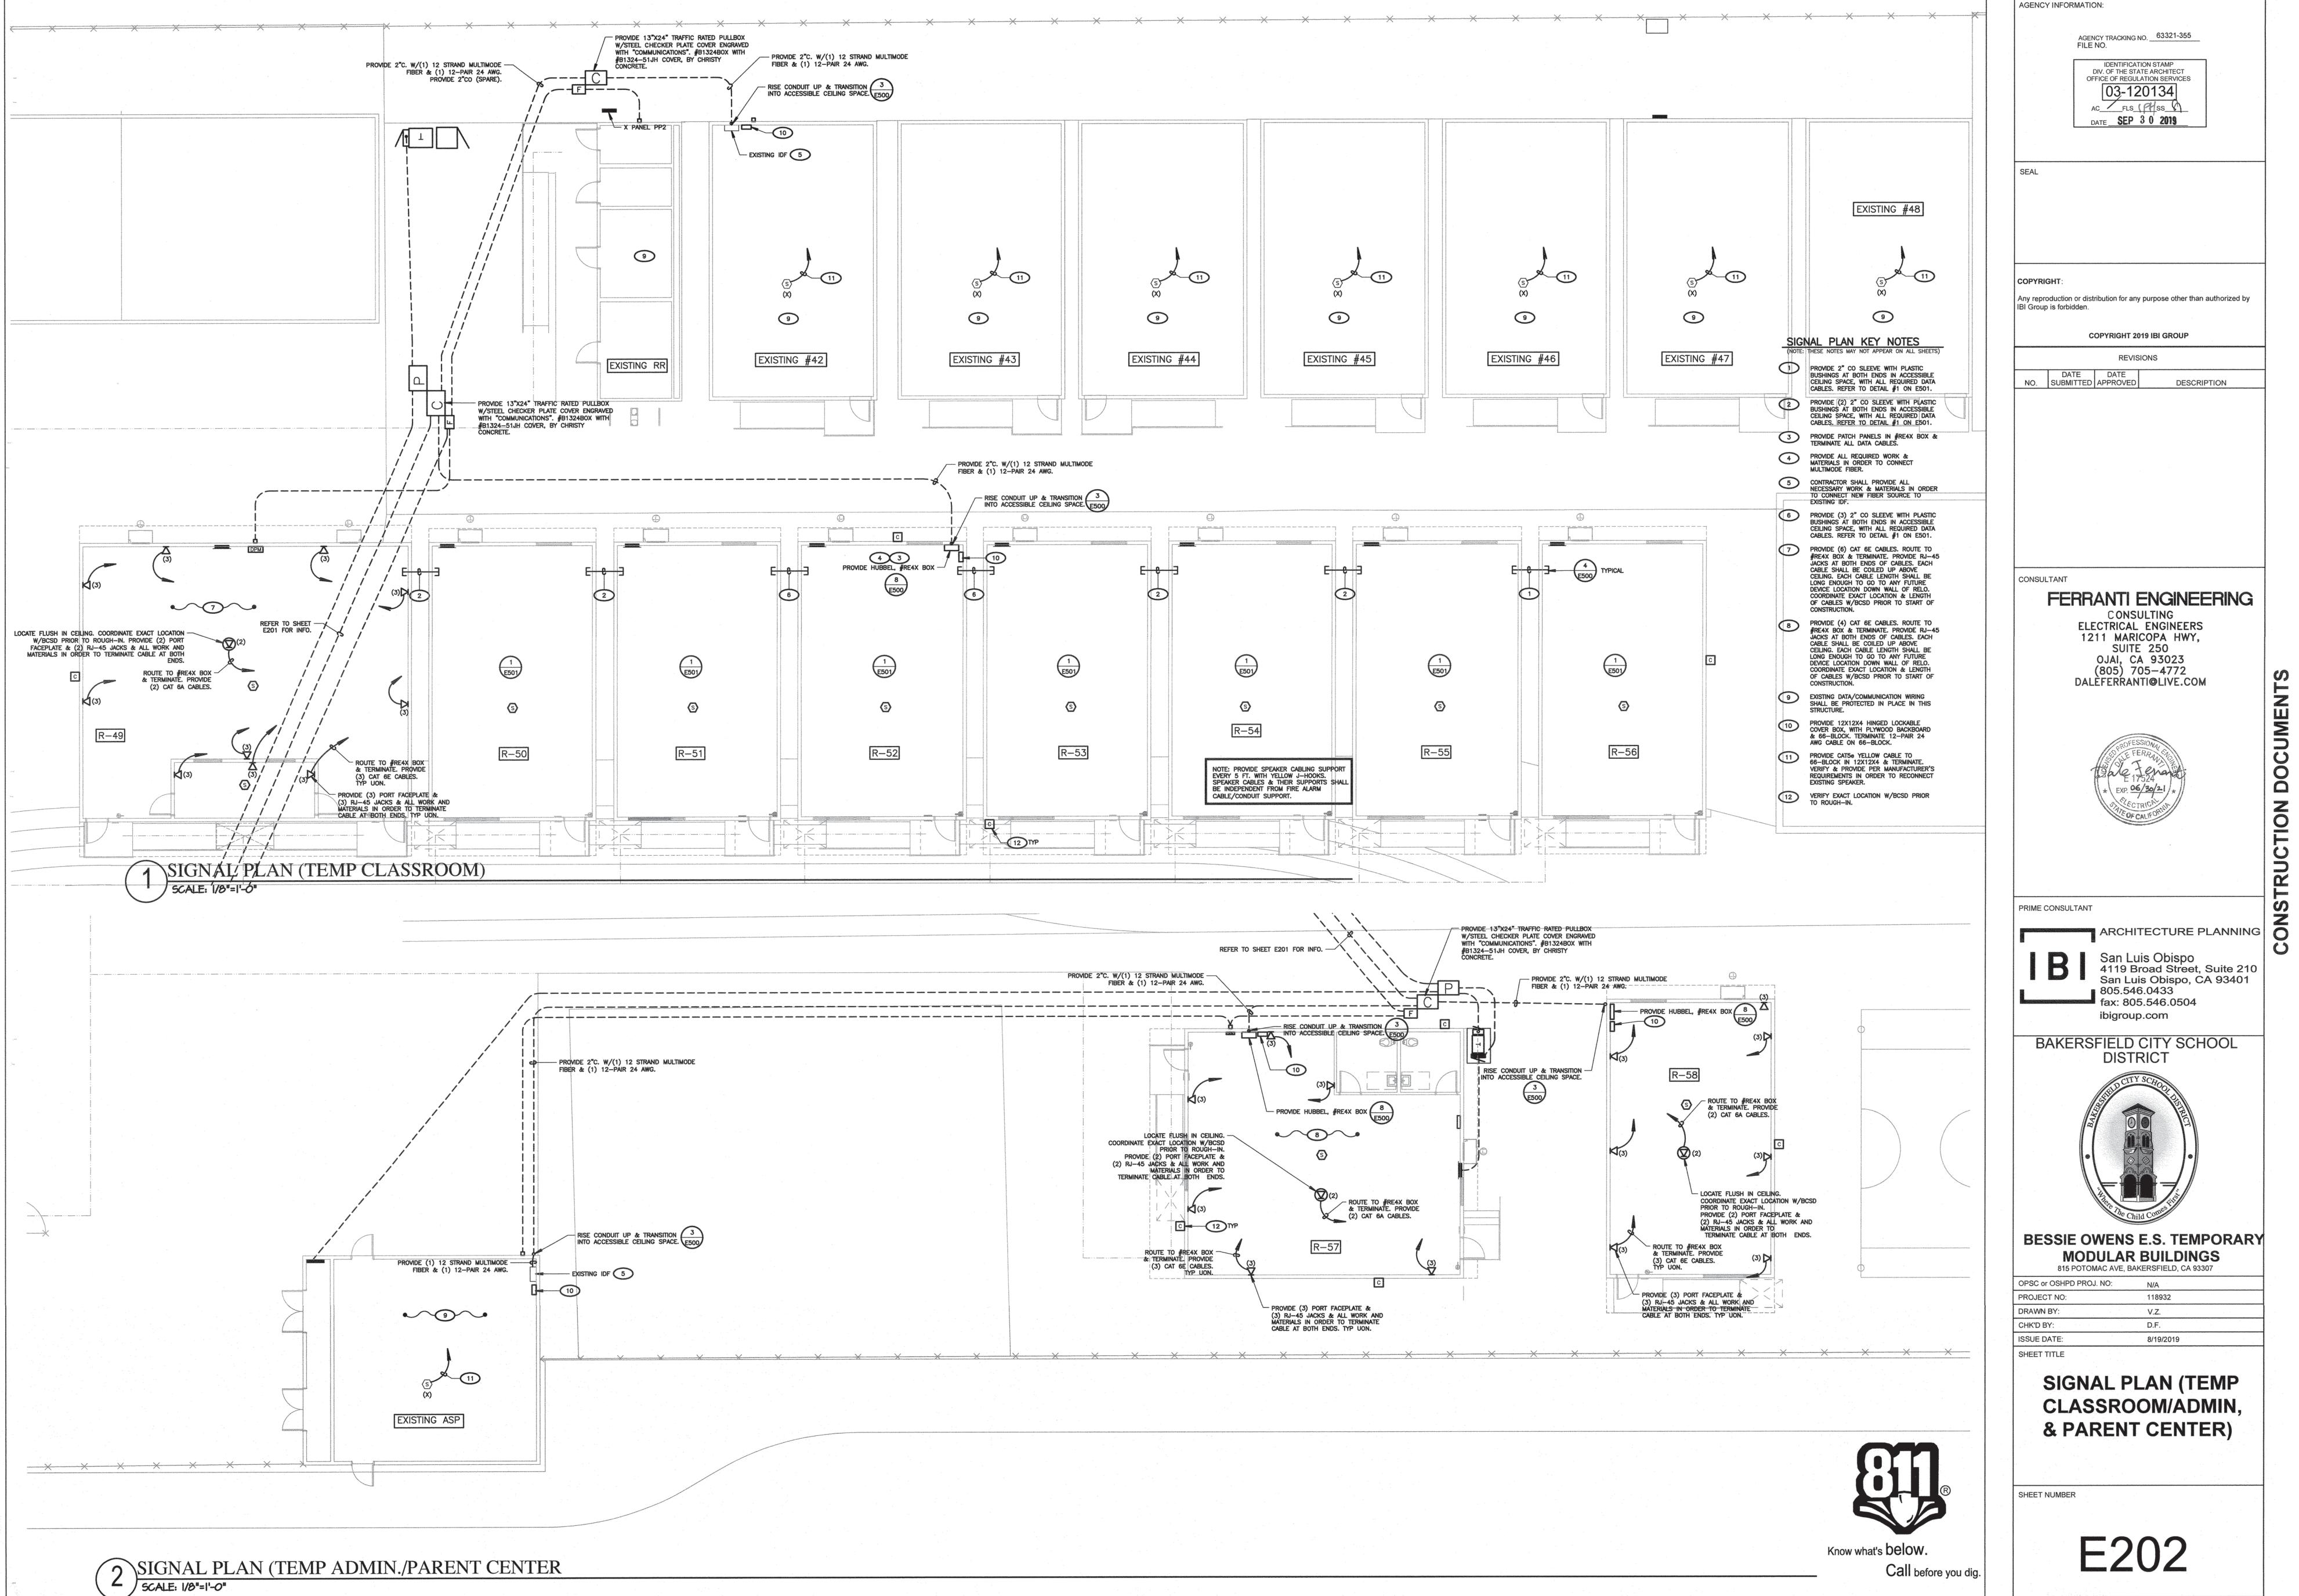
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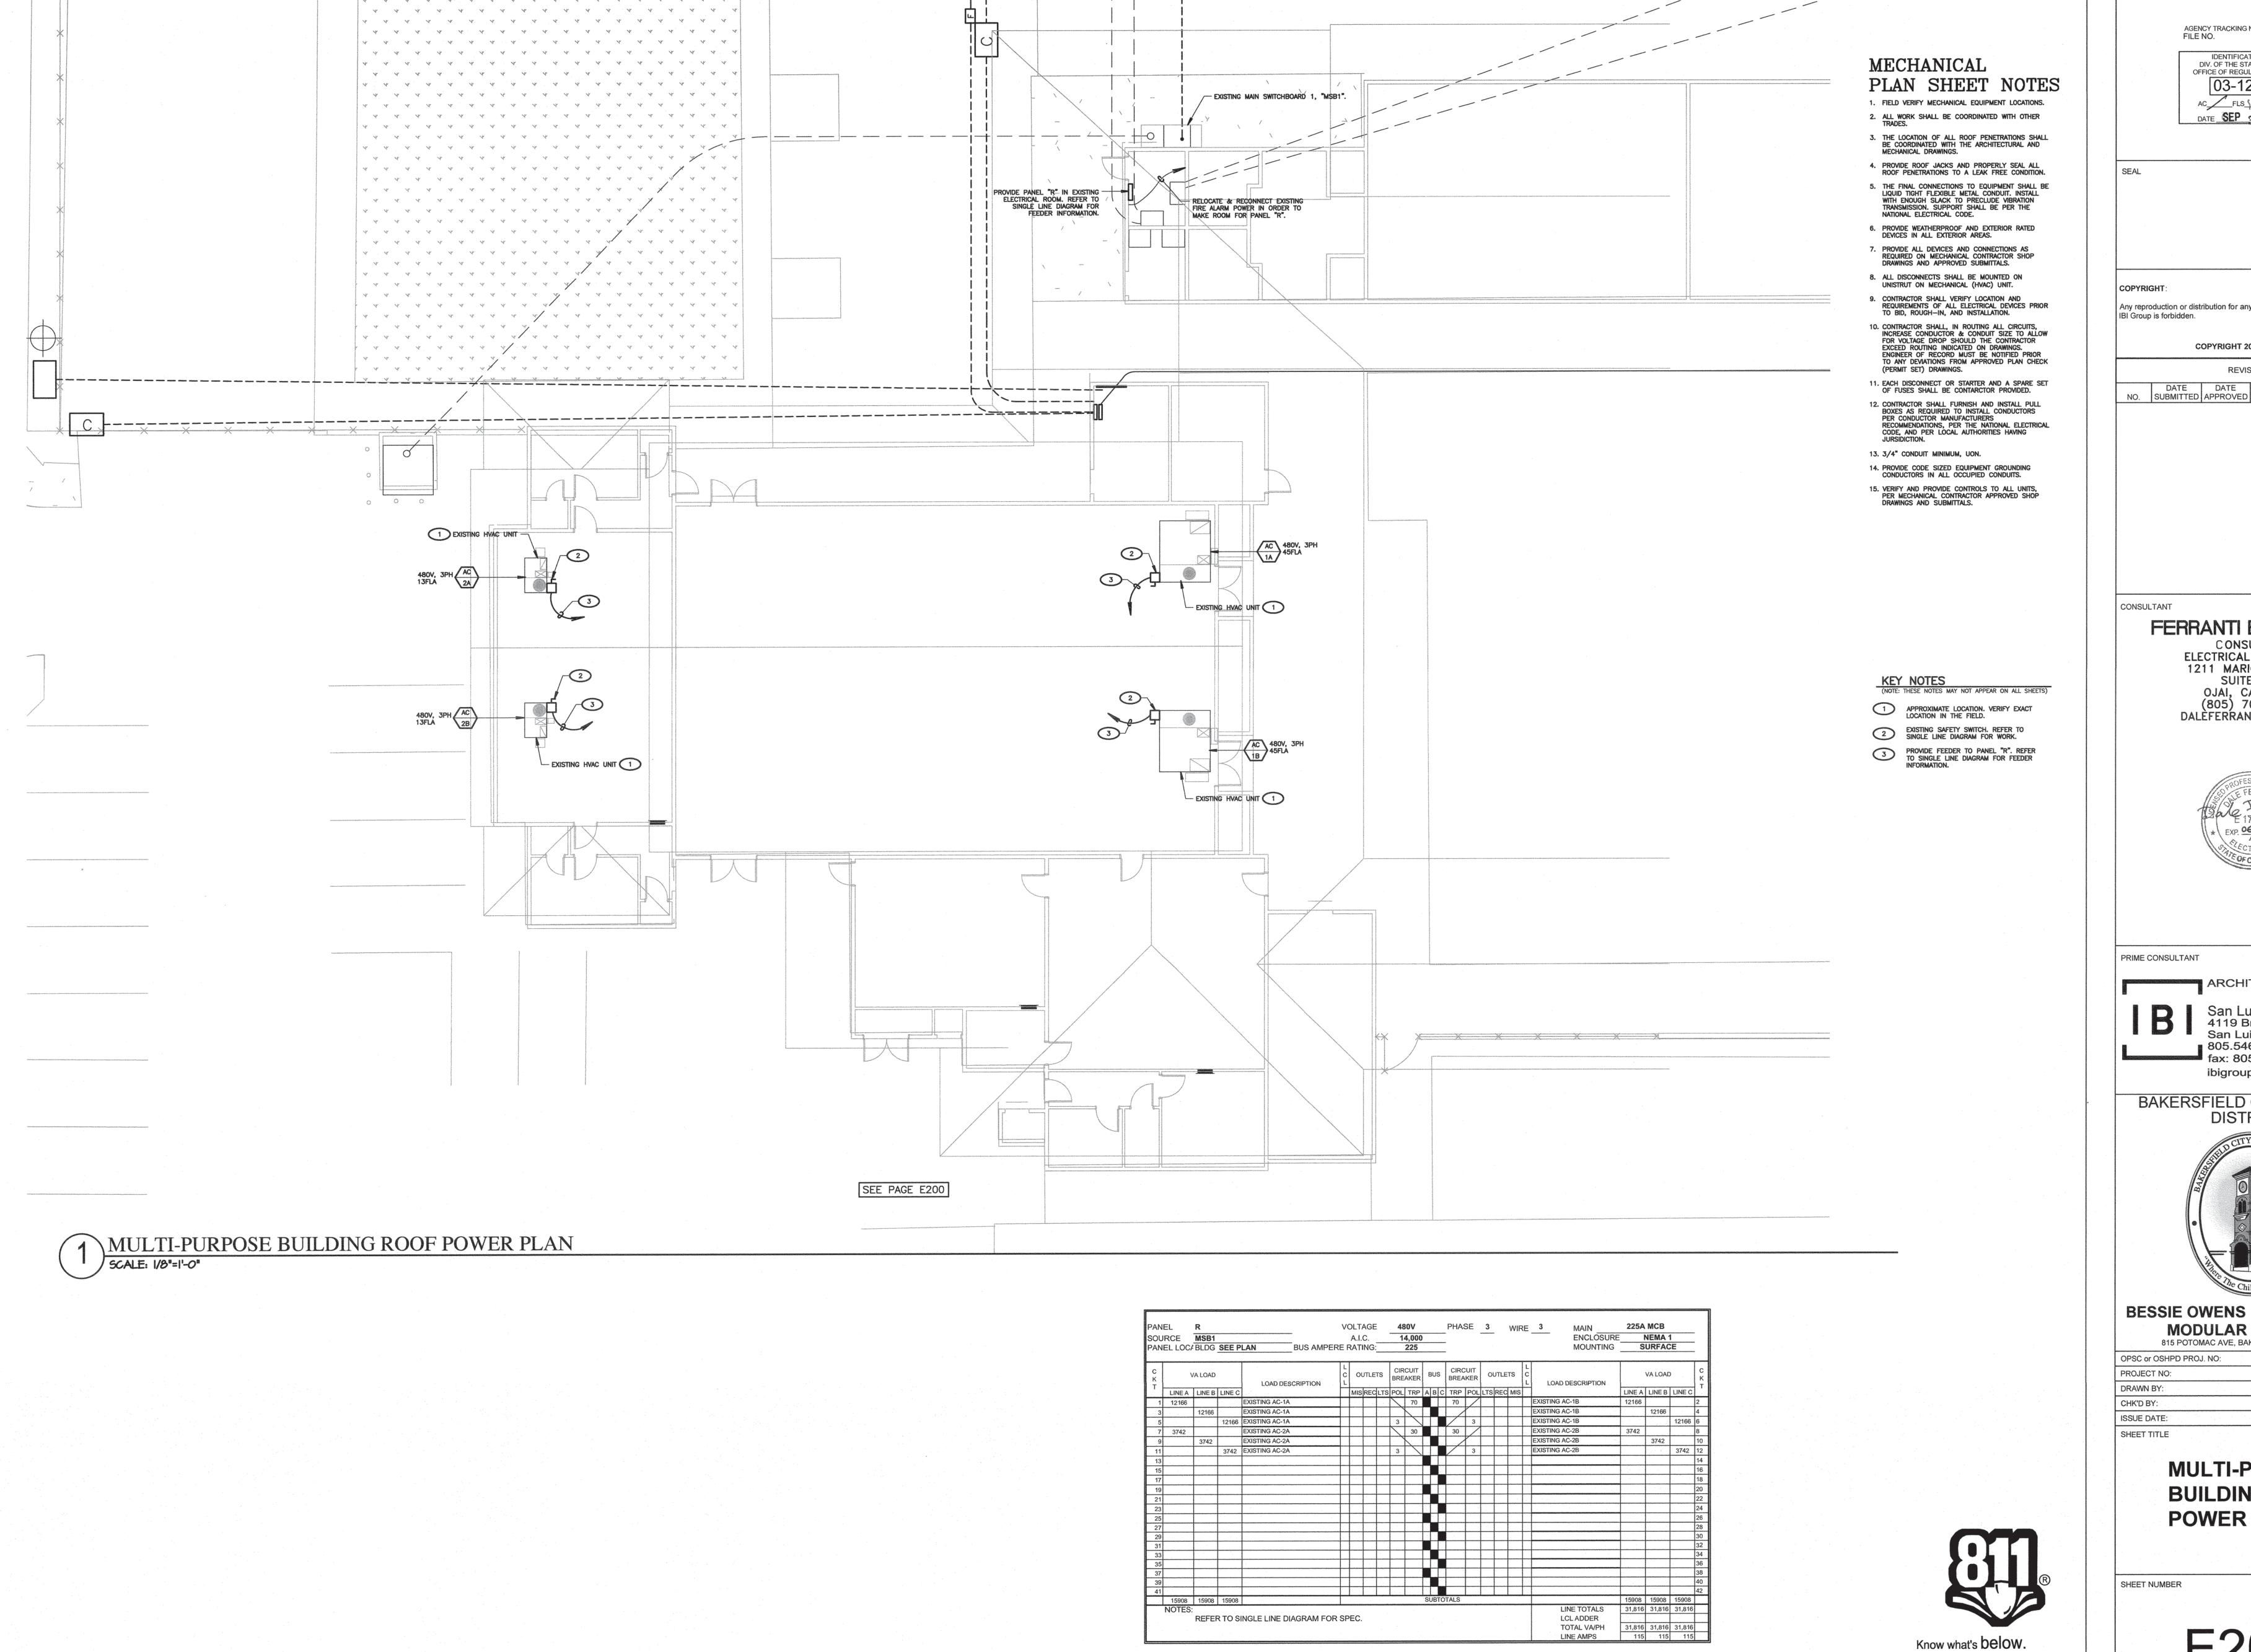
San Luis Obispo 4119 Broad Street, Suite 210 San Luis Obispo, CA 93401



BESSIE OWENS E.S. TEMPORARY

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OPSC or OSHPD PROJ. NO:	N/A	
PROJECT NO:	118932	
DRAWN BY:	V.Z.	
CHK'D BY:	D.F.	
ISSUE DATE:	8/19/2019	-
SHEET TITLE	-	

CLASSROOM/ADMIN, & PARENT CENTER)



AGENCY INFORMATION:

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BAKERSFIELD CITY SCHOOL DISTRICT


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BESSIE OWENS E.S. TEMPORARY MODULAR BUILDINGS 815 POTOMAC AVE, BAKERSFIELD, CA 93307

OPSC or OSHPD PROJ. NO: N/A PROJECT NO: 118932 DRAWN BY: V.Z. D.F. ISSUE DATE: 8/19/2019 SHEET TITLE

> **MULTI-PURPOSE BUILDING ROOF POWER PLAN**

Call before you dig.

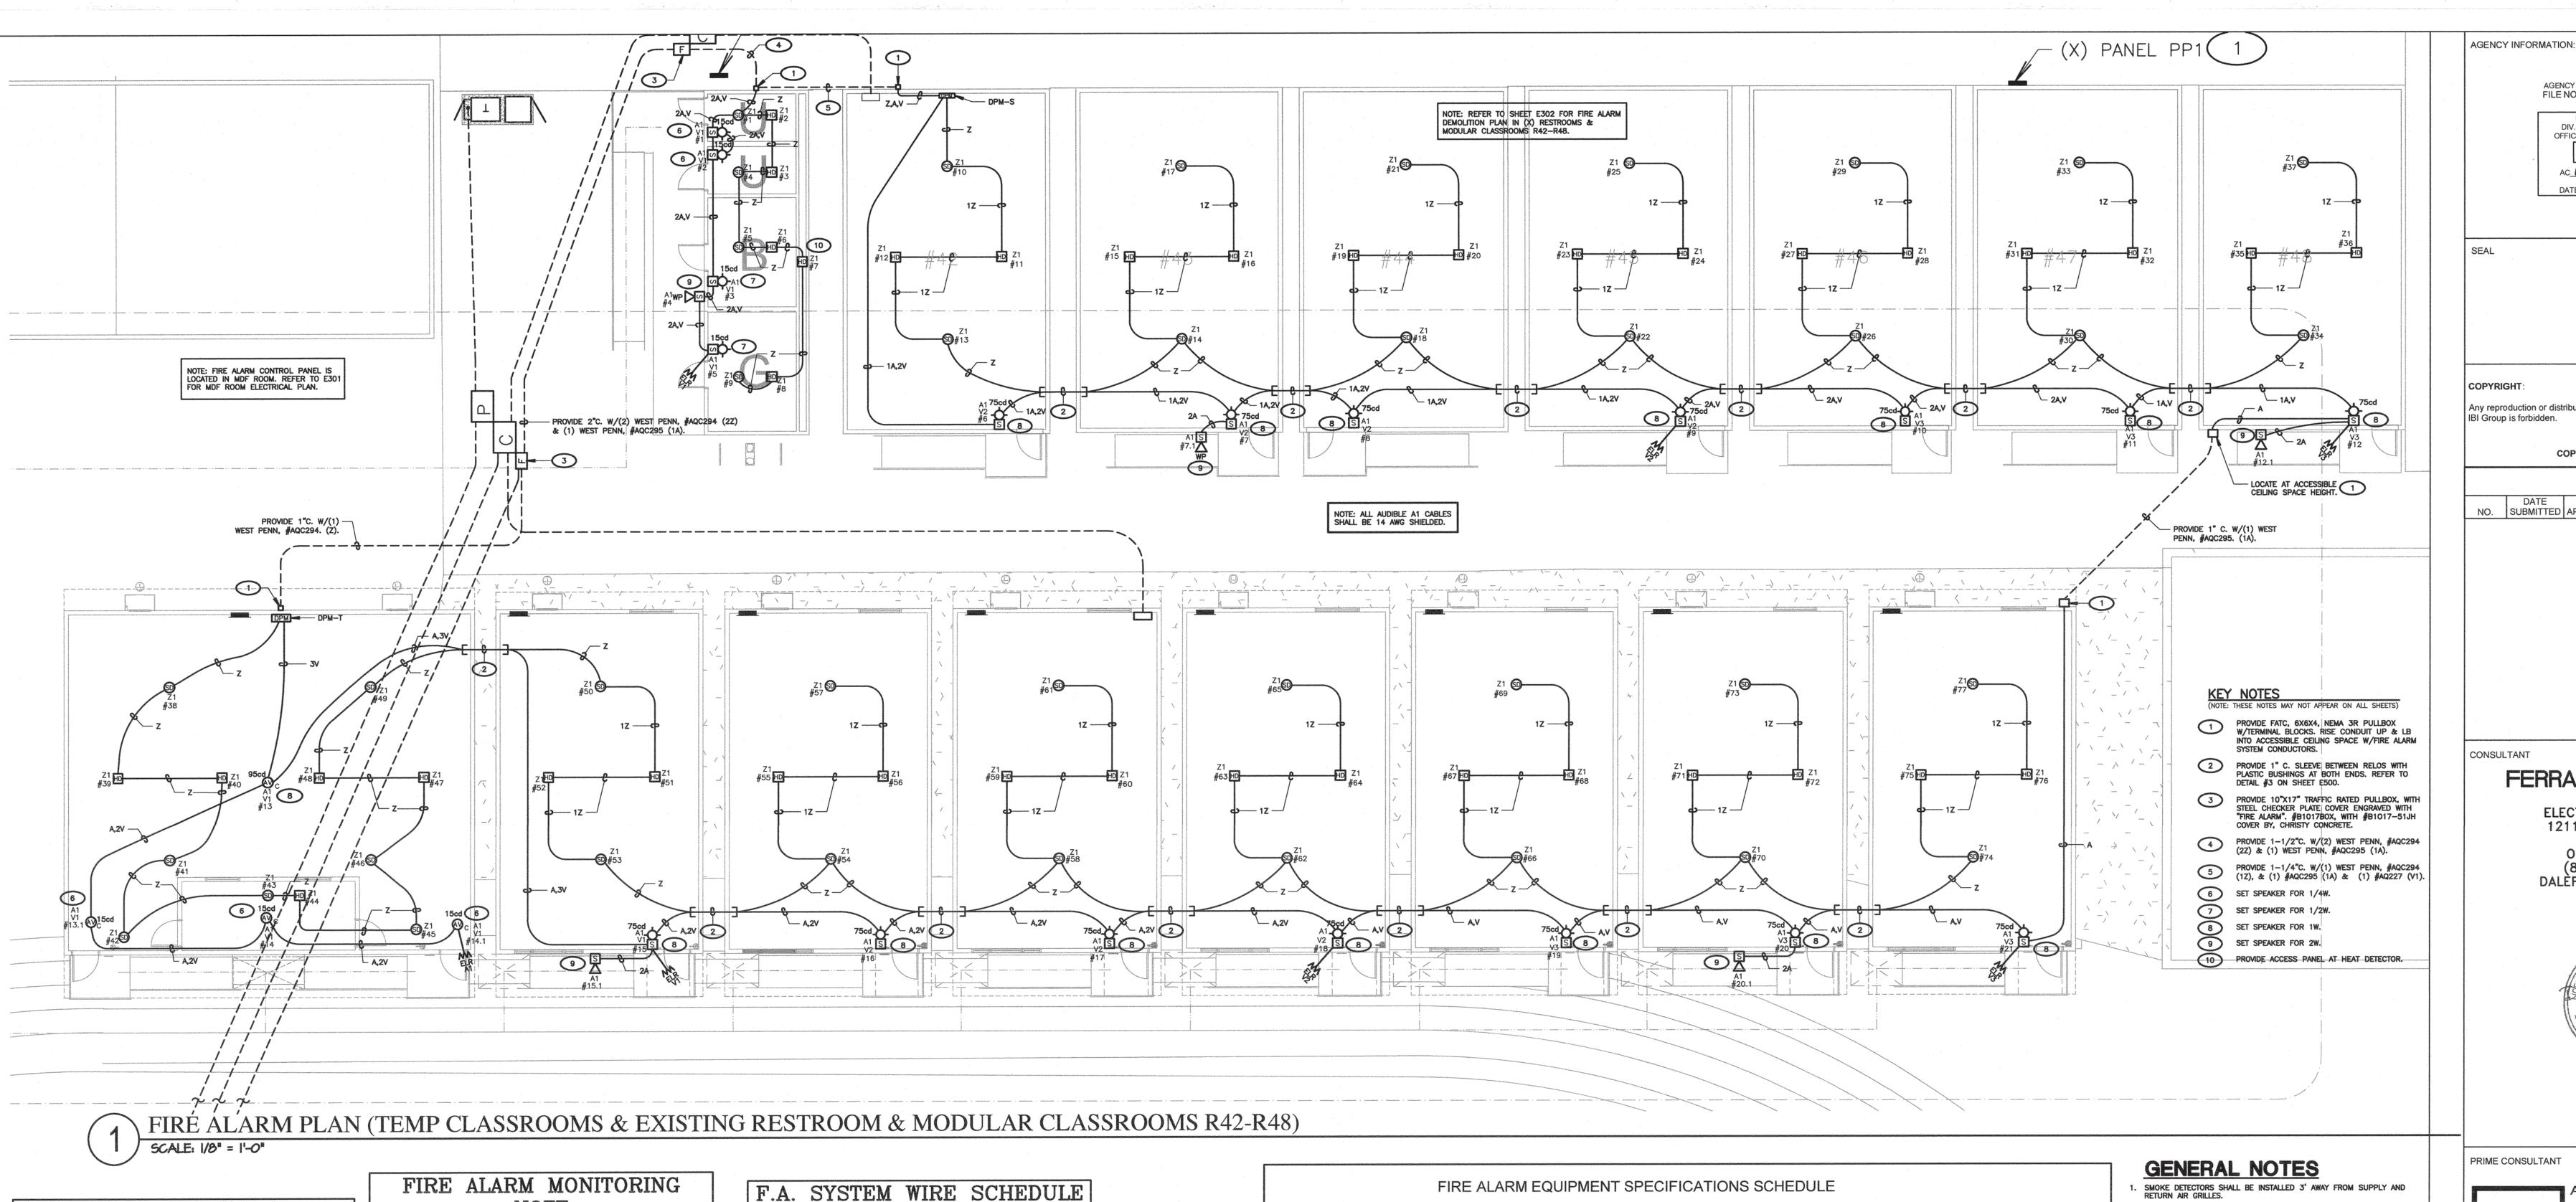

CODE, RULES & REGULATIONS

ALL WORK AND MATERIALS SHALL COMPLY WITH THE LATEST REGULATIONS OF THE STATE FIRE MARSHAL, CALIFORNIA CODE OF REGULATIONS, SERVING UTILITY COMPANIES AND OTHER APPLICABLE STATE ORDINANCES. NOTHING IN THESE PLANS OR SPECIFICATIONS IS TO BE CONSTRUED AS TO PERMIT WORK NOT CONFORMING TO THESE CODES. WHERE WORK OF A HIGHER DEGREE IS INDICATED IN THE PLANS OR SPECIFICATIONS THIS REQUIREMENT SHALL GOVERN.

FIRE ALARM LEVEL OF AUDIBILITY

ALARM INDICATING DEVICES OF A FIRE ALARM SYSTEM INTENDED TO ALERT ALL OCCUPANTS SHALL BE SO LOCATED AND UNOBSTRUCTED AS TO CAUSE A LEVEL OF AUDIBILITY OF NOT LESS THAN 15db ABOVE AMBIENT NOISE LEVELS MEASURED FOUR FEET ABOVE THE FLOOR INSIDE BUILDING.

AMBIENT NOISE LEVELS SHALL BE CONSTRUED TO MEAN THAT WHICH CAN NORMALLY BE EXPECTED TO EXIST WHEN THE FACILITY, BUILDING, ROOM OR AREA IS FUNCTIONING UNDER NORMAL OPERATIVE OR WORKING CONDITIONS.

THE FIRE ALARM SIGNAL SHALL COMPLY WITH THE CALIFORNIA EDUCATION CODE, SECTIONS 32000 AND 32004, AND BE A TEMPORAL PATTERN, CODE 3.

THE ALARM MONITORING		F.
NOTE	-	TAG
THE ALLEY OF THE ALLEY OF THE PARTY OF THE P	-	170
JTOMATIC FIRE ALARM SYSTEMS SHALL TRANSMIT THE ALARM, SUPERVISORY AND ROUBLE SIGNALS TO AN APPROVED SUPERVISING STATION AS REQUIRED BY NFPA 72 AS		٧
MENDED BY ARTICLE 91. THE SUPERVISING STATION SHALL BE LISTED AS EITHER UUFX R UUJS BY UNDERWRITERS LABORATORY OF SHALL MEET THE REQUIREMENTS OF ACTORY MUTUAL RESEARCH APPROVAL STANDARD 3011. SUPERVISION OF SYSTEM AND EASED TELEPHONE LINES SHALL BE ARRANGED BY OWNER.		
COMPLETE AUTOMATIC FIRE	Ball Sale Control	Z
ALARM PLAN SUBMITTAL		Р
HE FIRE ALARM SYSTEM SHOWN ON THESE PLANS HAS BEEN SUBMITTED AND PPROVED BY THE DIVISION OF THE STATE ARCHITECT. ANY SUBSTITUTION OF THE FIRE		A

THE FIRE ALARM SYSTEM SHOWN ON THESE PLANS HAS BEEN SUBMITTED AND APPROVED BY THE DIVISION OF THE STATE ARCHITECT. ANY SUBSTITUTION OF THE FIRE ALARM SYSTEM SHALL BE RESUBMITTED TO THE ARCHITECT FOR REVIEW AND APPROVAL. THE CONTRACTOR SHALL PAY ANY ADDITIONAL FEES THAT ARE INCURRED DUE TO THIS SUBSTITUTION.

THE FIRE ALARM SYSTEM SHALL BE A TOTAL (COMPLETE) AUTOMATIC HEAT AND SMOKE DETECTION SYSTEM, PER C.F.C SECTION 907.2.3.6, AND SHALL COVER EVERY ROOM AND/OR AREA. UPON THE ACTIVATION OF ANY INITIATION DEVICE THE FIRE ALARM SYSTEM SHALL ALERT ALL OCCUPANTS AND TRANSMIT THE ALARM, SUPERVISORY, AND TROUBLE SIGNALS TO AN APPROVED SUPERVISING STATION (C.F.C. SECTION 907.2.3.5).

SCHOOLS FIRE ALARM REQUIREMENTS

THE FIRE ALARM SYSTEM SHALL CONFORM TO CALIFORNIA BUILDING CODE, SECTION 907.2.3; CALIFORNIA ELECTRICAL CODE, ARTICLE 760 AND CALIFORNIA FIRE CODE, CHAPTER 9, SECTION 907.

UPON COMPLETION OF THE INSTALLATION OF THE FIRE PROTECTIVE SIGNALING EQUIPMENT, A SATISFACTORY TEST OF THE ENTIRE SYSTEM SHALL BE MADE IN THE PRESENCE OF THE AUTHORITY HAVING JURISDICTION, NFPA 72. IF TESTING RESULTS DETERMINE FIRE ALARM AUDIBILITY DOES NOT MEET 15db OVER AMBIENT NOISE LEVELS, ADDITIONAL FIRE ALARM SIGNALING DEVICES MAY BE REQUIRED BY THE AUTHORITY HAVING JURISDICTION.

FIRE ALARM SYSTEM CERTIFICATION AND DESCRIPTION SHALL BE PROVIDED FOR TESTING AND A PLASTIC LAMINATED COPY SHALL REMAIN (WITH INSTRUCTIONS) AT THE FIRE ALARM CONTROL PANEL PER NFPA 72.

THE FIRE ALARM "RECORD OF COMPLETION" FORM, FIGURE 10, 18, 2, 1 IN NFPA 72, SHALL BE COMPLETED, SIGNED AND SUBMITTED TO THE SCHOOL DISTRICT AND THE

LOCAL AUTHORITY (K.C.F.D.) HAVING JURISDICTION AT THE COMPLETION OF THE TEST.

					SEQU	ENC	E OF	OPE	RATIO	ONS									
		ANNUNCIATE/DISPLAY AT FACP (ALARM, TROUBLE OR SUPERVISORY)	SOUND FACP TROUBLE BUZZER (ALARM, TROUBLE OR SUPERVISORY)	ANNUNCIATE AT REMOTE FIRE ALARM ANNUNCIATOR (ALARM, TROUBLE OR SUPERVISORY)	ACTIVATE RELAY FOR CENTRAL STATION MONITORING. (ALARM, TROUBLE OR SUPERVISORY)	ACTIVATE AUDIBLE/VISUAL ALARM SIGNAL THROUGHOUT BUILDING.								SYSTEM WILL BE 100% OPERATIONAL (UP TO 24 HOURS) ON BATTERY BACKUP					SHUT DOWN AIR HANDLER UNITS
		А	В	C ·	D	E	F	G	Н	I ·	J	, K	L	М	N	0	Р	Q	R
1	MANUAL PULL STATIONS	•	•	•	•	•													
2	SMOKE DETECTORS	•	•	•	•	•													•
3	FIRE ALARM SYSTEM AC POWER FAIL	•	•	•	•									•					
4	FIRE ALARM SYSTEM LOW BATTERY	•	•	•	•														
5	OPEN CIRCUIT	•		•	•														
6	GROUND FAULT	•	•	•	. •	5										-			
8	HEAT DETECTORS	•	•	•	•	•		-							-				
9	NOTIFICATION CIRCUIT SHORT	•	•	•	•														
10																			

r'.A	A. SYSTEM WIRE	SCHEDULE
TAG	CONDUCTORS	DEVICE/FUNCTION
٧	2#12, THWN/THHN	VISIBLE NOTIFICATION DEVICES—STROBE LIGHTS
z	1-PAIR #16 TWISTED, SHIELDED PAIR WEST PENN AQC294 (BLDG. EXTERIOR & UNDERGROUND) 1-PAIR #16 TWISTED, WEST PENN D990 (BLDG. INTERIOR)	CAMPUS/BLDG. SLC INTELLIGENT LOOP INITIATING DEVICES (PULL STATIONS, SMOKE AND HEAT DETECTORS, WATER FLOW AND TAMPER SWITCHES, MONITOR AND CONTROL MODULES, ETC.)
Р	2#14, THWN/THHN	DEVICE POWER-24VDC
A	1-PAIR #16 TWISTED SHIELDED PAIR, WEST PENN AQC294 (BLDG. EXTERIOR & UNDERGROUND) 1-PAIR #16 TWISTED SHIELDED PAIR, WEST PENN 991. (BLDG. INTERIOR).	AUDIBLE NOTIFICATION DEVICES—SPEAKERS

FIRE ALARM LEGEND

F.A. SYSTEM WIRING, TAG IDENTIFIES THE FOLLOWING: FIRST NUMBER INDICATES QUANTITY OF LOOPS OR CIRCUITS; LETTER NOTATION INDICATES TYPE OF LOOP OR CIRCUIT, INCLUDING CONDUCTOR REQUIREMENTS, PER "F.A. SYSTEM WIRE

AUDIBLE CIRCUIT

NO. 1

VISIBLE CIRCUIT

NO. 1

DEVICE I.D.

NO.

INTELLIGENT LOOP NO.

DENOTES F.A. DEVICE CONNECTED TO NOTIFICATION CIRCUITS, OR INTELLIGENT LOOP CIRCUITS AND CONSECUTIVE DEVICE I.D. NO. FOR THIS LOOP.

SCHEDULE" ON THIS SHEET; NUMBER AFTER LETTER INDICATES LOOP NUMBER.

NOTES (FIRE ALARM EQUIPMENT SPECIFICATIONS SCHEDULE)

(NOTE: THESE NOTES MAY NOT APPEAR ON ALL SHEETS)

END OF LINE RESISTORS SHALL BE 10K FOR NOTIFICATION APPLIANCE CIRCUITS FEEDING FORM FIRE ALARM CONTROL PANEL AND 2.2K FOR NOTIFICATION APPLIANCE CIRCUITS FEEDING FROM FIRE ALARM POWER EXPANDER PANELS.

2 SET FOR 194 DEGREES.

THIS EQUIPMENT IS EXISTING. REFER TO FIRE ALARM RISER DIAGRAM.

PROVIDE TRIM RING, #TRC-2

PROVIDE TRANSIENT SUPPRESSORS.

		FIRE ALARM EQUIPME	NI SPECIFIC	ATIONS SCH	IEDULE	•	
SYMBOL	MODEL. NO	DESCRIPTION	MANUFACTURER	CSFM. LISTING#	BACKBOX REQUIREMENTS	MOUNTING HEIGHT (TO CENTER U.O.N.)	REMARKS
[FACP]	NFS2-3030 UDACT-2 DVC-EM DVC-KD CMIC-1 DAA2-7525 ACPS-610 SBB-D4R DR-D4R	FIRE ALARM CONTROL PANEL	NOTIFIER	7165-0028:0224	EQUIPMENT CABINET	+60	5
CDPMC)	ACPS-610 CAB-PS1	FIRE ALARM REMOTE POWER SUPPLY	NOTIFIER	7315-0028:0248	EQUIPMENT CABINET	+60	
99	FSP-951	ADDRESSABLE SMOKE DETECTOR W/BASE, #B300-6	NOTIFIER	7272-0028:0503	4" SQ. X. 2 1/8" DP. OUTLET BOX WITH S.G. RAISED RING		
HD	FST-951H	ADDRESSABLE HEAT DETECTOR W/BASE, #B300-6	NOTIFIER	7270-0028:0502	4" SQ. X. 2 1/8" DP. OUTLET BOX WITH S.G. RAISED RING		2
V	SPRK(A)	OUTDOOR WALL MOUNT SPEAKER	SYSTEM SENSOR	7320-1653:0201	MWBB(A) OUTDOOR BACKBOX	·-	
\ S	SPSRL(A)	WALL MOUNTED COMBINATION SPEAKER & STROBE LIGHT (CANDELA VALUE AS SHOWN ON PLANS)	SYSTEM SENSOR	7320-1653:0505	4" SQ. X 2 1/8" DP. OUTLET BOX	 	
CANN	LCD-160	REMOTE ANNUNCIATOR	NOTIFIER	7120-0028:0227			
M.R.		END OF LINE RESISTOR 1			4" SQ. X 2 1/8" DP. OUTLET BOX		
					4" SQ. X. 2 1/8" DP. OUTLET BOX		
KP6—MA		SIX ZONE INTERFACE MODULE	NOTIFIER	7300-0028:0219	LOCATE IN FIRE ALARM REMOTE POWER SUPPLY		3
® .	SPSCRL(A)	CEILING MOUNTED COMBINATION SPEAKER & STROBE LIGHT(CANDELA) VALVE AS SHOWN ON PLANS)	SYSTEM SENSOR	7320-1653;0505	4" SQ. X. 2 1/8" DP. OUTLET BOX		4

NOTE: EXISTING FIRE ALARM SHALL NOT BE REMOVED UNTIL NEW SYSTEM IS INSTALLED

SMOKE DETECTORS SHALL BE INSTALLED 3' AWAY FROM SUPPLY AND RETURN AIR GRILLES.
 FINAL FIRE ALARM TEST OF ALL DEVICES SHALL BE WITNESSED BY THE PROJECT INSPECTOR. TEST SHALL INCLUDE ALL INFORMATION PER NFPA 72, FIGURE 14.6.2.4 AND READ OUT VERIFICATION FORM FROM CENTRAL STATION. TEST SHALL ALSO BE WITNESSED BY THE LOCAL AUTHORITY

HAVING JURISDICTION (A.H.J.).

5. UNDERGROUND AND EXTERIOR CONDUITS WILL HAVE WATER—TIGHT

FITTINGS (C.E.C. 110.11 AND 300.6).

4. AUDIBLE DEVICE(S) SHALL BE AT LEAST 15dbA ABOVE AVERAGE AMBIENT SOUND LEVEL BUT NOT LESS THAN 75dbA AT 10' OR MORE THAN 110

SOUND LEVEL BUT NOT LESS THAN 75dbA AT 10' OR MORE THAN 110 dbA IN TOTAL, THROUGHOUT! (NFPA 72 18.4.1 AND C.F.C. 907.6.2).

5. AUDIBLE DEVICES SHALL SOUND THE CALIFORNIA CODE IN TEMPORAL PATTERN, CODE 3.

PATTERN, CODE 3.

6. VISUAL DEVICES SHALL NOT EXCEED TWO FLASHES PER SECOND AND SHALL NOT BE SLOWER THAN ONE FLASH PER SECOND. (NFPA 72 18.5.2.1).

PROVIDE AN ENGRAVED NAMEPLATE INDICATING THE D.S.A. APPLICATION NUMBER, FILE NUMBER AND DATE OF INSTALLATION AT FIRE ALARM POWER EXPANDER PANEL. WHITE LETTERS ON A RED BACKGROUND.
 PROVIDE A COPY OF THE BATTERY CALCULATION AT THE FIRE ALARM POWER EXPANDER PANEL. BATTERY CALCULATION SHALL CONTAIN INFORMATION AS NOTED ON SCHEDULES AND BE PLASTIC LAMINATED. MOUNT ONTO INSIDE FACE OF DOOR.
 MORE THAN TWO VISIBLE NOTIFICATION APPLIANCES OR GROUPS OF SYNCHRONIZED APPLIANCES IN THE SAME ROOM OR ADJACENT SPACE

WITHIN THE FIELD OF VIEW SHALL FLASH IN SYNCHRONIZATION (NFPA 72 18.5.4.3.2(4)).

10. THE AUTOMATIC ALARM SYSTEM SHALL BE INSTALLED, TESTED AND MAINTAINED IN ACCORDANCE WITH THE STATE FIRE MARSHAL'S

REGULATIONS (C.F.C. 907.9).

11. THE FIRE ALARM SYSTEM SHALL CONFORM TO ARTICLE 760 OF THE CALIFORNIA ELECTRICAL CODE, CURRENT CALIFORNIA TITLE 24 REQUIREMENTS, CALIFORNIA FIRE CODE, NFPA 72 AND 101 STANDARDS, AMERICAN WITH DISABILITY ACT (ADA) REQUIREMENTS.

12. DRAWINGS DO NOT SHOW ALL THE NECESSARY J—BOXES AND PULL BOXES WHICH WILL BE REQUIRED THROUGHOUT. IT IS THE CONTRACTOR'S RESPONSIBILITY TO PROVIDE ALL THESE BOXES AS NECESSARY TO TERMINATE CONDUITS AND RACEWAYS. PAINT BOXES TO MATCH COLOR OF THE FINISHED BUILDING WALLS.

OF THE FINISHED BUILDING WALLS.

13. ALL JUNCTIONS BOXES AND DEVICES INDICATED ON BUILDING EXTERIORS SHALL BE WEATHERPROOF TYPE.

14. FIRE ALARM WIRES SHALL BE COPPER TYPE THWN/THHN.
15. ALL SIGNAL WIRING IN UNDERGROUND CONDUITS SHALL BE WET LOCATION TYPE.
16. WHEN ALL FIRE ALARM DEVICES ARE INSTALLED AND PROGRAMMING IS

COMPLETE, PROVIDE A FIRE ALARM DEVICE MAP IN THE SCHOOL MAIN OFFICE TO INDICATE TO SCHOOL PERSONNEL THE LOCATIONS OF THE NEW DEVICES.

17. JUNCTION BOXES SHALL NOT CONTAIN SPLICES. CONDUCTORS SHALL BE PULLED THROUGH. TERMINATIONS SHALL BE PERFORMED.

JUNCTION BOXES SHALL NOT CONTAIN SPLICES. CONDUCTORS SHALL BE PULLED THROUGH. TERMINATIONS SHALL BE PERFORMED.
 ALL EXPOSED CONDUITS AND BOXES SHALL BE PAINTED TO MATCH THE SURFACE WHERE INSTALLED.

FIRE ALARM SYSTEM INSTALLATION NOTES

ALL DRAWINGS ARE DIAGRAMMATIC ONLY, AND SHALL NOT BE USED IN DETERMINING ACTUAL CONDUIT ROUTING. THE CONTRACTOR SHALL VERIFY ALL CONDUIT ROUTING CONDITIONS AT THE PROJECT SITE AS CONSTRUCTION PROGRESSES.


ALL FIRE ALARM DATA COMMUNICATIONS AND INITIATING CIRCUITS SHALL BE INSTALLED UTILIZING SOLID COPPER CONDUCTORS WITH OUTER COVERING COLORS PER THE SPECIFICATIONS AND AS SHOWN ON THE DRAWINGS. ALL SMOKE DAMPER AND REMOTE TROUBLE INDICATOR CIRCUITS SHALL BE YELLOW. ALL CIRCUITS SHALL BE INDIVIDUALLY LABELED, BOTH AT THE DEVICE END AND AT THE SIGNAL TERMINAL CABINET AND/OR FIRE ALARM MASTER PANEL TERMINATION POINT.

ALL FIRE ALARM CIRCUITS SHALL BE CONTINUOUS FROM DEVICE TO DEVICE. SPLICES ARE NOT ALLOWED UNLESS IN COVERED JUNCTION BOXES ON APPROVED TERMINAL BLOCKS. 'T' TAPPING IS ALLOWED ONLY UNDER THESE

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OPSC or OSHPD PROJ. NO:	N/A
PROJECT NO:	118932
DRAWN BY:	V.Z.
CHK'D BY:	D.F.
ISSUE DATE:	8/19/2019
SHEET TITLE	

FIRE ALARM PLAN (TEMP CLASSROOMS & EXISTING RESTROOM & MODULAR CLASSROOMS R42-R48)

SHEET NUMBER

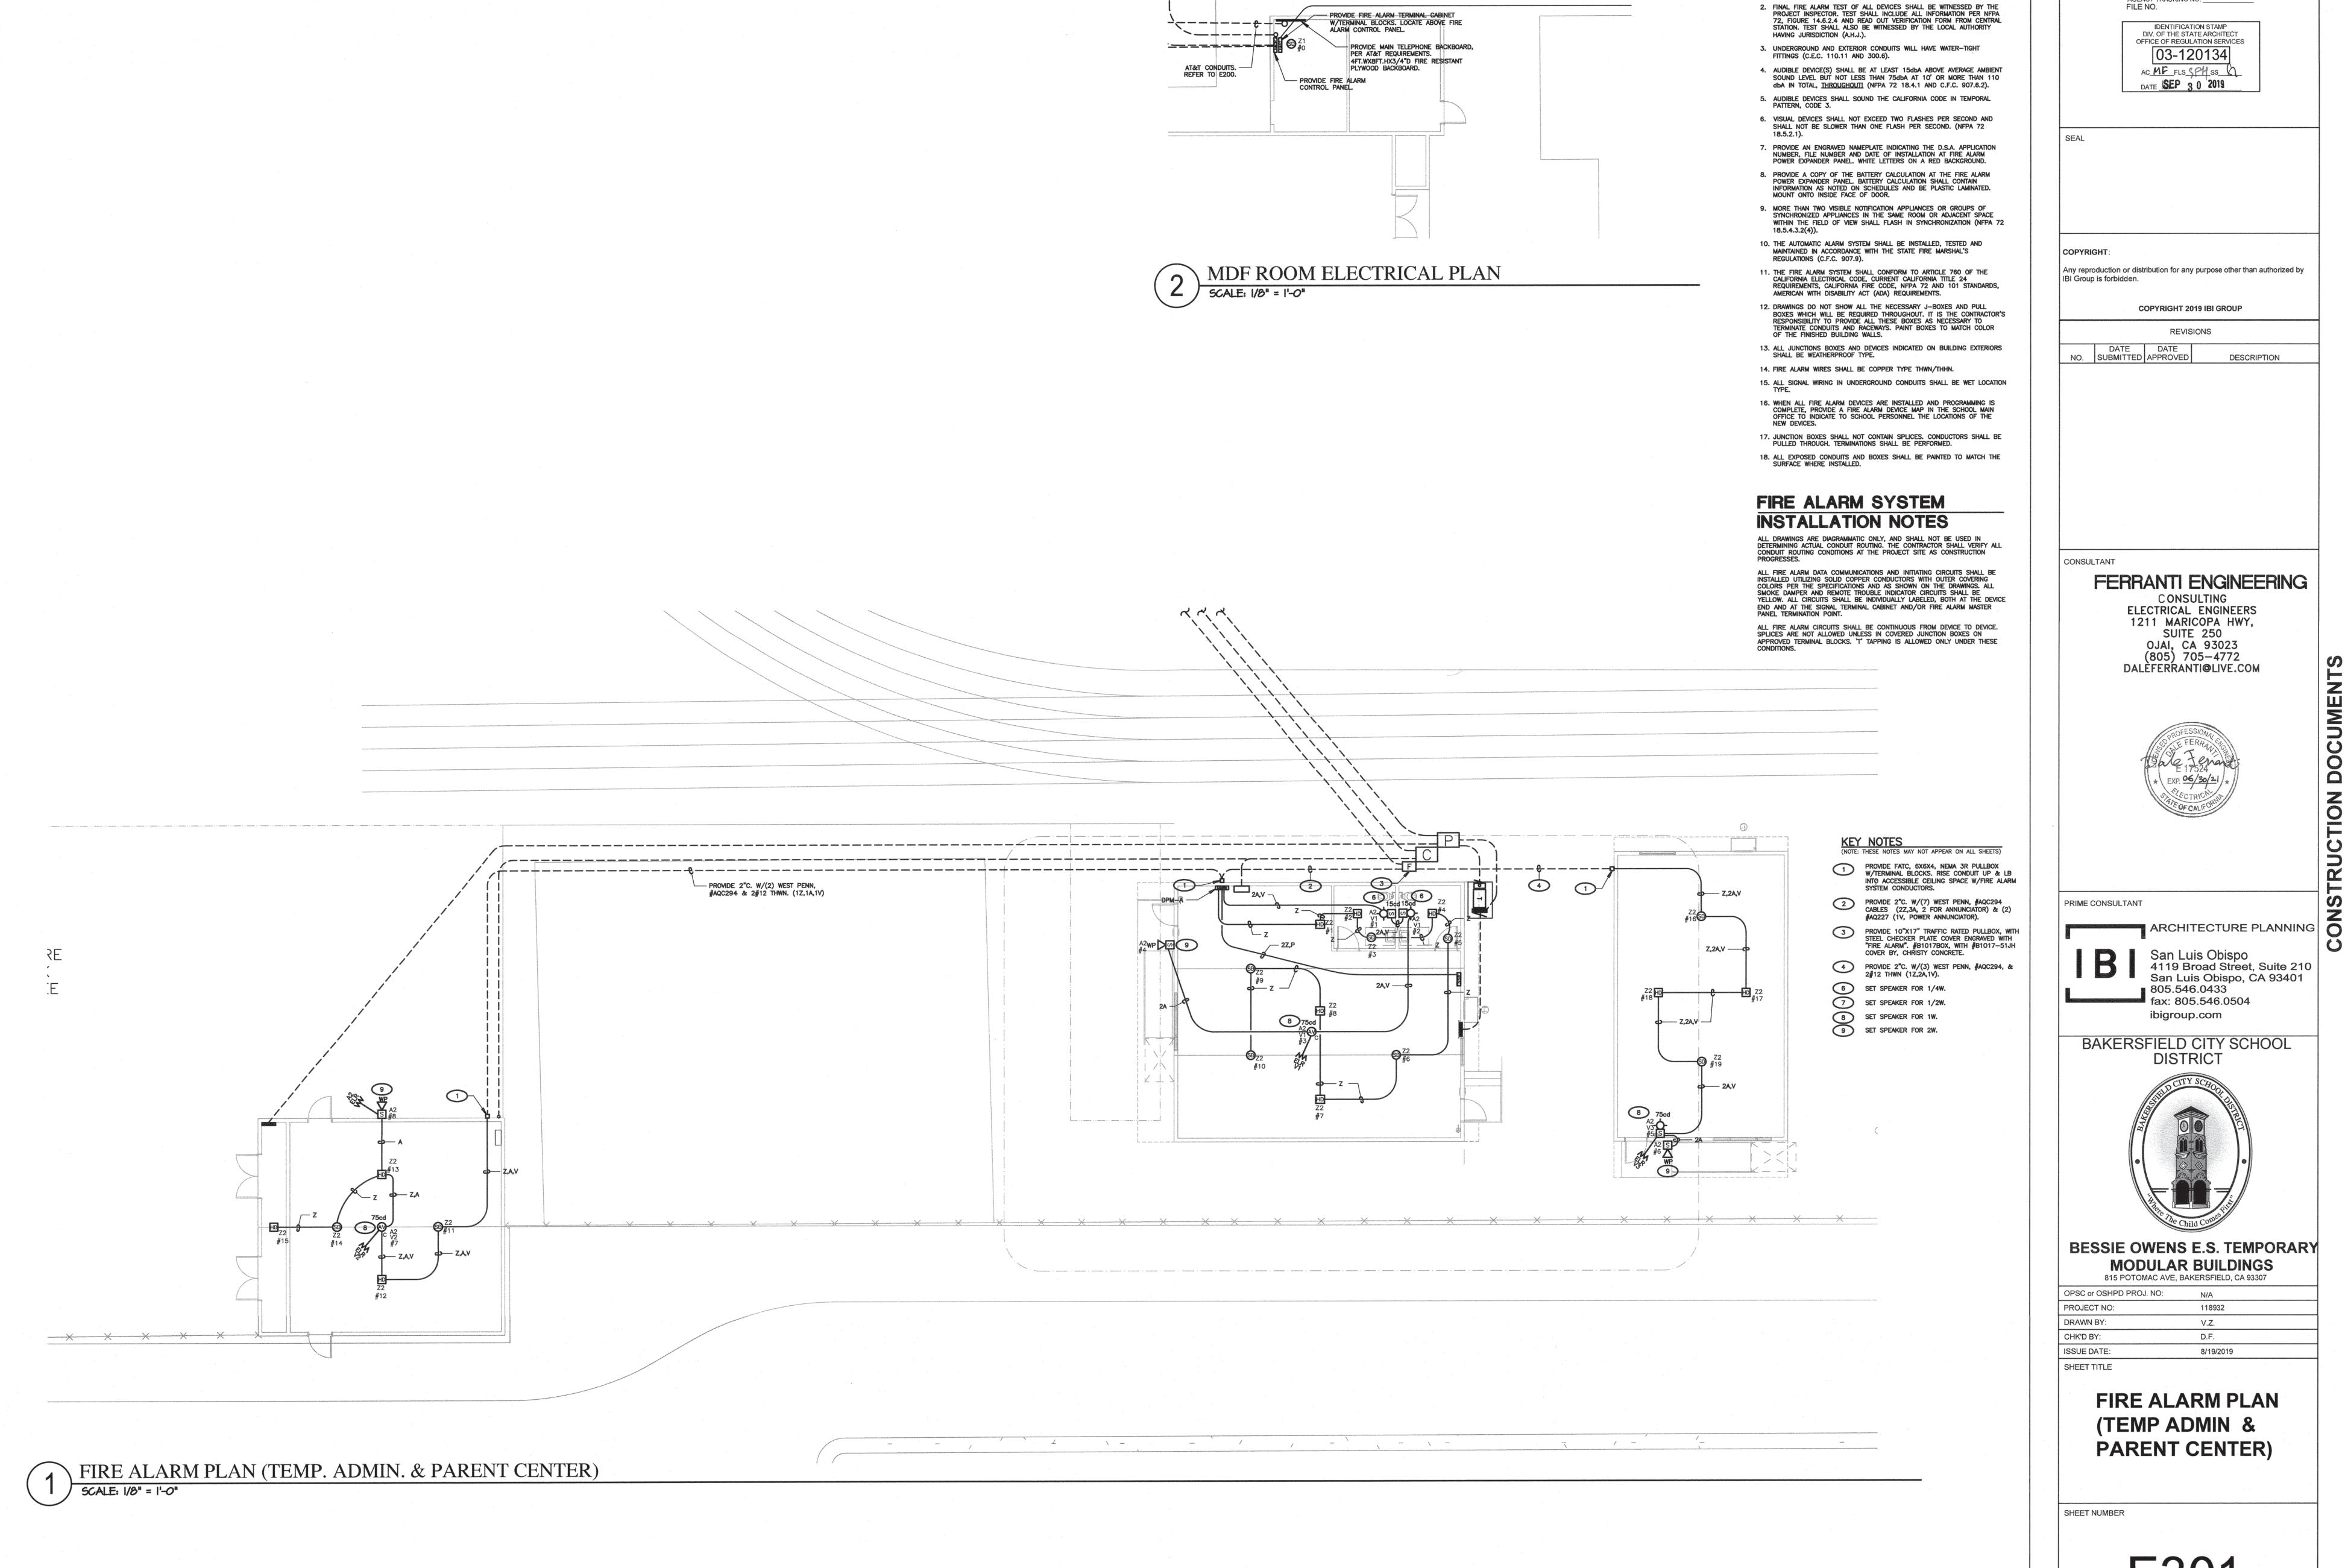

AGENCY INFORMATION:

GENERAL NOTES

. SMOKE DETECTORS SHALL BE INSTALLED 3' AWAY FROM SUPPLY AND RETURN AIR GRILLES.

AGENCY TRACKING NO. 63321-355

- HAVING JURISDICTION (A.H.J.). 3. UNDERGROUND AND EXTERIOR CONDUITS WILL HAVE WATER-TIGHT FITTINGS (C.E.C. 110.11 AND 300.6).
- 4. AUDIBLE DEVICE(S) SHALL BE AT LEAST 15dbA ABOVE AVERAGE AMBIENT SOUND LEVEL BUT NOT LESS THAN 75dbA AT 10' OR MORE THAN 110 dba in total, Throughout! (NFPA 72 18.4.1 AND C.F.C. 907.6.2).
- 5. AUDIBLE DEVICES SHALL SOUND THE CALIFORNIA CODE IN TEMPORAL
- 6. VISUAL DEVICES SHALL NOT EXCEED TWO FLASHES PER SECOND AND SHALL NOT BE SLOWER THAN ONE FLASH PER SECOND. (NFPA 72
- PROVIDE AN ENGRAVED NAMEPLATE INDICATING THE D.S.A. APPLICATION NUMBER, FILE NUMBER AND DATE OF INSTALLATION AT FIRE ALARM POWER EXPANDER PANEL. WHITE LETTERS ON A RED BACKGROUND. 8. PROVIDE A COPY OF THE BATTERY CALCULATION AT THE FIRE ALARM POWER EXPANDER PANEL. BATTERY CALCULATION SHALL CONTAIN INFORMATION AS NOTED ON SCHEDULES AND BE PLASTIC LAMINATED.
- 9. MORE THAN TWO VISIBLE NOTIFICATION APPLIANCES OR GROUPS OF SYNCHRONIZED APPLIANCES IN THE SAME ROOM OR ADJACENT SPACE WITHIN THE FIELD OF VIEW SHALL FLASH IN SYNCHRONIZATION (NFPA 72
- 10. THE AUTOMATIC ALARM SYSTEM SHALL BE INSTALLED, TESTED AND MAINTAINED IN ACCORDANCE WITH THE STATE FIRE MARSHAL'S REGULATIONS (C.F.C. 907.9).

18.5.4.3.2(4)).


- 11. THE FIRE ALARM SYSTEM SHALL CONFORM TO ARTICLE 760 OF THE CALIFORNIA ELECTRICAL CODE, CURRENT CALIFORNIA TITLE 24 REQUIREMENTS, CALIFORNIA FIRE CODE, NFPA 72 AND 101 STANDARDS,
- AMERICAN WITH DISABILITY ACT (ADA) REQUIREMENTS. 12. DRAWINGS DO NOT SHOW ALL THE NECESSARY J-BOXES AND PULL BOXES WHICH WILL BE REQUIRED THROUGHOUT. IT IS THE CONTRACTOR'S RESPONSIBILITY TO PROVIDE ALL THESE BOXES AS NECESSARY TO TERMINATE CONDUITS AND RACEWAYS. PAINT BOXES TO MATCH COLOR OF THE FINISHED BUILDING WALLS.
- 13. ALL JUNCTIONS BOXES AND DEVICES INDICATED ON BUILDING EXTERIORS SHALL BE WEATHERPROOF TYPE.
- 14. FIRE ALARM WIRES SHALL BE COPPER TYPE THWN/THHN.
- 15. ALL SIGNAL WIRING IN UNDERGROUND CONDUITS SHALL BE WET LOCATION
- COMPLETE, PROVIDE A FIRE ALARM DEVICE MAP IN THE SCHOOL MAIN OFFICE TO INDICATE TO SCHOOL PERSONNEL THE LOCATIONS OF THE
- 17. JUNCTION BOXES SHALL NOT CONTAIN SPLICES. CONDUCTORS SHALL BE 18. ALL EXPOSED CONDUITS AND BOXES SHALL BE PAINTED TO MATCH THE SURFACE WHERE INSTALLED.

FIRE ALARM SYSTEM **INSTALLATION NOTES**


ALL DRAWINGS ARE DIAGRAMMATIC ONLY, AND SHALL NOT BE USED IN DETERMINING ACTUAL CONDUIT ROUTING. THE CONTRACTOR SHALL VERIFY ALL CONDUIT ROUTING CONDITIONS AT THE PROJECT SITE AS CONSTRUCTION

ALL FIRE ALARM DATA COMMUNICATIONS AND INITIATING CIRCUITS SHALL BE INSTALLED UTILIZING SOLID COPPER CONDUCTORS WITH OUTER COVERING COLORS PER THE SPECIFICATIONS AND AS SHOWN ON THE DRAWINGS. ALL SMOKE DAMPER AND REMOTE TROUBLE INDICATOR CIRCUITS SHALL BE YELLOW, ALL CIRCUITS SHALL BE INDIVIDUALLY LABELED, BOTH AT THE DEVICE END AND AT THE SIGNAL TERMINAL CABINET AND/OR FIRE ALARM MASTER PANEL TERMINATION POINT.


ALL FIRE ALARM CIRCUITS SHALL BE CONTINUOUS FROM DEVICE TO DEVICE. SPLICES ARE NOT ALLOWED UNLESS IN COVERED JUNCTION BOXES ON APPROVED TERMINAL BLOCKS. 'T' TAPPING IS ALLOWED ONLY UNDER THESE

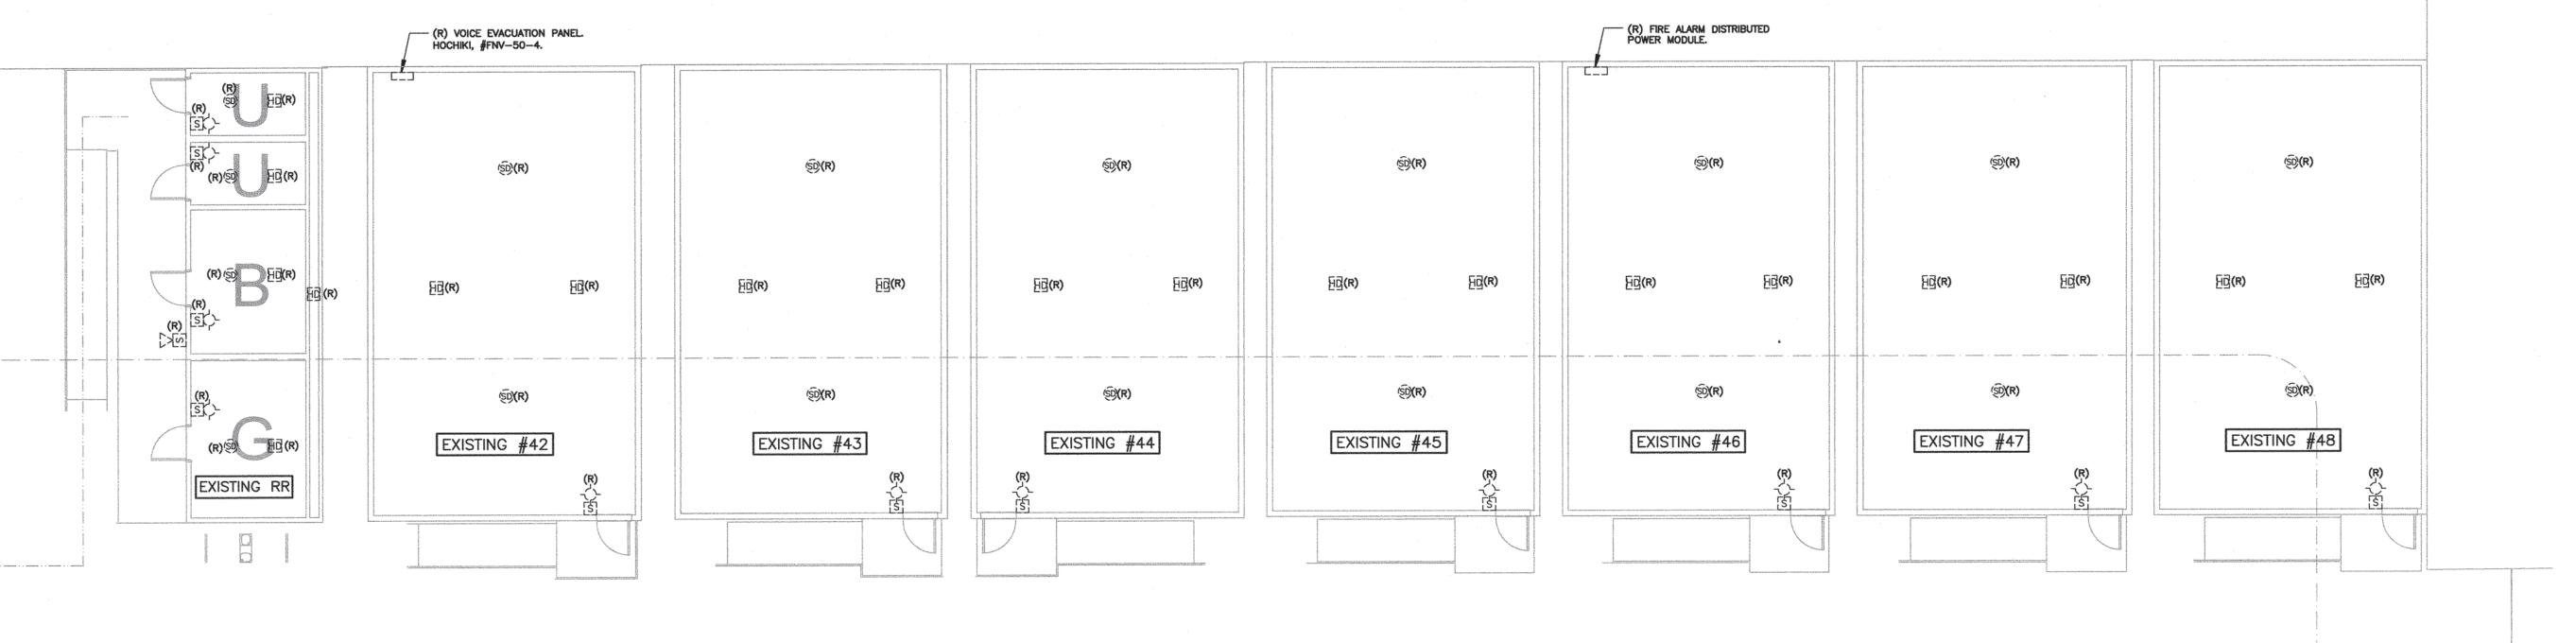

EXISTING RESTROOM & MODULAR CLASSROOMS R42-R48 FIRE ALARM DEMOLITION PLAN

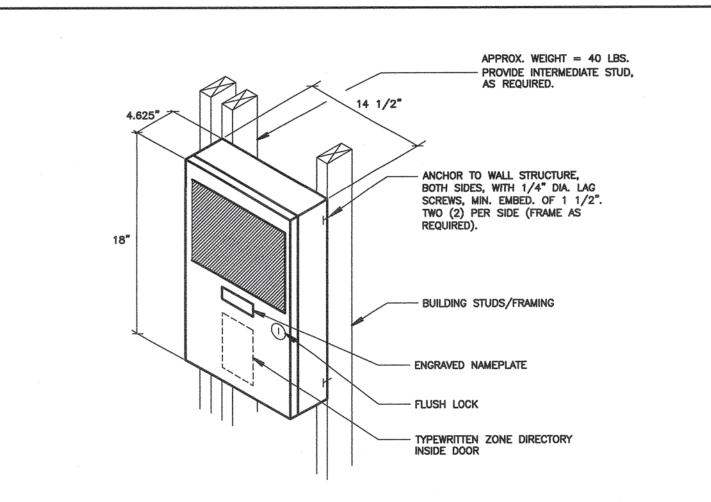


FIRE ALARM REMOTE POWER SUPPLY (FAPS), MOUNTING DETAIL NOT TO SCALE

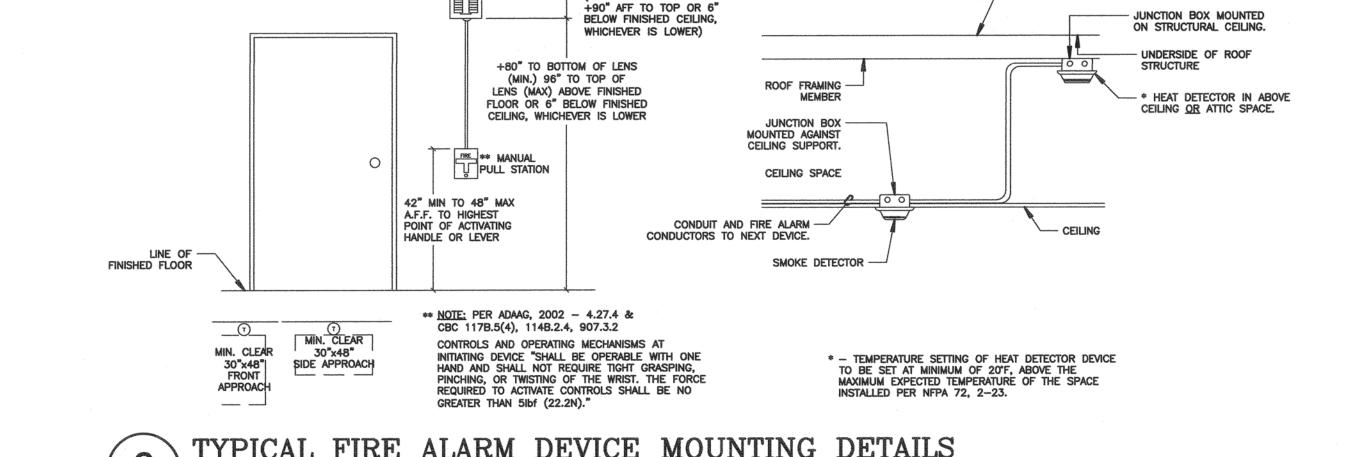



(SPEAKER ONLY DEVICE

STRUCTURAL CEILING.

TYPICAL FIRE ALARM DEVICE MOUNTING DETAILS SCALE: NOT TO SCALE

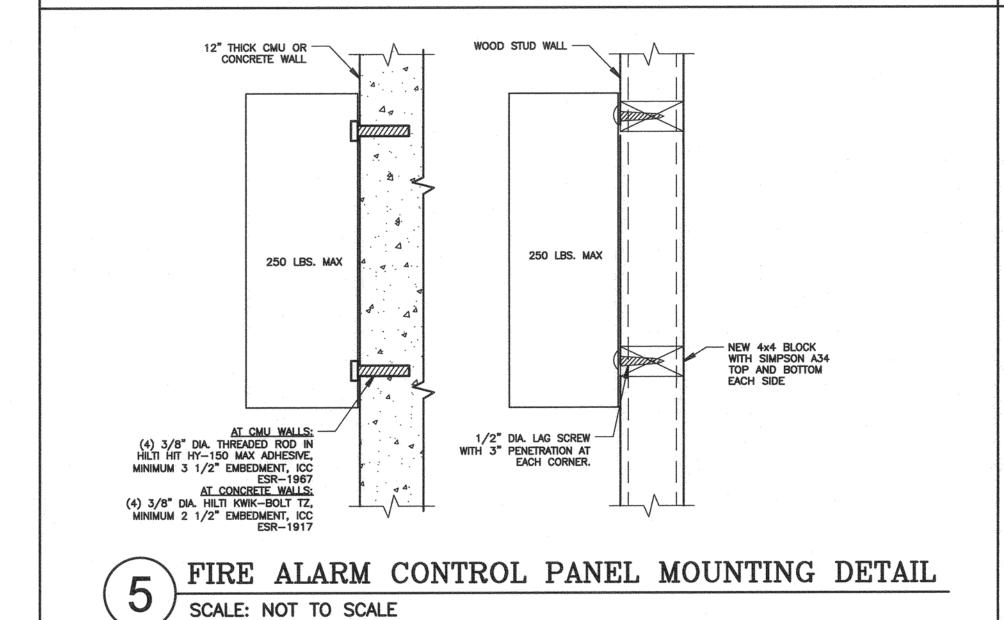

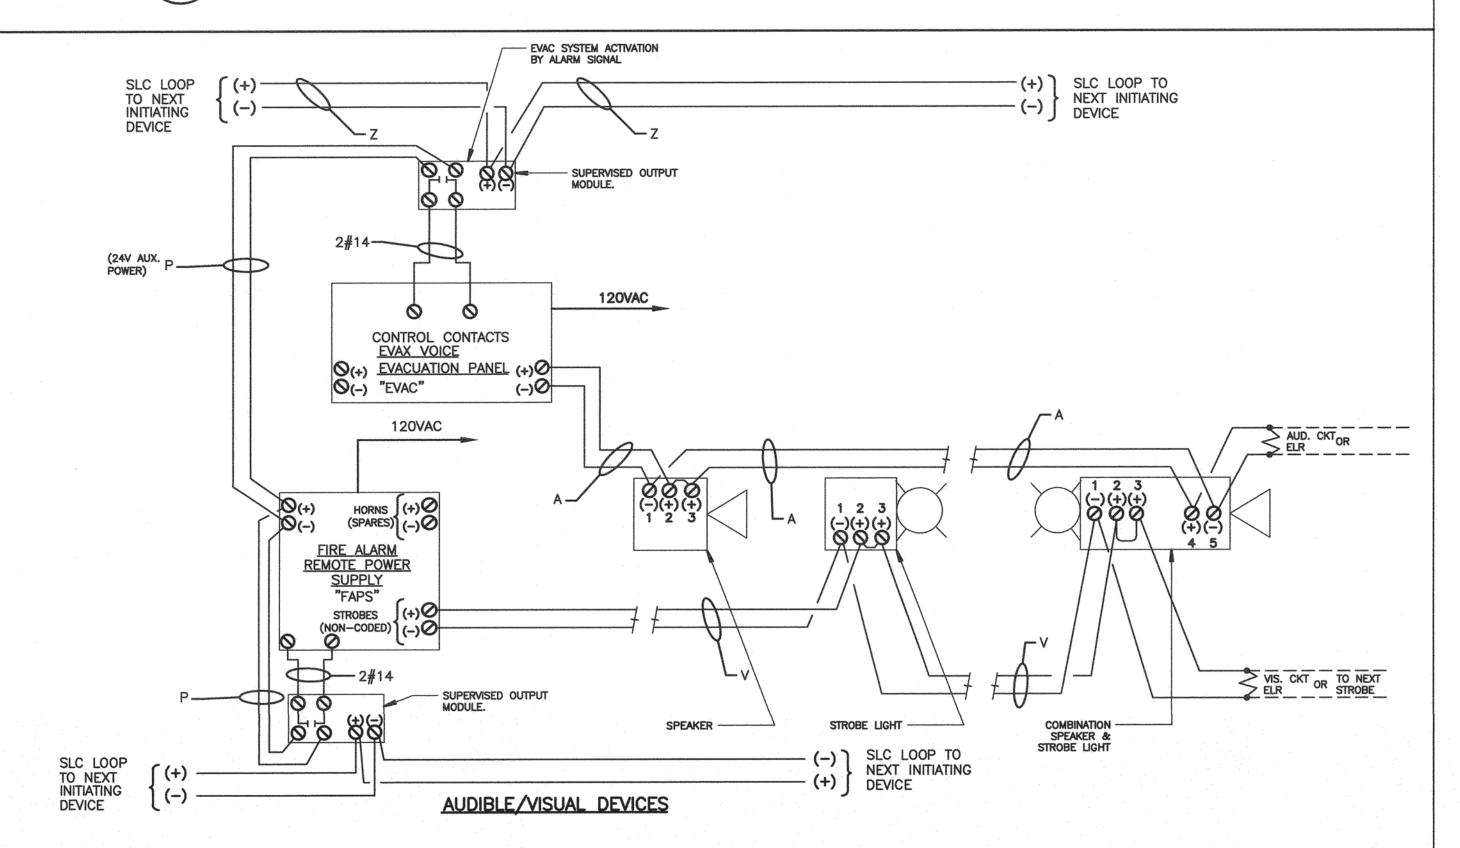

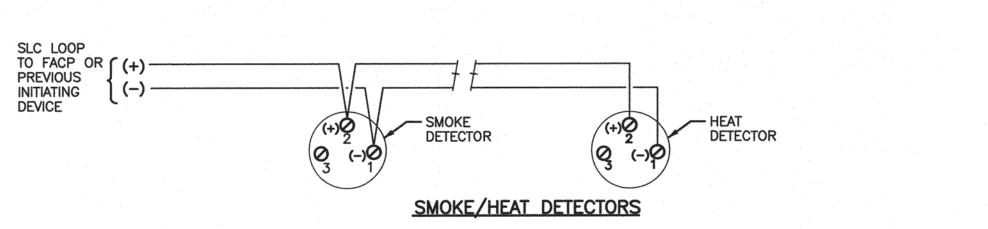


TYPICAL DEVICES WIRING DIAGRAMS DETAIL

NOT TO SCALE

NOTE:
A=AUDIBLE NOTIFICATION DEVICE CIRCUIT
V=VISIBLE NOTIFICATION DEVICE CIRCUIT
Z=SLC INTELLIGENT LOOP
P=DEVICE POWER REFER TO "F.A. SYSTEM WIRE SCHEDULE" ON FIRE ALARM PLAN.

E302

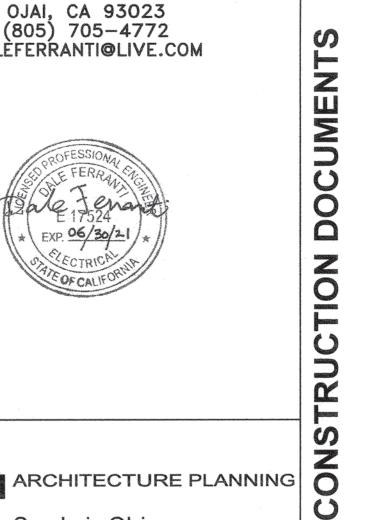

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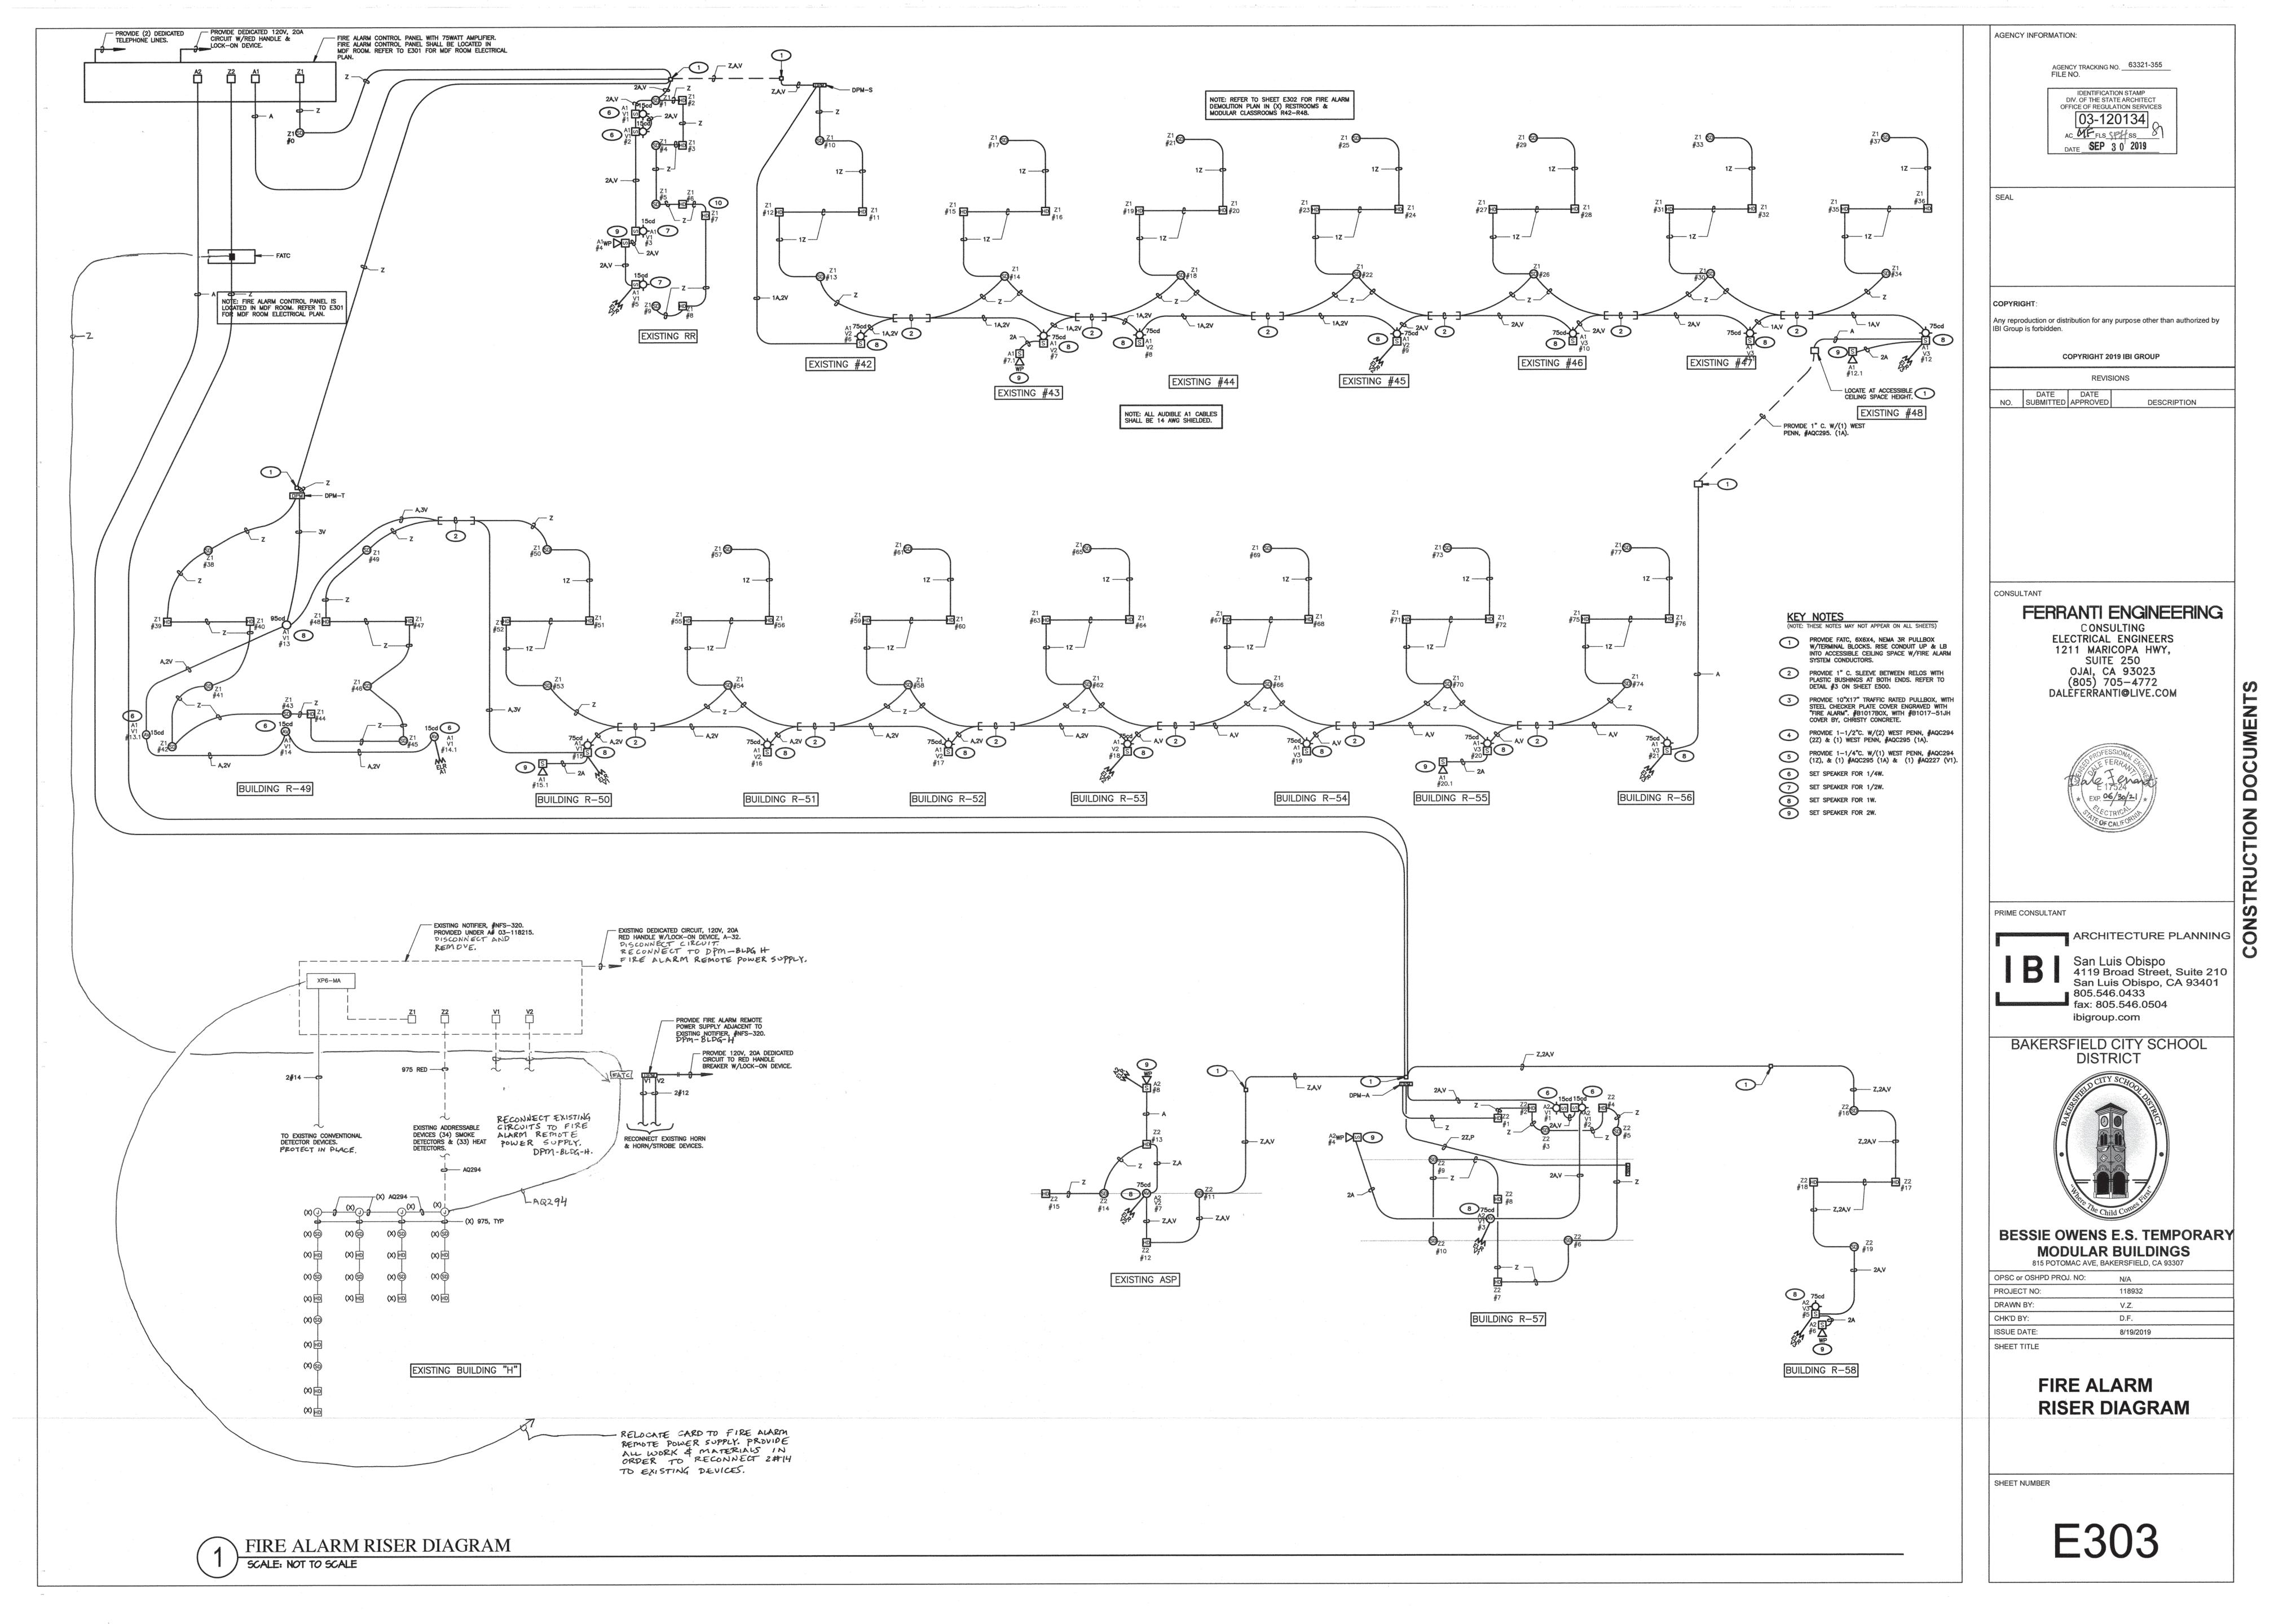


BESSIE OWENS E.S. TEMPORARY MODULAR BUILDINGS 815 POTOMAC AVE, BAKERSFIELD, CA 93307

OPSC or OSHPD PROJ. NO: 118932 PROJECT NO: DRAWN BY: V.Z. D.F. CHK'D BY: ISSUE DATE: 8/19/2019 SHEET TITLE

EXISTING RESTROOM & MODULAR CLASSROOMS R42-R48 FIRE ALARM **DEMOLITION PLAN, FIRE ALARM DETAILS**

SHEET NUMBER



FACP

FACP

(mA)

FACP

l(s) l(a 0.130 1.13

4.08

FACP

1 QUANTITY STAND-BY ALARM

(mA)

l(s) l(a) 0.130 0.545

3.91

7.0

STAND-BY ALARM QUANTITY STAND-BY ALARM

PANEL

(mA) (mA)

PANEL

PANEL

PANEL

STAND-BY ALARM

(mA) (mA)

CPS-610

EYBOARD DISPLAY

KISTING SMOKE DETECTORS
KISTING HEAT DETECTORS

OTALS (AMPS):

Battery to be provided -

BCSD OWENS PRIMARY()

"DPM-S" POWER & BATTERY CALCULATION

FIRE ALARM REMOTE POWER SUPPLY

SPEAKER/STROBE INTERIOR CEILING 75cd SPEAKER/STROBE INTERIOR CEILING 30cd SPEAKER/STROBE INTERIOR CEILING 15cd

SPEAKER/STROBE INTERIOR WALL MOUNT 15c SPEAKER/STROBE INTERIOR WALL MOUNT 75c

Amp Hour:

DESCRIPTION

TOTALS (AMPS):

Battery to be provided -

BCSD OWENS PRIMARY()

"DPM-T" POWER & BATTERY CALCULATION

FIRE ALARM REMOTE POWER SUPPLY
SPEAKER/STROBE INTERIOR CEILING 95cd
SPEAKER/STROBE INTERIOR CEILING 75cd

PEAKER/STROBE INTERIOR CEILING 30cd PEAKER/STROBE INTERIOR CEILING 15cd

SPEAKER/STROBE INTERIOR WALL MOUNT 15cd SPEAKER/STROBE INTERIOR WALL MOUNT 75cd

Amp Hour:

DEVICE

DESCRIPTION

DTALS (AMPS):

Battery to be provided -

BCSD OWENS PRIMARY()

"DPM-A" POWER & BATTERY CALCULATION

FIRE ALARM REMOTE POWER SUPPLY
SPEAKER/STROBE INTERIOR CEILING 95cd
SPEAKER/STROBE INTERIOR CEILING 75cd
SPEAKER/STROBE INTERIOR CEILING 30cd
SPEAKER/STROBE INTERIOR CEILING 15cd

SPEAKER/STROBE INTERIOR WALL MOUNT 15cc SPEAKER/STROBE INTERIOR WALL MOUNT 75cc

Amp Hour:

DEVICE

DESCRIPTION

OTALS (AMPS):

Battery to be provided -

Amp Hour:

AGENCY INFORMATION:

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BESSIE OWENS E.S. TEMPORARY **MODULAR BUILDINGS**

815 POTOMAC AVE. BAKERSFIELD, CA 93307 OPSC or OSHPD PROJ. NO: 118932 PROJECT NO: DRAWN BY: V.Z. CHK'D BY: D.F. ISSUE DATE: 8/19/2019 SHEET TITLE

> FIRE ALARM VOLTAGE DROP AND BATTERY CALCULATIONS

SHEET NUMBER

STROBE CIRCUIT VOLTAGE DROP CALCULATIONS "FACP" POWER & BATTERY CALCULATION LENGTH DC TOTAL FROM POWER TOTAL VOLTAGE MINIMUM BATTERY TYPE & SIZE RESIST. ALARM SUPPLY TO VD DROP BATTERY SELECTED LOCATED IN FA. DOOR WALL WALL BELL HOLDER 15cd 75cd 15cd 30cd 75cd 95cd /1000' CURRENT MIDDLE OF SUPPLY# Alarm Current - I(a) (Amp) FEET VOLTS % .03 | 0.02 | 0.043 | 0.107 | 0.041 | 0.063 | 0.111 | 0.134 | AWG | OHMS | AMPS DESCRIPTION BATTERY FIRE ALARM CONTROL PANEL LCD-160 (BACKLIGHT OFF) CALCS

STROBE CIRCUIT VOLTAGE DROP CALCULATIONS

						DEVIC	ES				w	IRE		ONE-WAY LOOP				
POWER	LOCATED IN	LOOP TYPE & No.	FA.	DOOR HOLDER	1 1				OBES	95cd	SIZE	DC RESIST. /1000'	í	LENGTH FROM POWER SUPPLY TO MIDDLE OF	TOTAL VD	VOLTAGE DROP	MINIMUM BATTERY SIZE	BATTERY SELECTED
SUPPLY#			0.03	0.02	Alarm	Current	- I(a) (A	mp)	0.111		AWG	OHMS	AMPS	FEET FEET	VOLTS	%	AH	AH
DPM-T		V1	CANADA INCIDENTAL			1	3			1	12	1.93	0.364	273	0.384	1.60	SI	E
		V2				3					12	1.93	0.321	213	0.264	1.10	DPI	M-T
		V3				3					12	1.93	0.321	297	0.368	1.53	BATT	ΓERY
		V4									12						CAI	LCS
											12							
											12	1.93					1.87	4.0
											12	1.93						
											12							
											12	1.93						

						DEVI	CES				w	IRE		ONE-WAY LOOP				
POWER	LOCATED IN	LOOP TYPE &	FA.	DOOR	WALL	WALL			BES		SIZE	DC RESIST.	ALARM	LENGTH FROM POWER SUPPLY TO	TOTAL VD	VOLTAGE DROP	BATTERY	BATTERY
SUPPLY#		No.	BELL	HOLDER		75cd Current	15cd t - I(a) (A	30cd	75cd	95cd		/1000'	CURRENT	MIDDLE OF			SIZE	
			0.03	0.02				0.063	0.111	0.134	AWG	OHMS	AMPS	FEET	VOLTS	%	AH	AH
DPM-A		V1		A SECURIO DE LA CASA DEL CASA DE LA CASA DEL CASA DE LA	2			, C. C. 1 C. 1 Part, 51 C. A.	1		12	1.93	0.197	85	0.065	0.27	S	ĒE
		V2							1		12	1.93	0.111	215	0.092	0.38	DP	PM-A
		V3				1					12	1.93	0.107	169	0.070	0.29	BAT	TERY
		V4									12	1.93					CA	LCS
											12	1.93						
											12	1.93					1.87	4.0
											12	1.93						
											12							
1	į.										12	1.93						I

FORMULAS USED FOR CALCULATIONS:

FORMULA FOR BATTERY SIZING: FOR FACP/FAPS/DPM - 24 HOURS STANDBY & 15 MIN IN ALARM:

AMP HOUR = 1.20 [(24 HOURS X I(S)) + (15/60 HOUR X I(A))]

WHERE, 1.20 = BATTERY DERATING VALUE I(S) = TOTAL SUPERVISORY CURRENT (O FOR NOTIFICATION DEVICES AND 48 mA FOR FCPS-24) I(A) = TOTAL ALARM CURRENT

FORMULA FOR VOLTAGE DROP CALCULATIONS

TOTAL DC RESISTANCE = # OF WIRES X Rdc/1000 X ONE-WAY LOOP LENGTH FROM POWER SUPPLY TO MIDDLE OF LOAD

TOTAL VD = TOTAL DC RESISTANCE X TOTAL ALARM CURRENT

MINIMUM VOLTAGE AT DEVICES = 20.4V - TOTAL VD 20.4V = MINIMUM VOLTAGE AT END OF USEFUL BATTERY LIFE (85% OF 24VDC)

NOTE: THE MANUFACTURER'S OPERATING VOLTAGE IS BETWEEN 16VDC AND 33 VDC (FOR 24VDC NOMINAL)

l(s) l(a) 0.130 1.04

BCSD OWENS PRIMARY()

ESCRIPTION

OTALS (AMPS):

attery to be provided -

"DPM-BLDG H" POWER & BATTERY CALCULATION

STING INTERIOR HORN STING INTERIOR STROBE 15cd

PANEL

4.06

7.0

Application Drawing APP-02 Field Wiring Guidelines

The speaker circuits of most voice evacuation systems will typically be classified as power limited wiring. As such, these speaker circuits can be run with other fire alarm

No special cabling is required for the speaker circuits. Standard FPL or FPLP wire is

There is one exception, however. Certain addressable systems may generate extraneous noise from their addressable loop, and cannot be run using shielded cable. In this case, shielding of the evacuation speaker circuit will help to eliminate noise picked up by and heard in speakers during standby operation, and possible interference

Generally, #18 AWG will be adequate for speaker circuits. The only time that heavier wire is needed is when load is high, and wire runs are long. But remember, it never hurts to go with heavier wire. So if a #16 or #14 AWG pair is being pulled for strobes, it is often easier and

The table below illustrates typical wire lengths for specific wire gauge and speaker load:*

At 25VRM	/IS Output:			
Power	#18 AWG	#16AWG	#14 AWG	#12AWG
10W	1,900	3,050	4,850	7,700
15W	1,280	2,030	3,230	5,140
25W	760	1,220	1,930	3,080
At 70VRM	/IS Output:			
Power	#18 AWG	#16AWG	#14 AWG	#12AWG
10W	15,200	24,200	38,360	61,100
15W	10,130	16,130	25,570	40,730
25W	6,080	9,680	15,340	24,440
	-	•		

* This table assumes that there is an even distribution of the speaker load on the speaker circuit, and that a 20% drop at the last device is allowable. If an even distribution of load is not the case, reduce all wire runs by 1/2.

SPEAKER CIRCUIT WIRING GUIDELINES

SPEAKER CIRCUIT WATTAGE AND CIRCUIT LENGTH INFORMATION


FOR #16 AWG CONDUCTORS AT A 10W LOAD.

NOT TO SCALE

SPEAKER CIRCUIT OPERATING VOLTAGE = 25V RMS
SPEAKER CIRCUIT A1 LOAD = 27.25 WATTS
APPROXIMATE LENGTH OF SPEAKER CIRCUIT A1 = 1,803 FEET
REFER TO SPEAKER CIRCUIT WIRING GUIDELINES. A MAXIMUM SPEAKER CIRCUIT LENGTH OF 1,930 FEET IS ALLOWED
FOR #14 AWG CONDUCTORS AT A 25W LOAD. SPEAKER CIRCUIT A2 LOAD = 9.5 WATTS
APPROXIMATE LENGTH OF SPEAKER CIRCUIT A2 = 1,500 FEET
REFER TO SPEAKER CIRCUIT WIRING GUIDELINES. A MAXIMUM SPEAKER CIRCUIT LENGTH OF 3,050 FEET IS ALLOWED

Wire Type: wiring without ill effects. sufficient. Twisted pair or shielding twisted pair wiring is not necessary. with the addressable loop. Wire Gauge: less costly to pull the same wire for the evacuation speaker circuits.



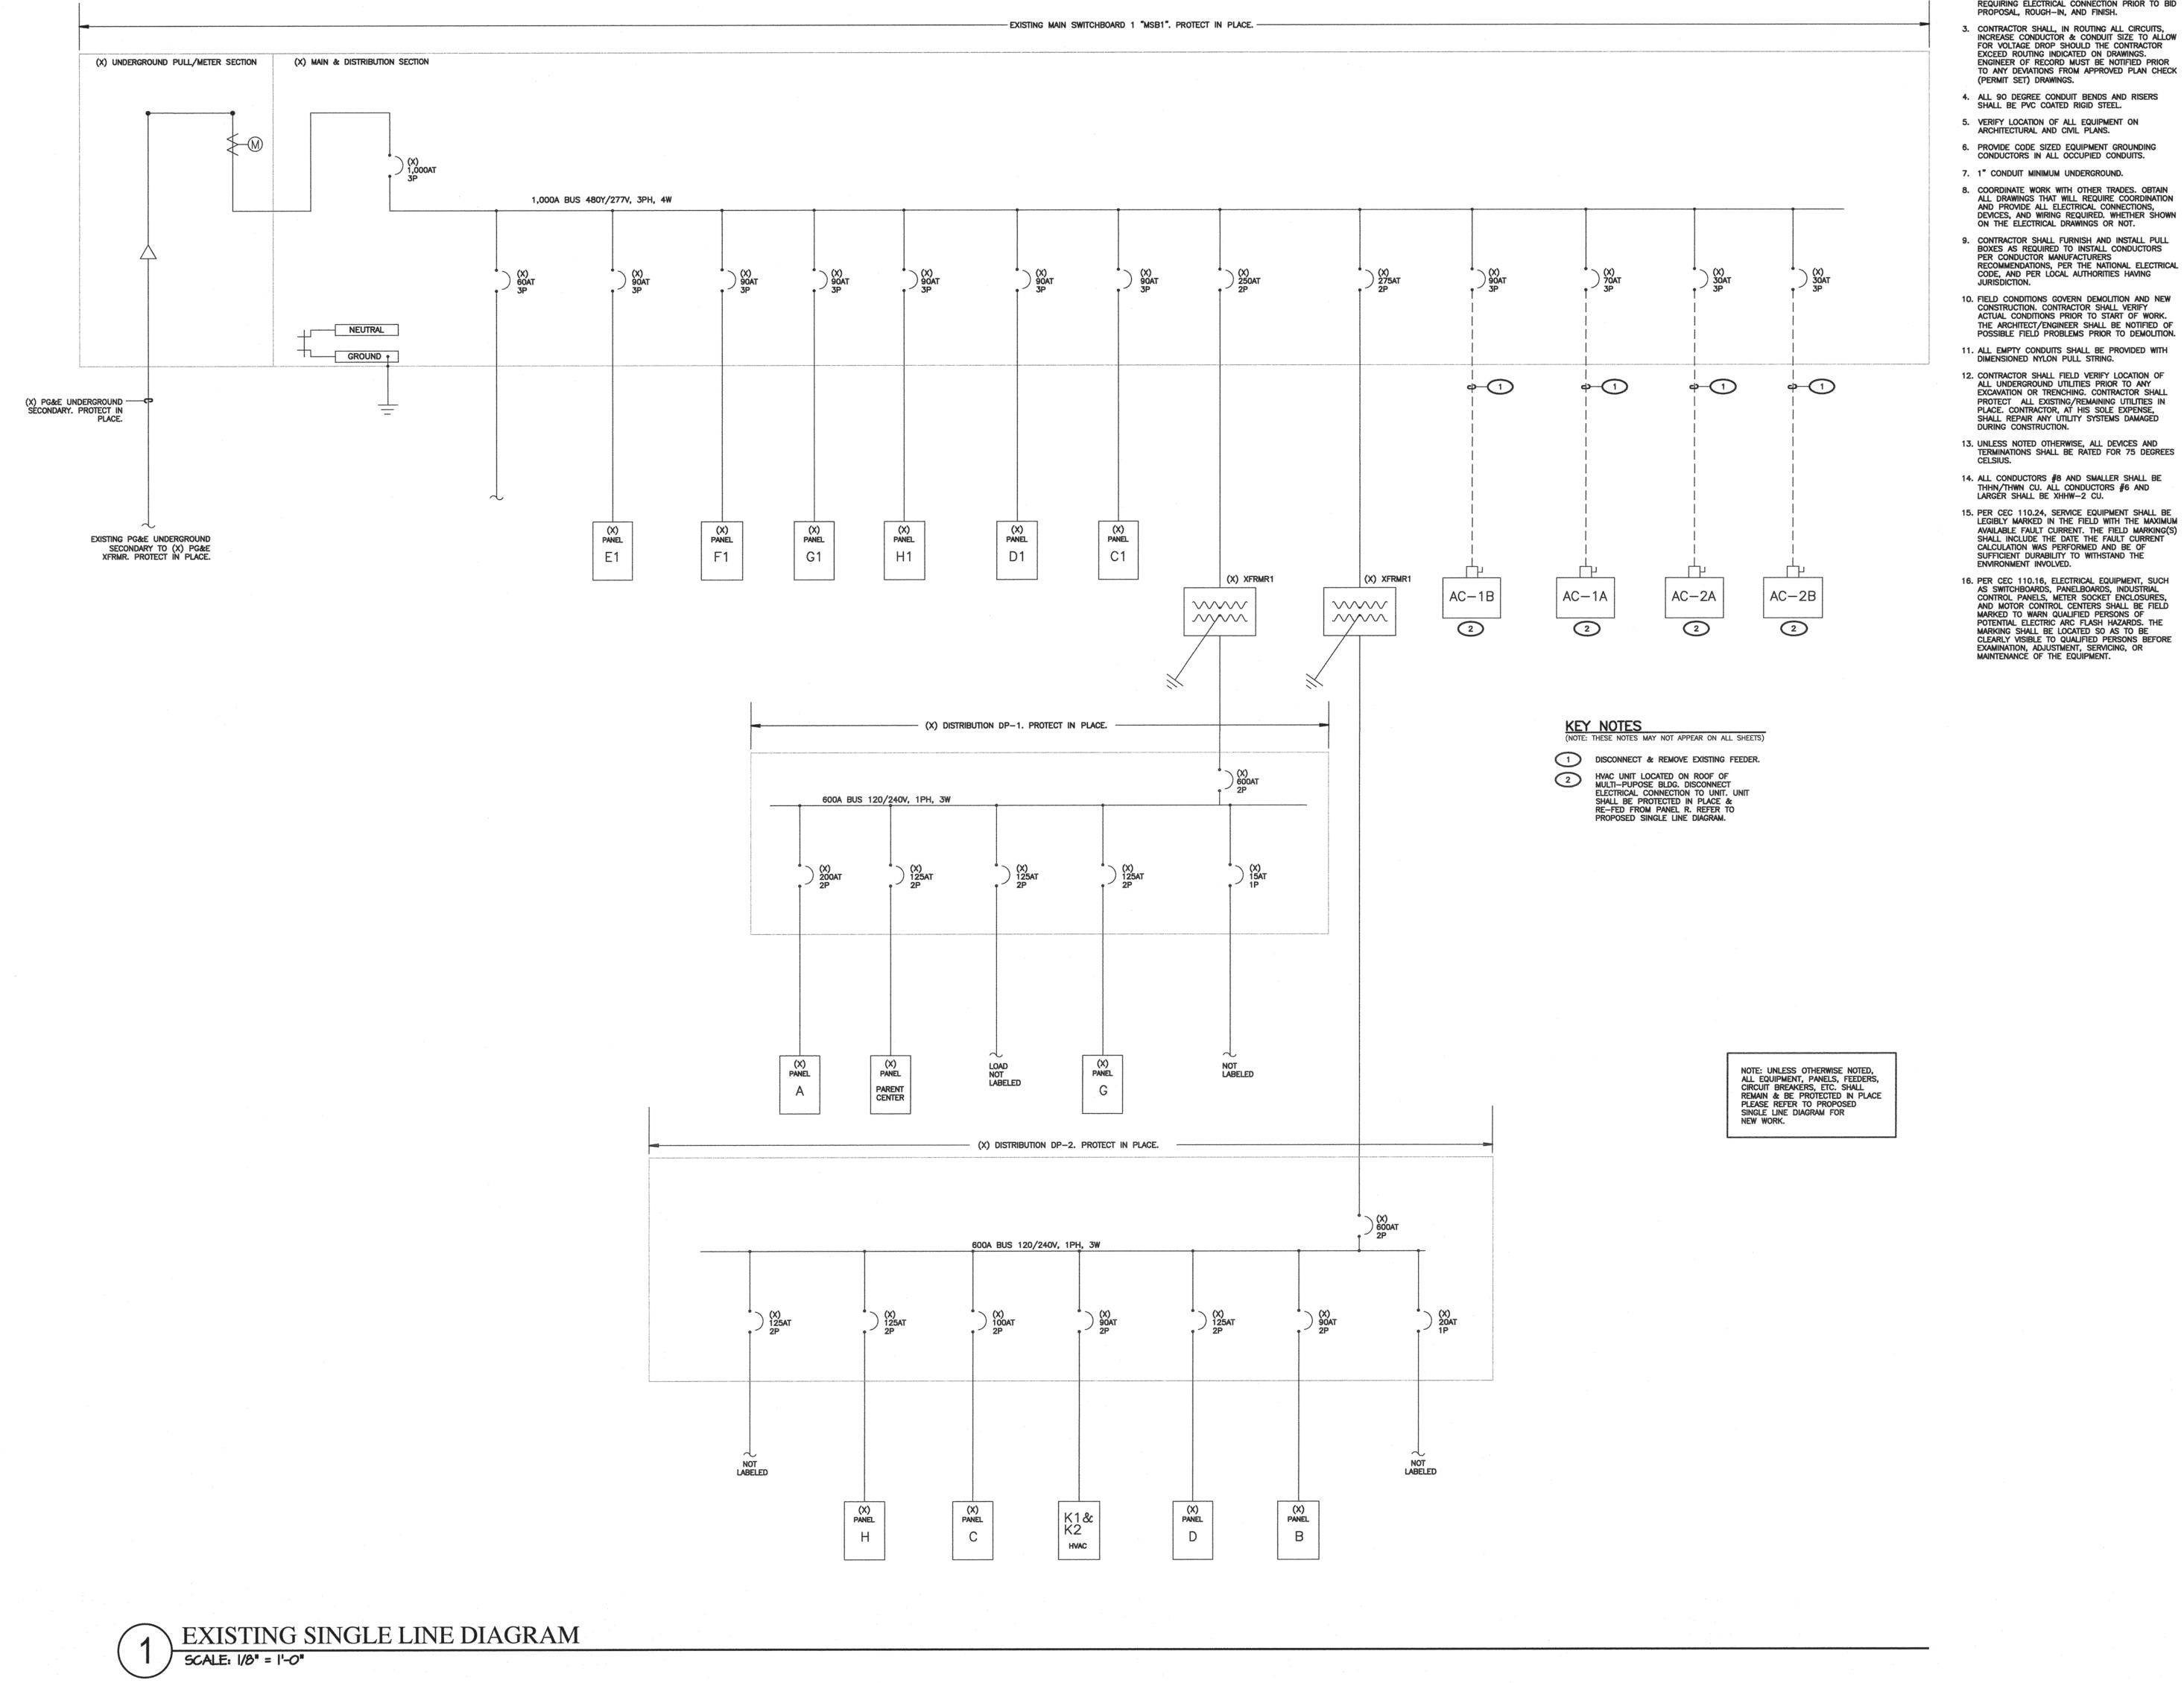

SHEET NOTES

- 1. VERIFY LOCATION OF ALL BUILDINGS AND APPENDITURES ON ARCHITECTURAL AND CIVIL
- 2. CONTRACTOR SHALL VERIFY LOCATION & REQUIREMENTS OF ALL DEVICES/EQUIPMENT REQUIRING ELECTRICAL CONNECTION PRIOR TO BID
- PROPOSAL, ROUGH-IN, AND FINISH. CONTRACTOR SHALL, IN ROUTING ALL CIRCUITS, INCREASE CONDUCTOR & CONDUIT SIZE TO ALLOW FOR VOLTAGE DROP SHOULD THE CONTRACTOR EXCEED ROUTING INDICATED ON DRAWINGS.
- 4. ALL 90 DEGREE CONDUIT BENDS AND RISERS
- SHALL BE PVC COATED RIGID STEEL.
- VERIFY LOCATION OF ALL EQUIPMENT ON ARCHITECTURAL AND CIVIL PLANS.
- 7. 1" CONDUIT MINIMUM UNDERGROUND.
- ON THE ELECTRICAL DRAWINGS OR NOT. 9. CONTRACTOR SHALL FURNISH AND INSTALL PULL BOXES AS REQUIRED TO INSTALL CONDUCTORS PER CONDUCTOR MANUFACTURERS RECOMMENDATIONS, PER THE NATIONAL ELECTRICAL CODE, AND PER LOCAL AUTHORITIES HAVING
- 10. FIELD CONDITIONS GOVERN DEMOLITION AND NEW CONSTRUCTION. CONTRACTOR SHALL VERIFY ACTUAL CONDITIONS PRIOR TO START OF WORK. THE ARCHITECT/ENGINEER SHALL BE NOTIFIED OF POSSIBLE FIELD PROBLEMS PRIOR TO DEMOLITION.
- ALL EMPTY CONDUITS SHALL BE PROVIDED WITH DIMENSIONED NYLON PULL STRING. 12. CONTRACTOR SHALL FIELD VERIFY LOCATION OF ALL UNDERGROUND UTILITIES PRIOR TO ANY EXCAVATION OR TRENCHING. CONTRACTOR SHALL
- UNLESS NOTED OTHERWISE, ALL DEVICES AND TERMINATIONS SHALL BE RATED FOR 75 DEGREES CELSIUS.
- 14. ALL CONDUCTORS #8 AND SMALLER SHALL BE THHN/THWN CU. ALL CONDUCTORS #6 AND LARGER SHALL BE XHHW-2 CU.
- 15. PER CEC 110.24, SERVICE EQUIPMENT SHALL BE LEGIBLY MARKED IN THE FIELD WITH THE MAXIMUM AVAILABLE FAULT CURRENT. THE FIELD MARKING(S)
 SHALL INCLUDE THE DATE THE FAULT CURRENT
 CALCULATION WAS PERFORMED AND BE OF
 SUFFICIENT DURABILITY TO WITHSTAND THE ENVIRONMENT INVOLVED.
- 16. PER CEC 110.16, ELECTRICAL EQUIPMENT, SUCH AS SWITCHBOARDS, PANELBOARDS, INDUSTRIAL CONTROL PANELS, METER SOCKET ENCLOSURES, AND MOTOR CONTROL CENTERS SHALL BE FIELD MARKED TO WARN QUALIFIED PERSONS OF POTENTIAL ELECTRIC ARC FLASH HAZARDS. THE MARKING SHALL BE LOCATED SO AS TO BE CLEARLY VISIBLE TO QUALIFIED PERSONS BEFORE EXAMINATION, ADJUSTMENT, SERVICING, OR MAINTENANCE OF THE EQUIPMENT.

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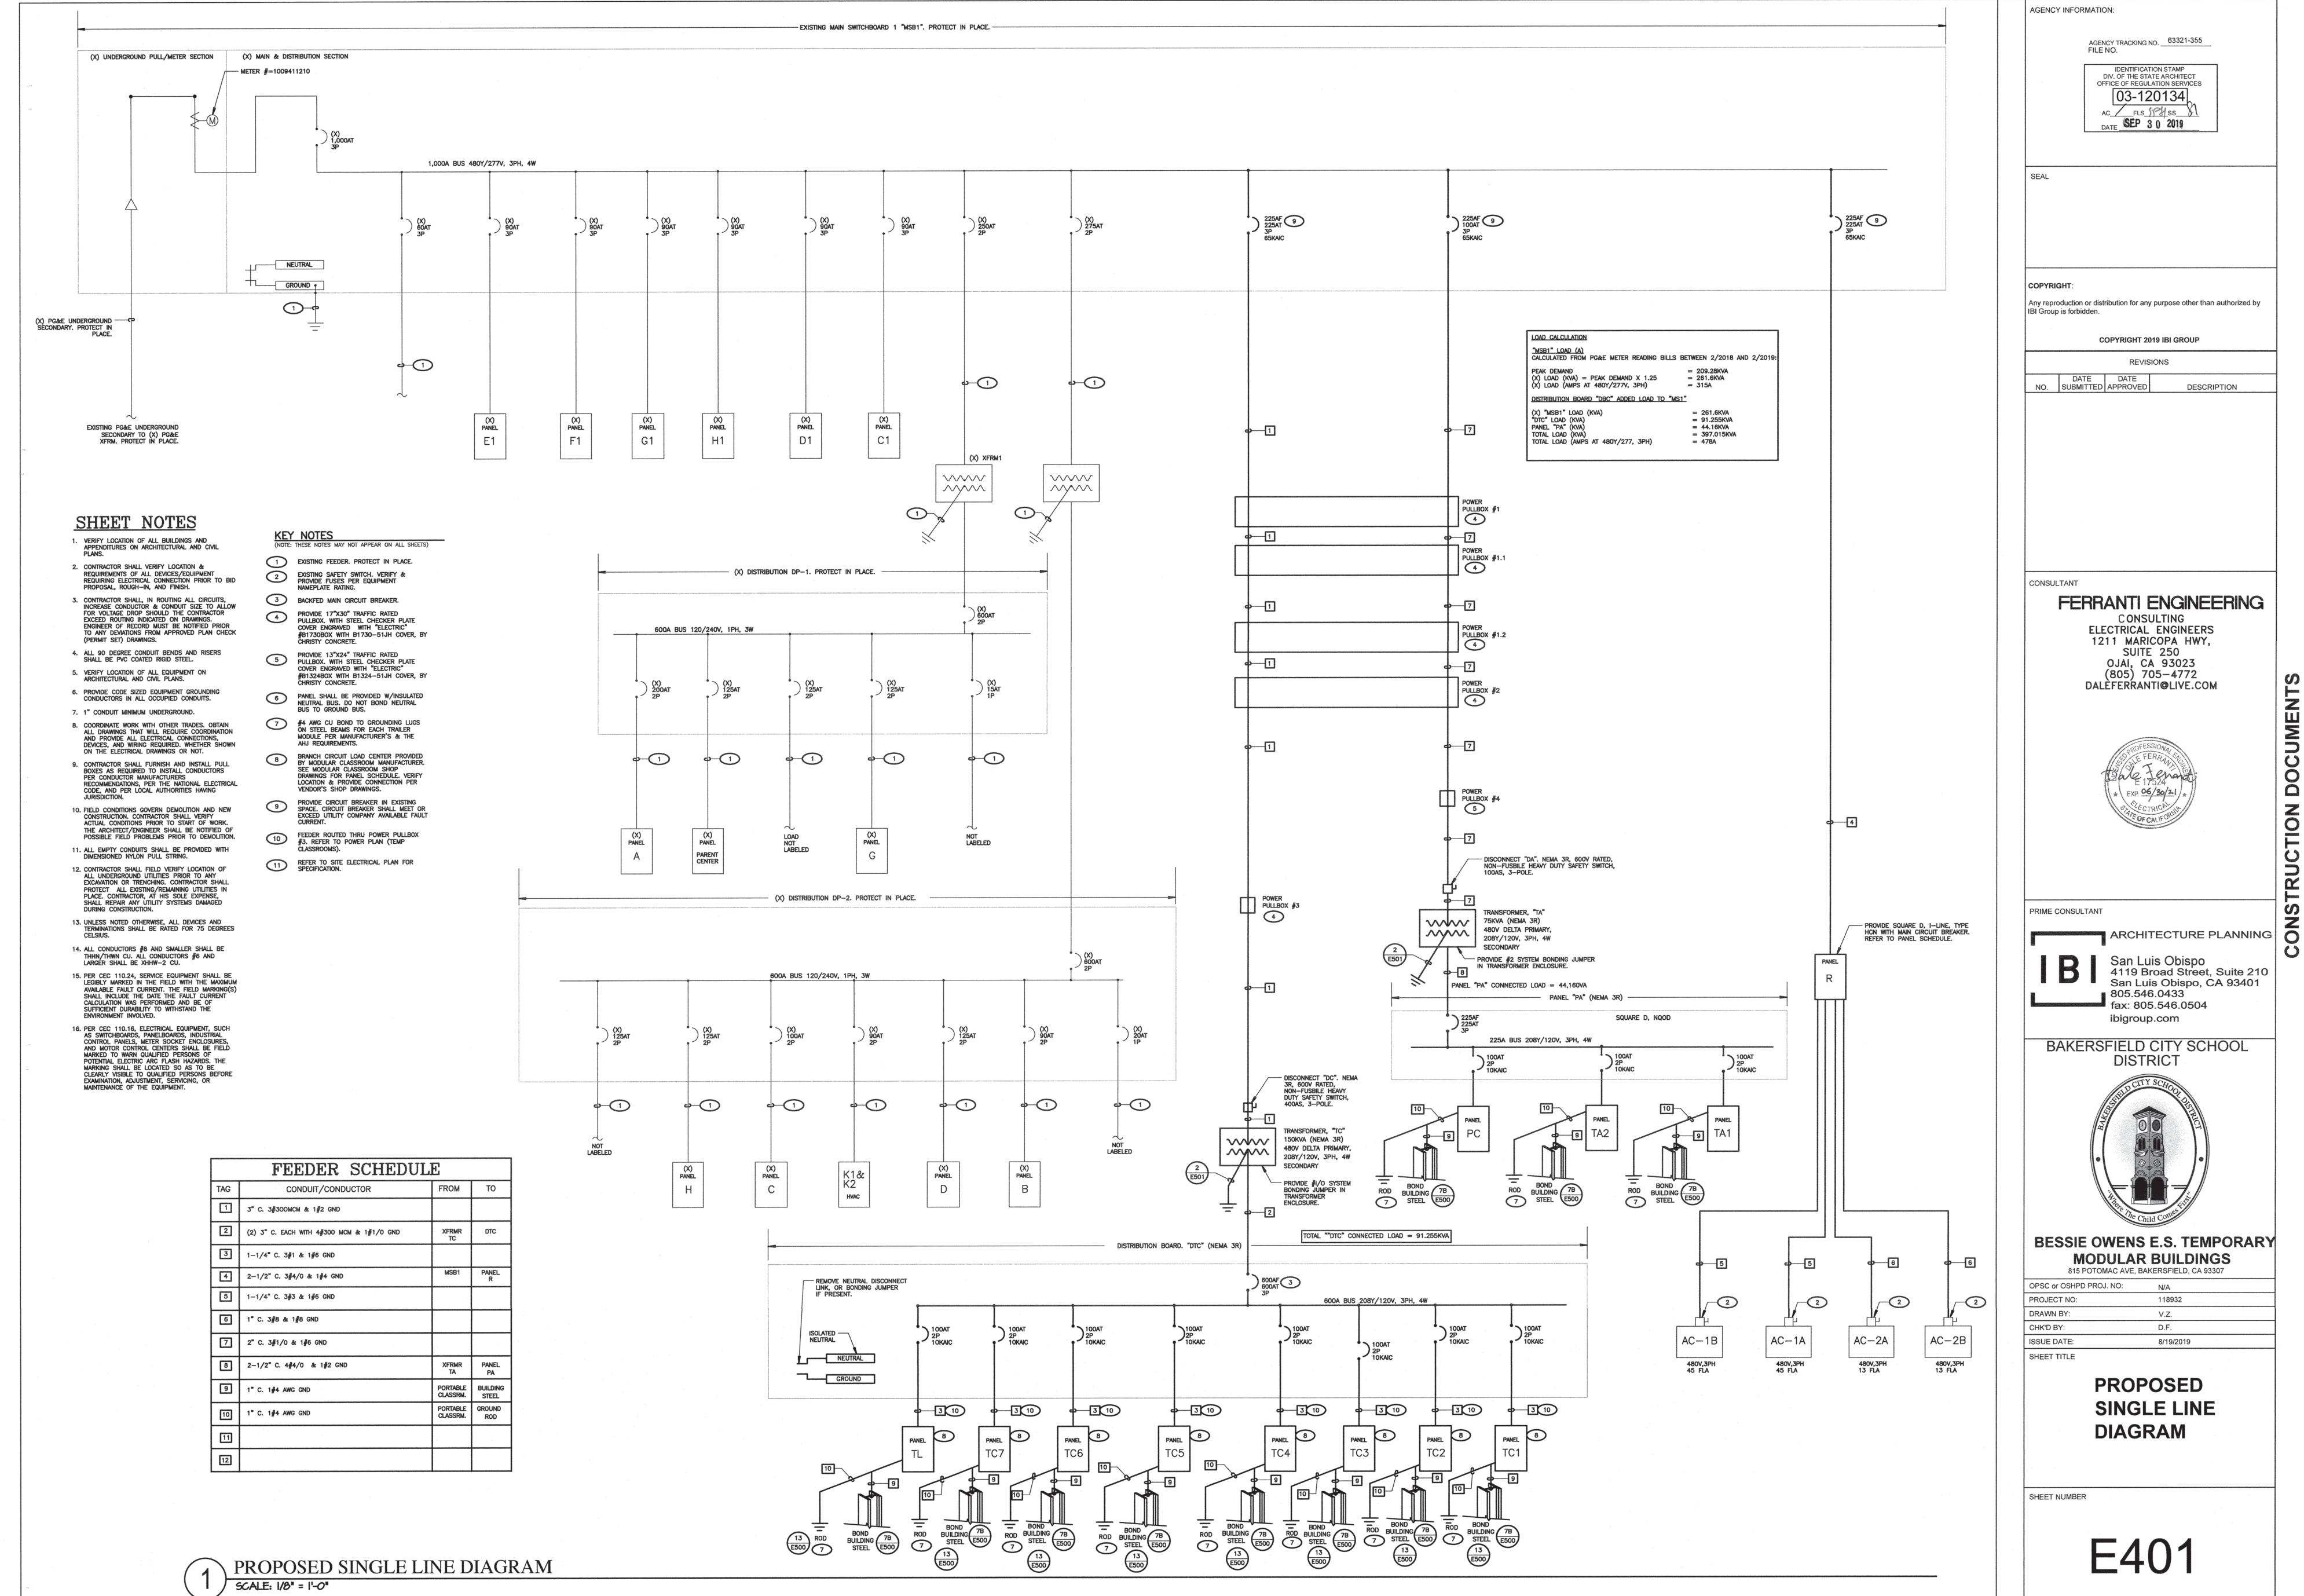


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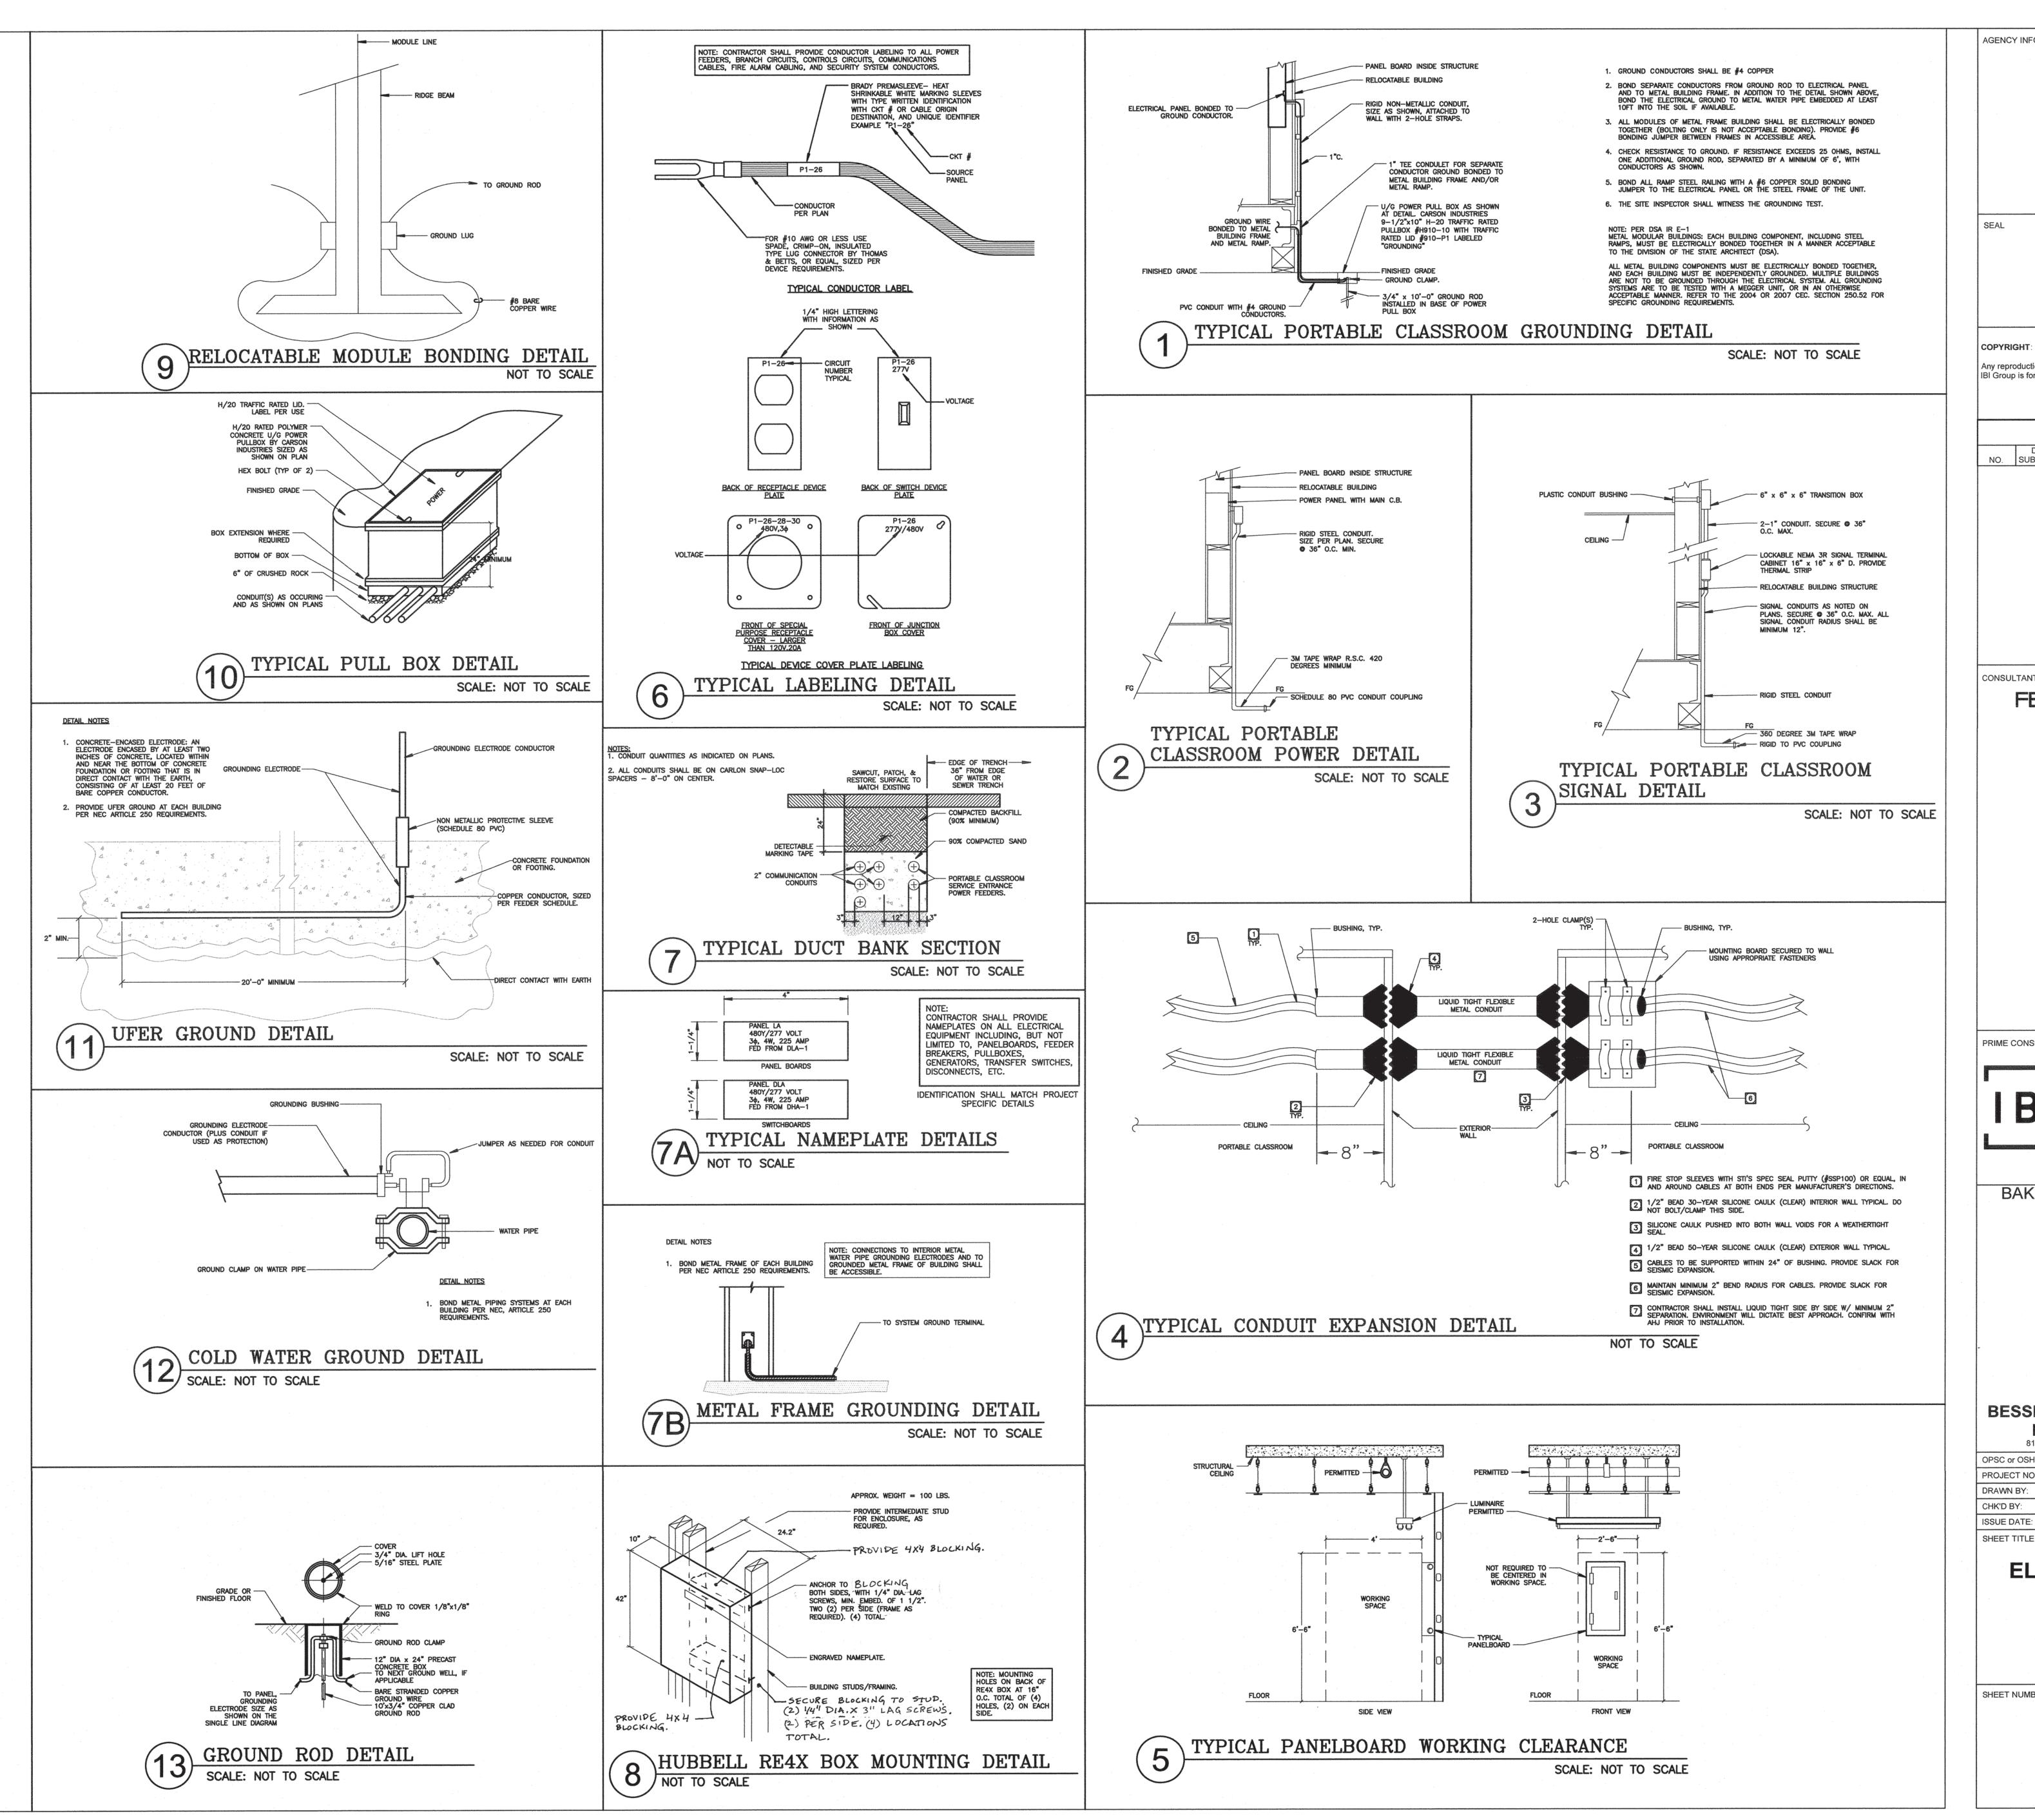
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> **EXISTING** SINGLE LINE **DIAGRAM**

SHEET NUMBER



O **IRUCTION**



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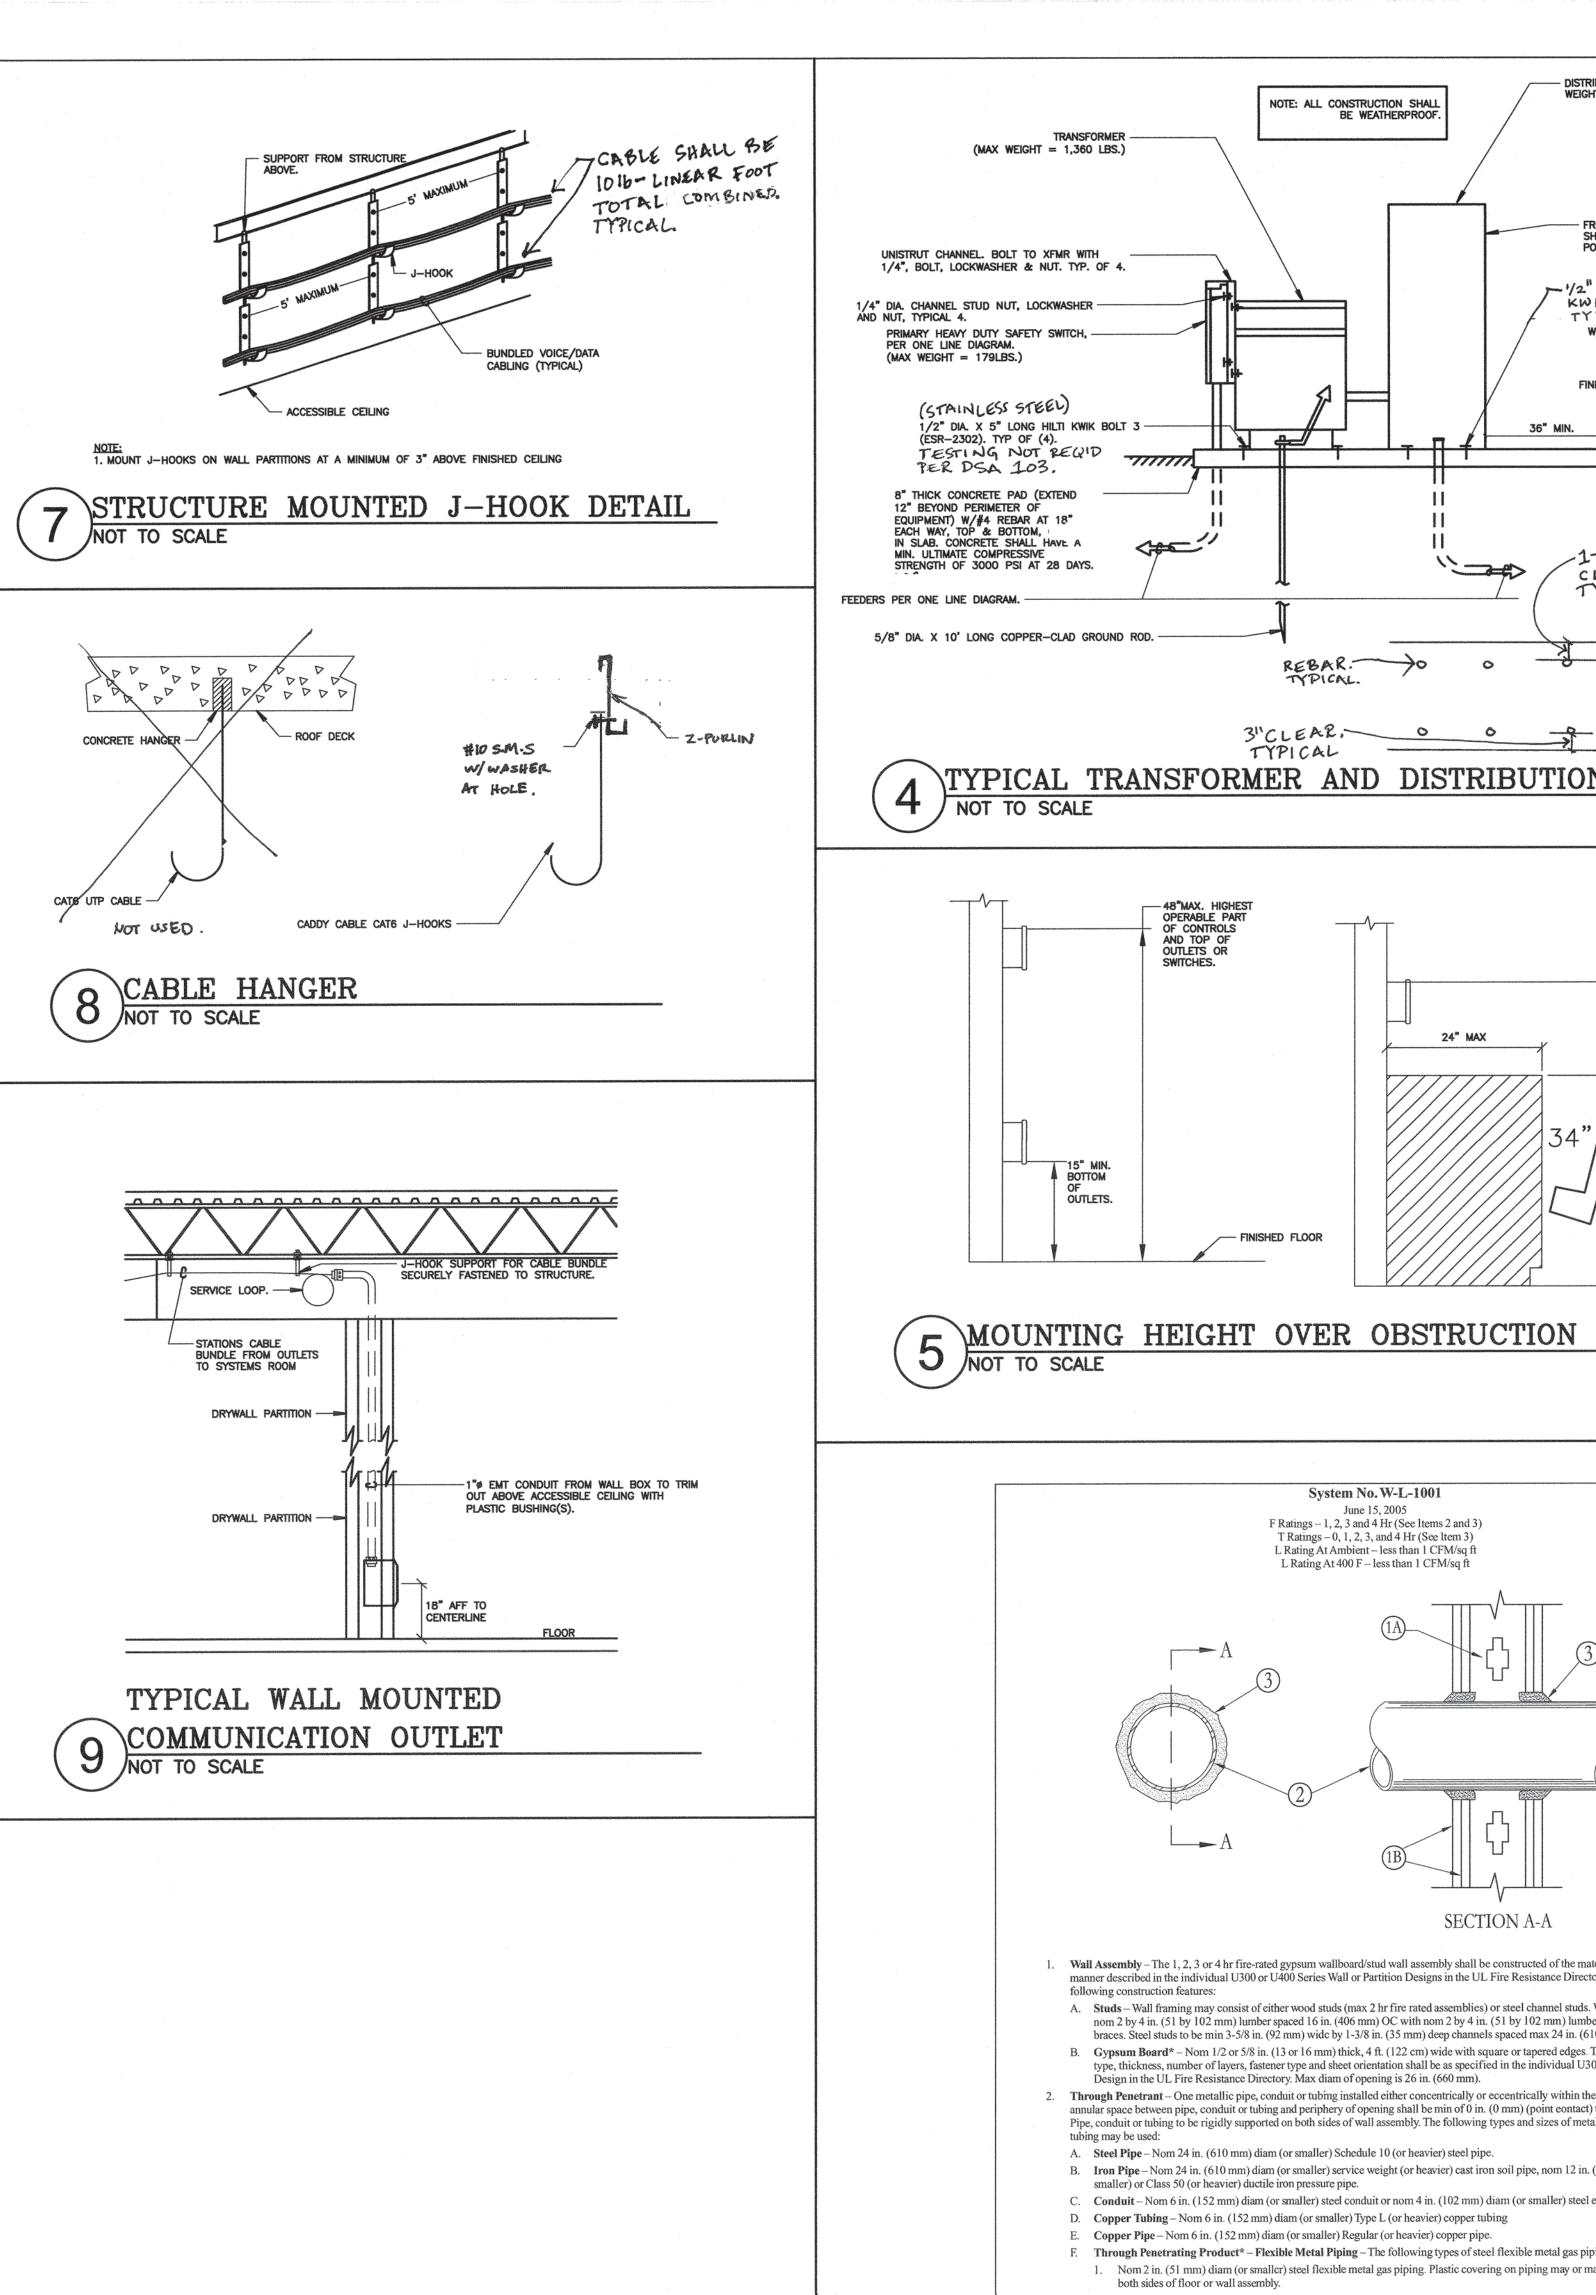



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	OPSC or OSHPD PROJ. NO:	N/A	
	PROJECT NO:	118932	
	DRAWN BY:	V.Z.	
	CHK'D BY:	D.F.	-
-	ISSUE DATE:	8/19/2019	


ELECTRICAL DETAILS

SHEET NUMBER




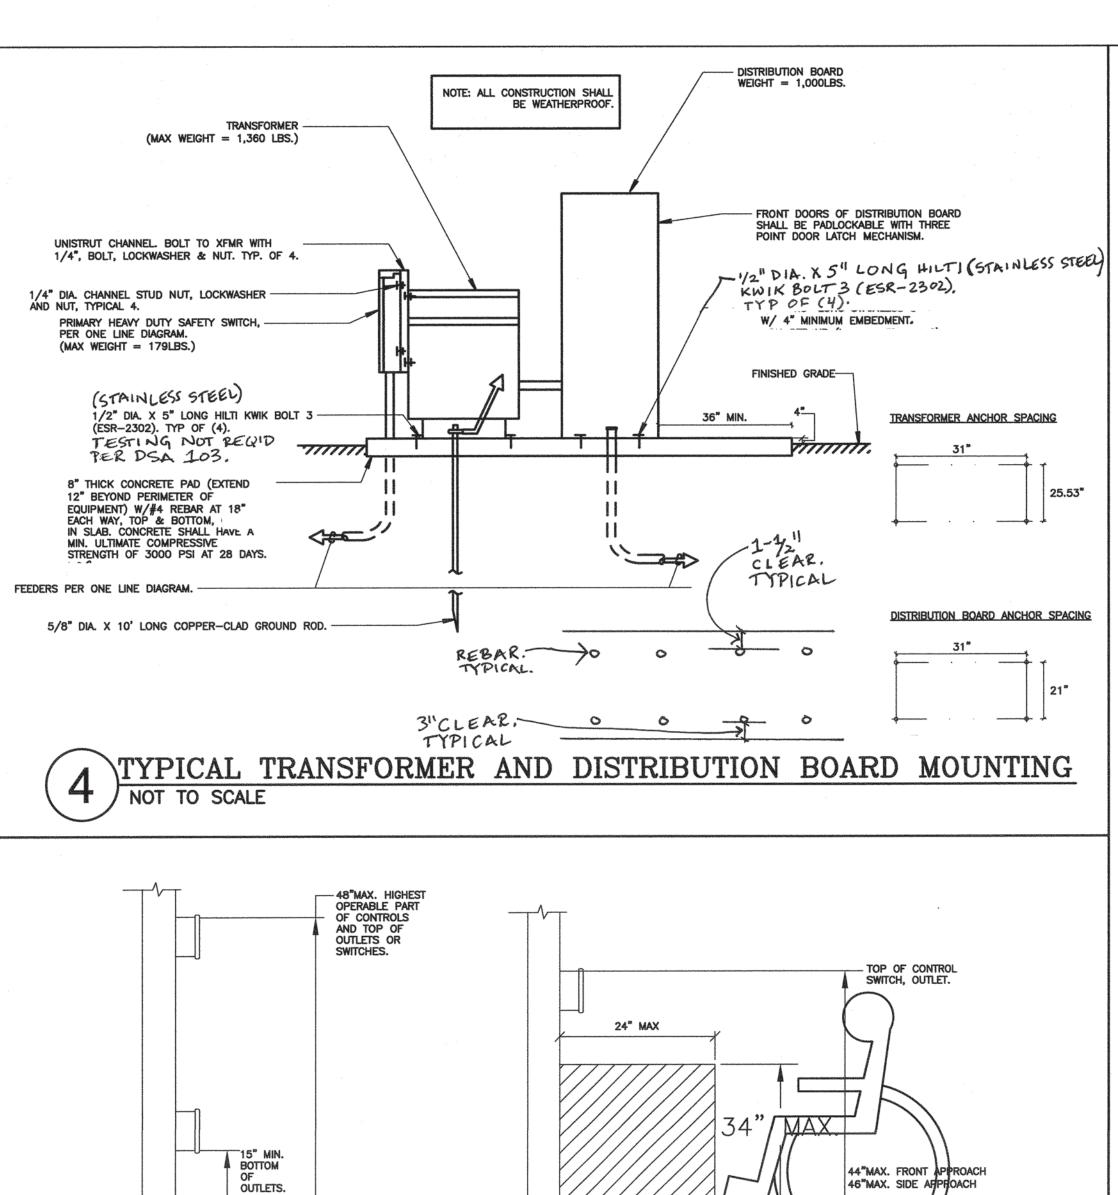


- FINISHED FLOOR

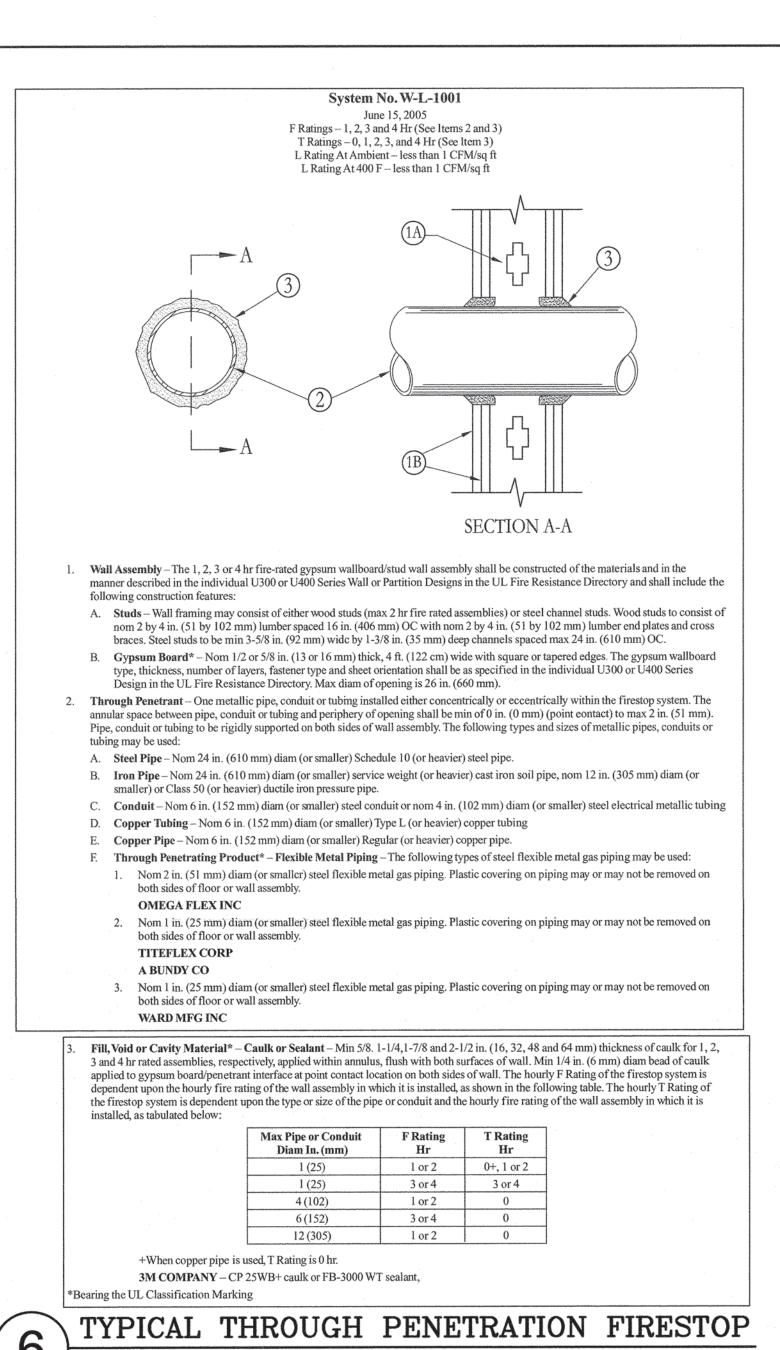


SCALE: NOT TO SCALE

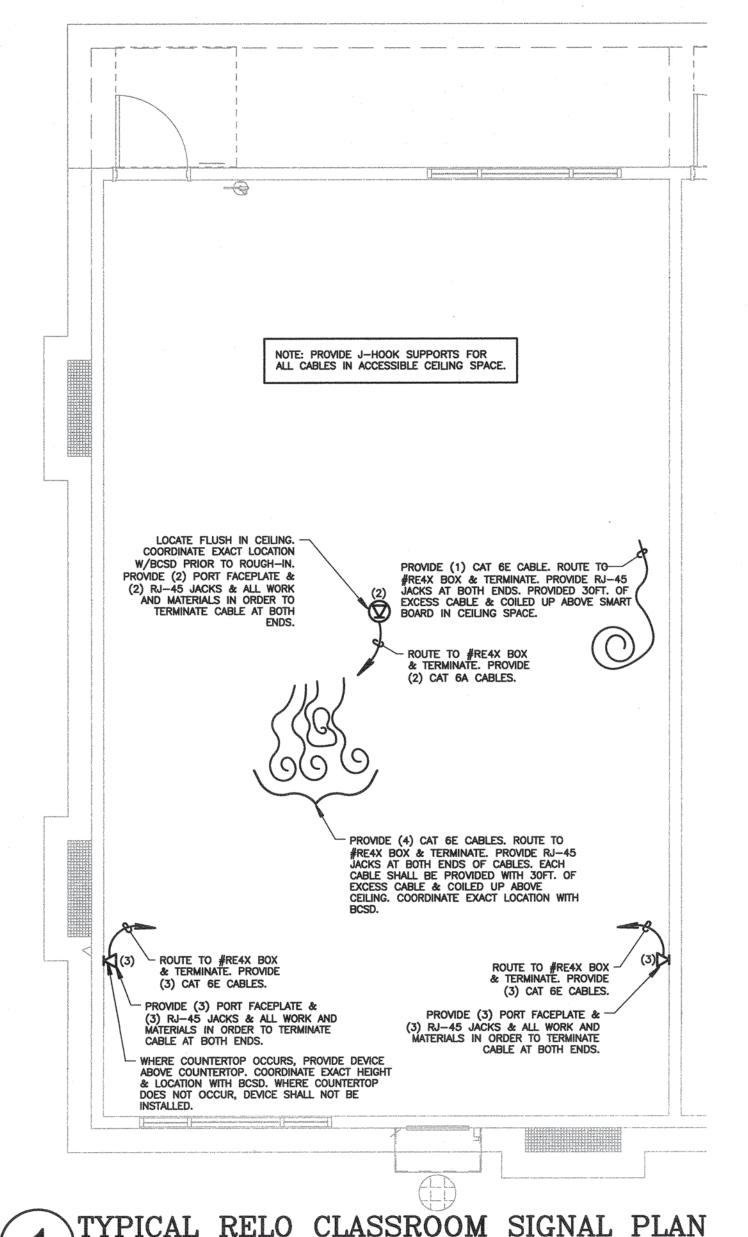


TYPICAL RELO CLASSROOM SIGNAL PLAN NOT TO SCALE

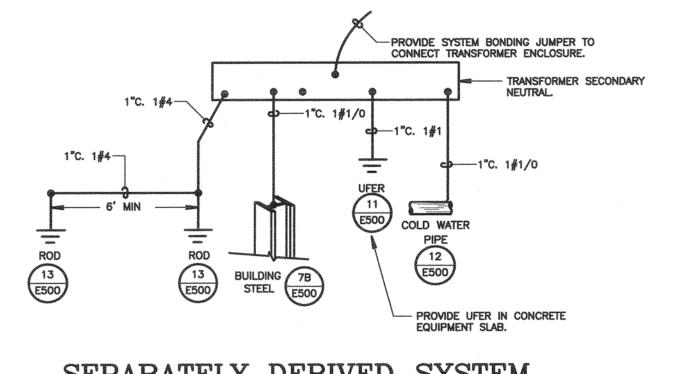

SEPARATELY DERIVED SYSTEM GROUNDING & BONDING SCALE: NOT TO SCALE

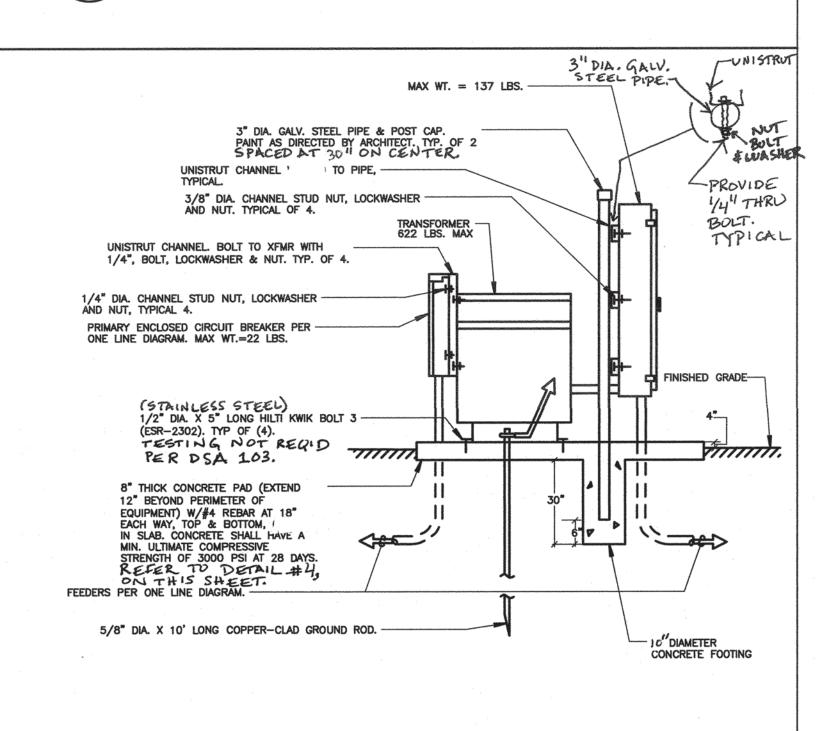

TYPICAL TRANSFORMER AND PANEL MOUNTING $(3)^{\frac{TYPICAL}{NOT}}$ TO SCALE

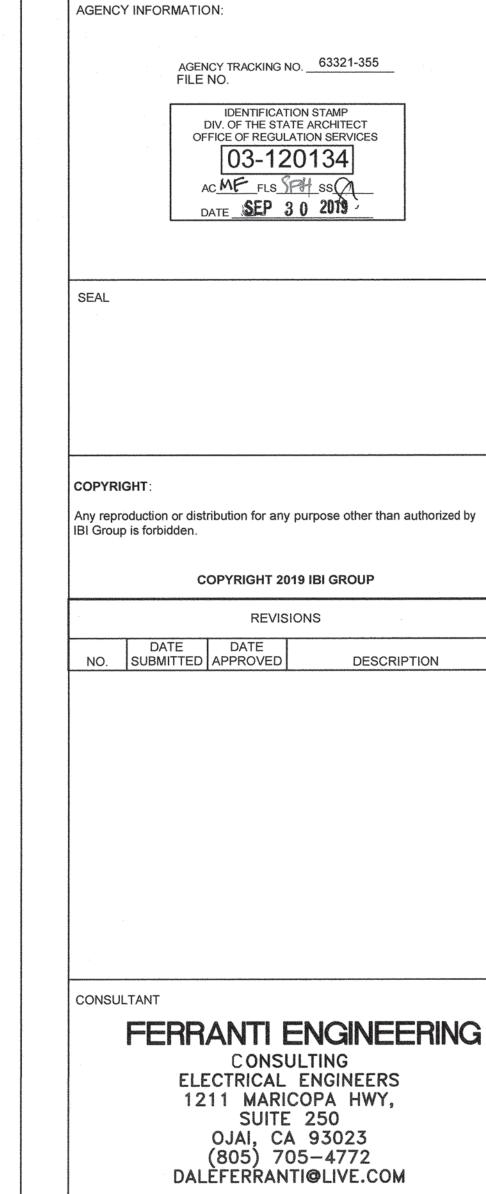

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