## (1) PERMANENT MODULAR TK CLASSROOM BUILDING

### DOUGLAS K FLETCHER ELEMENTARY SCHOOL

9801 HIGHLAND KNOLLS DR, BAKERSFIELD, CA 93306

#### **FOR BAKERSIELD CITY SCHOOL DISTRICT**

BAKERSIELD CITY SCHOOL DISTRICT							
GENERAL NOTES	CODE REQUIREMENTS	PROJECT INFORMATION	PROJECT DIRECTORY	SHEET INDEX	5500 Ming Avenue, Suite 280 o: (6) Bakersfield, CA 93309 f: (6) www.ordizmelby.com		
THE DRAWINGS, IDEAS AND DESIGNS REPRESENTED HEREIN ARE THE PROPERTY OF THE ARCHITECT.	ALL DRAWINGS AND CONSTRUCTION SHALL CONFORM TO THE FOLLOWING CODES: TITLE 19 CCR, PUBLIC SAFETY, STATE FIRE MARSHAL REGULATIONS	(1) PERMANENT MODULAR TK CLASSROOM BUILDING  CONSTRUCTION TYPE: TYPE VB	ARCHITECT OWNERS REP Ordiz Melby Architects, Inc.  OWNERS REP BAKERSIELD CITY SCHOOL DISTRICT	GENERAL INFORMATION  G-001 GENERAL INFORMATION DSA PORTABLES	MANUEL MALDONADO JR. C-36294  O, DECEMBER 31, 2023		
2. THE DRAWINGS AND SPECIFICATIONS ARE INTENDED TO CONVEY AN OVERALL DESCRIPTION OF THE PROJECT IN SUFFICIENT DETAIL FOR ITS COMPLETE CONSTRUCTION. SOME CONDITIONS, WHICH ARE COMMONLY ENCOUNTERED IN CONSTRUCTION OF THIS TYPE AND/OR CONDITIONS WHICH RELATE TO SPECIFIC PRODUCTS OR PROCESSES, MAY NOT BE SPECIFICALLY DETAILED IN THESE PLANS. ALL	2022 TITLE 24 CCR, PART 1 - 2022 BUILDING STANDARDS ADMINISTRATIVE CODE  2022 TITLE 24 CCR, PART 2 - 2022 CALIFORNIA BUILDING CODE, VOL. 1 & 2 (CBC) (2021 IBC, AS AMENDED BY CA)	OCCUPANCY GROUP: GROUP E - LOAD FACTOR 20 NET OCCUPANCY LOAD PER CLASSROOM: 960SF/20 SF/PERSON = 48 PERSONS BASIC ALLOWABLE AREA:	5500 Ming Avenue, Suite 280  Bakersfield, CA 93309  Phone: (661) 832-5258  Fax: (661) 832-4219  MANUEL MALDONADO JR.  1300 Baker St, Bakersfield, CA 93305  Phone: (661)631-4600  Fax: (661)326-1485  Mrs. Laura Guerrero-Salgado	ARCHITECTURAL DRAWINGS  A-111 FIRE ACCESS SITE PLAN	DANNY E. ORDIZ, AIA JEANINE S. BEF		
CONDITIONS NOT SPECIFICALLY DETAILED SHALL BE CONSTRUCTED COMPLETELY PER THE CURRENT STANDARDS OF THE APPROPRIATE INDUSTRY AND ANY APPLICABLE MANUFACTURER'S RECOMMENDATIONS.  3. NOTHING IN THE PLANS AND SPECIFICATIONS IS TO BE CONSTRUED TO PERMIT	2022 TITLE 24 CCR, PART 3 - 2022 CALIFORNIA ELECTRICAL CODE (CEC) (2020 NEC (NFPA), AS AMENDED BY CA)  2022 TITLE 24 CCR, PART 4 - 2022 CALIFORNIA MECHANICAL CODE (CMC) (2021 IAPMO UMC, AS AMENDED BY CA)	(2022 CBC TABLE 506.2):       9,500 SF         ACTUAL STORIES / HEIGHT:       1 / 15 FT         TOTAL SQUARE FOOTAGE:       5,670SF		A-120 FLOOR PLAN  A-131 REFLECTED CEILING PLAN  A-141 ROOF PLAN	MANUEL MALDONADO JR., AIA JAMES ARCHITECT C-36294 ARC ROBERT TROST, AIA JOSEPH ARCHITECT C-14762 ARC		
CONSTRUCTION IN CONFLICT WITH THE REQUIREMENTS OF ANY CODE, LAW ORDINANCE OR REGULATION.  4. "TYPICAL" MEANS IDENTICAL FOR ALL SAME CONDITIONS UNLESS OTHERWISE NOTED.	2022 TITLE 24 CCR, PART 5 - 2022 CALIFORNIA PLUMBING CODE (CPC) (2020 IAPMO UPC, AS AMENDED BY CA)	ALLOWABLE STORIES / HEIGHT: (2022 CBC TABLE 504.3) 1 / 40 FT		A-221 EXTERIOR ELEVATIONS  A-231 INTERIOR ELEVATIONS  A-232 INTERIOR ELEVATIONS	(1) PERMANE		
"SIMILAR" MEANS COMPARABLE CHARACTERISTICS FOR THE CONDITIONS NOTED. VERIFY DIMENSIONS AND ORIENTATION ON PLAN WITH THE ARCHITECT.  5. ALL PARTITIONS ARE DIMENSIONED TO CENTERLINE UNLESS OTHERWISE NOTED.	2022 TITLE 24 CCR, PART 6 - 2022 CALIFORNIA ENERGY CODE  2022 TITLE 24 CCR, PART 9 - 2022 CALIFORNIA FIRE CODE (CFC) (2021 IFC, AS AMENDED BY CA)	FLOOD ZONE FIRM#: 06029 C1825E EFF. 9/26/2008 FEMA FLOOD ZONE DESIGNATION: ZONE X COORDINATES: 35.391,-118.894		A-233 INTERIOR ELEVATIONS  A-234 DOOR & WINDOW SCHEDULES	MODULAR T CLASSROOM		
<ol> <li>DIMENSIONS ARE NOT ADJUSTABLE WITHOUT APPROVAL OF THE ARCHITECT, UNLESS OTHERWISE NOTED (+).</li> <li>DO NOT SCALE DRAWINGS. THE CONTRACTOR IS RESPONSIBLE TO FIELD VERIFY ALL DIMENSIONS.</li> </ol>	2022 TITLE 24 CCR, PART 10 - 2022 CALIFORNIA EXISTING BUILDING CODE (IEBC) (2021 INTERNATIONAL EXISTING BUILDING CODE, AS AMENDED BY CA)  2022 TITLE 24 CCR, PART 11 - 2022 GREEN BUILDING STANDARDS CODE	NAME VALUE DESCRIPTION  S <sub>S</sub> 0.89 MCE <sub>R</sub> GROUND MOTION (PERIOD=0.2S)  S <sub>1</sub> 0.325 MCE <sub>R</sub> GROUND MOTION (PERIOD=1.0S)  S <sub>MS</sub> 1.068 SITE-MODIFIED SPECTRAL ACCELERATION VALUE			BUILDING		
8. ALL HEIGHTS ARE DIMENSIONED FROM TOP OF EXISTING SLAB UNLESS NOTED OTHERWISE "AFF", ABOVE FINISH FLOOR.	(CALGREEN CODE)  2022 TITLE 24 CCR, PART 12 - 2022 CALIFORNIA REFERENCED STANDARDS  PARTIAL LIST OF APPLICABLE STANDARDS	SM <sub>1</sub> 0.552 SITE-MODIFIED SPECTRAL ACCELERATION VALUE S <sub>DS</sub> 0.712 NUMERIC SEISMIC DESIGN VALUE AT 0.2s SA S <sub>D1</sub> 0.368 NUMERIC SEISMIC DESIGN VALUE AT 1.0s SA RISK CATEGORY: II			DOUGLAS K FLETC		
<ol> <li>9. ALL WORK SHALL BE SCHDULED AND PERFORMED SO AS NOT TO DISTURB OR CAUSE DAMAGE TO ADJACENT PROPERTIES.</li> <li>10. ALL REVISIONS TO THE APPROVED PLANS, MUST BE APPROVED BY THE DIVISION OF STATE ARCHITECT.</li> </ol>	2022 NFPA 72, FIRE ALARM CODE (CA AMENDED)  NOTHING IN THESE PLANS IS TO BE CONSTRUED TO PERMIT CONSTRUCTION IN CONFLICT WITH	SITE CLASS: D - DEFAULT WIND SPEED - 130MPH			ELEMENTARY SCH		
11. THE GENERAL CONTRACTOR SHALL BE RESPONSIBLE FOR CHECKING CONTRACT DOCUMENTS, FIELD CONDITIONS AND DIMENSIONSFOR ACCURACY AND CONFIRMING THAT WORK IS BUILDABLE AS SHOWN BEFORE PROCEEDING WITH CONSTRUCTION. IF THERE ARE ANY QUESTIONS REGARDING THESE OR OTHER COORDINATION QUESTIONS,	THE REQUIREMENTS OF ANY CODE, LAW, ORDINANCE, OR REGULATION. THE FOLLOWING AGENCIES SHALL HAVE JURISDICTION OVER THE PROGRESS OF THE WORK:  CAL/OSHA  DIVISION OF THE STATE ARCHITECT	SCOPE OF WORK  BUILDINGS			FOR: BAKERSIELD CI		
THE GENERAL CONTRACTOR SHALL BE RESPONSIBLE FOR OBTAINING A CLARIFICATION FROM THE ARCHITECT BEFORE PROCCEEDING WITH WORK OR RELATED WORK IN QUESTION.  12. THE GENERAL CONTRACTOR AND SUBCONTRACTORS SHALL COORDINATE THE LAYOUT	REGULATORY SERVICES: STRUCTURAL SAFETY SECTION FIRE & LIFE SAFETY SECTION ACCESS COMPLIANCE SECTION  COUNTY OF KERN: FIRE DEPARTMENT PUBLIC WORKS DEPARTMENT	DESIGN, MANUFACTURING, AND INSTALLATION OF (1) PERMANENT MODULAR CLASSROOM BUILDING  SITE WORK NOT PART OF THIS SCOPE OF WORK.			SCHOOL DISTR 1300 BAKER ST, BAKERSFIELD, C		
AND EXACT LOCATION OF ALL PARTITIONS, DOORS, PLUMBING, MECHANICAL, ELECTRICAL AND FIRE PROTECTION EQUIPMENT IN THE FIELD BEFORE PROCEEDING WITH CONSTRUCTION.		FIRE PROTECTION			MARK DATE DESCR		
13. THE GENERAL CONTRACTOR SHALL BE RESPONSIBLE FOR SECURITY OF THE PROJECT AND SHALL BE RESPONSIBLE FOR DISIPLINE OF ALL WORKERS ON THE PROJECT.		NEW BUILDINGS SHALL BE PROVIDED WITH EMERGENCY RESPONDER RADIO COVERAGE IN					
<ul><li>14. ALL DECORATIVE MATERIALS AND TRIM SHALL COMPLY WITH CALIFORNIA BUILDING CODE, SECTION 806.1</li><li>15. JOINTS AND OTHER OPENINGS IN THE BUILDING ENVELOPE THAT ARE POTENTIAL</li></ul>	ACCESSIBILITY STANDARDS	ACCORDANCE WITH CALIFORNIA FIRE CODE SECTION 510. THE PROJECT ARCHITECT (AOR) SHALL CONTACT THE LOCAL FIRE DEPARTMENT AND/OR EMERGENCY COMMUNICATIONS AUTHORITY TO OBTAIN DESIGN, EQUIPMENT SPECIFICATIONS, TESTING AND ACCEPTANCE CRITERIA. PLANS AND REQUESTED DOCUMENTATION SHALL BE SUBMITTED TO THE LOCAL AUTHORITY HAVING JURISDICTION FOR REVIEW AND APPROVAL. UPON COMPLETION, COPIES					
SOURCES OF AIR LEAKAGE SHALL BE CAULKED, GASKETED, WEATHER STRIPPED OR OTHERWISE SEALED TO LIMIT INFILTRATION AND EXFILTRATION PER CEC 110.7  16. ALL WORK SHALL CONFORM TO 2022 EDITION TITLE 24, CALIFORNIA CODE OF REGULATIONS (CCR)	DESIGN PROFESSIONAL IN GENERAL RESPONSIBLE CHARGE STATEMENT: THE POT IDENTIFIED IN THESE CONSTRUCTION DOCUMENTS IS COMPLIANT WITH THE CURRENT APPLICABLE CALIFORNIA BUILDING CODE ACCESSIBILITY PROVISIONS FOR PATH OF TRAVEL	OF THE APPROVED PLANS, EQUIPMENT DATA SHEETS, TESTING AND ACCEPTANCE DOCUMENTATION SHALL BE PROVIDED TO THE SCHOOL DISTRICT.  2. PROVIDE ONE 4A 10 B.C. RATED EXTINGUISHER FOR EACH 6,000 SQUARE FEET OR PORTION					
17. CHANGE TO THE APPROVED DRAWINGS AND SPECTIFICATIONS SHALL BE MADE BY ADDENDA OR CONSTRUCTION CHANGE DOCUMENT (CCD) APPROVED BY DSA, AS REQUIRED BY SECTION 4-338, PART 1, TITLE 24, CCR.	REQUIREMENTS FOR ALTERATIONS ADDITIONS AND STRUCTURAL REPAIRS. AS PART OF THE DESIGN OF THIS PROJECT, THE POT WAS EXAMINED AND ANY ELEMENTS, COMPONENTS OR PORTIONS OF THE POT THAT WERE DETERMINED TO BE NONCOMPLIANT 1) HAVE BEEN IDENTIFIED AND 2) THE CORRECTIVE WORK NECESSARY TO BRING THEM INTO COMPLIANCE HAS BEEN INCLUDED WITHIN THE SCOPE OF THIS PROJECT'S WORK THROUGH DETAILS, DRAWINGS AND SPECIFICATIONS	THEREOF ON EACH FLOOR - TRAVEL DISTANCE SHALL NOT EXCEED 75 FEET.			JOB NUMBER: 2307		
18. A "DSA CERTIFIED" PROJECT INSPECTOR (MIN CLASS 3) EMPLOYED BY THE DISTRICT (OWNER) AND APPROVED BY DSA SHALL PROVIDE CONTINUOUS INSPECTION OF THE WORK. THE DUTIES OF THE INSPECTOR ARE DEIFNED IN SECTION 4-342, PART 1, TITLE 24, CCR.	INCORPORTRATED INTO THESE CONSTRUCION DOCUMENTS. ANY NON COMPLIANT ELEMENTS, COMPONENTS OR PORTIONS OF THE POT THAT WILL NOT BE CORRECTED BY THIS PROJECT BASED ON VALUATION THRESHOLD LIMITATIONS OR A FIND OF UNREASONABLE HARDSHIP ARE SO INDICATED IN THESE CONSTRUCTION DOCUMENTS.		VICINITY MAP		A#: 03-###### PTN: ###-### CAD DRAWING FILE: 2307 (3) TK FLETCHER PIT SET MODI A26.pln		
<ul> <li>19. A DSA ACCEPTED TESTING LABORATORY DIRECTLY EMPLOYED BY THE DISTRICT (OWNER) SHALL CONDUCT ALL THE REQUIRED TESTS AND INSPECTIONS FOR THE PROJECT.</li> <li>20. THE INTENT OF THESE DRAWINGS AND SPECIFICATION IS THAT THE WORK OF THE</li> </ul>	DURING CONSTRUCTION, IF POT ITEMS WITHIN THE SCOPE OF THE PROJECT REPRESENTED AS CODE COMPLIANT ARE FOUND TO BE NONCONFORMING BEYOND REASONABLE CONSTRUCION TOLERANCES, THEY SHALL BE BROUGHT INTO COMPLIANCE WITH THE CBC AS A PART OF THIS PROJECT BY MEANS OF A CONSTRUCTION CHANGE DOCUMENT				DRAWN BY: ASI CHECKED BY: MM		
ALTERATION, REHABILITATION OR RECONSTRUCTION IS TO BE IN ACCORDANCE WITH TITLE 24, CCR. SHOULD ANY EXISTING CONDITIONS SUCH AS DETERIORATION OR NON-COMPLYING CONSTRUCTION BE DISCOVERED WHICH IS NOT COVERED BY THE CONTRACT DOUCMENTS WHEREIN THE FINISHED WORK WILL NOT COMPLY WITH TITILE 24, CCR, A CONSTRUCTION CHANGE DOCUMENT (CCD), OR A SEPARATE SET OF PLANS AND SPECIFICATIONS, DETAILING AND SPECIFYING THE REQUIRED WORK SHALL BE SUBMITTED TO AND APPROVED BY DSA BEFOR PROCEEDING WITH THE WORK. (SECTION 4-317 (C), PART 1, TITLE 24, CCR)	1. HAND ACTIVATED DOOR OPENING HARDWARE SHALL BE CENTERED BETWEEN 34 INCHES AND 44 INCHES ABOVE FLOOR. LATCHING AND LOCKING DOORS THAT ARE HAND ACTIVATED AND WHICH ARE IN A PATH OF TRAVEL SHALL BE OPERABLE WITH A SINGLE EFFORT BY LEVER TYPE HARDWARE, BY PANIC BARS, PUSH-PULL ACTIVATION BARS, OR OTHER HARDWARE DESIGNED TO PROVIDE PASSAGE WITHOUT REQUIRING THE ABILITY TO GRASP AND TURN OPENING HARDWARE. LOCKED EXIT DOORS SHALL OPERATE AS ABOVE IN EGRESS DIRECTION.		MORWING DR		CHECK AND VERIFY ALL DIMENSIONS BEFORE P WITH THE WORK. REPORT DISCREPANCIES TO TH THE DRAWINGS, IDEAS, AND DESIGNS REPRESEN SHEET ARE THE PROPERTY OF THE ARCH COPYRIGHT 2023 ORDIZ-MELBY ARCHITECTS A PROFESSIONAL CORPORATION		
21. GRADING PLANS, DRAINAGE IMPROVEMENTS, ROAD AND ACCESS REQUIREMENTS AND ENVIRONMENTAL HEALTH CONSIDERATIONS SHALL COMPLY WITH ALL LOCAL ORDINANCES	2. MAXIMUM EFFORT TO OPERATE SHALL NOT EXCEED 5 POUNDS FOR EXTERIOR DOORS AND 5 POUNDS FOR INTERIOR DOORS. SUCH PULL OR PUSH EFFORT BEING APPLIED AT RIGHT ANGLES TO HINGED DOORS AND AT THE CENTER PLANE OF SLIDING OR FOLDING DOORS. COMPENSATING DEVICES OR AUTOMATIC DOOR OPERATORS MAY BE UTILIZED TO MEET THE ABOVE STANDARDS WHEN FIRE DOORS ARE REQUIRED. THE MAXIMUM EFFORT TO OPERATE		CALIFORNIA STATE ROUTE 178  HIGHLAND KNOLLS DR. 3		SHEET TITLE  GENERAL		
22. ALL MATERIALS AND WORK SHOWN SHALL BE CONSIDERED A PART OF THE SCOPE OF WORK FOR THIS PROJECT UNLESS INDICATED AS EXISTING (E)	THE DOOR MAY BE INCREASED NOT TO EXCEED 15 POUNDS.  3. CONSTRUCTION: THE BOTTOM 10" OF ALL DOORS EXCEPT AUTOMATIC AND SLIDING SHALL		WATEL CANO PO		INFORMATION [		
23. WHENEVER DSA FINDS ANY CONSTRUCTION WORK IS BEING PERFORMED IN A MANNER CONTRARY TO THE PROVISIONS OF CALIFORNIA BUILDING CODE AND THAT WOULD COMPROMISE THE STRUCTURAL INTEGRITY OF THE BUILDING, THE DEPARTMENT OF GENERAL SERVICES, STATE OF CALIFORNIA, IS AUTHORIZED TO ISSUE A STOP WORK ORDER PER SECTION 4-334.1 CALIFORNIA ADMINISTRATIVE CODE (PART 1, TITLE 24, CCR).	HAVE A SMOOTH UNINTERRUPTED SURFACE TO ALLOW THE DOOR TO BE OPENED BY A WHEELCHAIR FOOTREST WITHOUT CREATING A TRAP OR HAZARDOUS CONDITION. WHERE NARROW FRAMES ARE USED, A 10" HIGH SMOOTH PANEL SHALL BE INSTALLED ON THE PUSH SIDE OF THE DOOR, WHICH WILL ALLOW THE DOOR TO BE OPENED BY A WHEELCHAIR FOOTREST WITHOUT CREATING A TRAP OR HAZARDOUS CONDITION.		To Constitute on the constitution of the const		PORTABLES		
24 TITLE 24, PARTS 1-5 AND 9 MUST BE KEPT ON SITE DURING CONSTRUCTION.	4. FOR HINGED DOORS, THE OPENING WIDTH SHALL BE MEASURED WITH THE DOOR POSITIONED AT AN ANGLE OF 90 DEGREES FROM ITS CLOSED POSITION. AT LEAST ONE OF A PAIR OF DOORS SHALL MEET THIS OPENING WIDTH REQUIREMENT.						
25. ALL STRUCTURAL, ARCHITECTURAL, MECHANICAL, ELECTRICAL, AND PLUMBING MATERIALS INSTALLATION TO COMPLY WITH APPLICABLE CODES, STANDARDS, AND MANUFACTURER'S RECOMMENDATIONS.	<ol> <li>IN ADDITION TO ALL LOCAL CODES, ACCESSIBILITY REQUIREMENTS SHALL COMPLY WITH THE CALIFORNIA BUILDING CODE, TITLE 24, AS WELL AS FEDERAL A.D.A., (AMERICANS WITH DISABILITIES ACT).</li> </ol>		NILES ST.		SHEET IDENTIFICATION N		
26. THE PROJECT INSPECTION (PI) SHALL WITNESS AND VERIFY GROUNDING.			MORVING DR		G-001		
			DOGLAS K FLETCHER ELEMENTARY SCHOOL  9801 Highland Knolls Dr. Bakersfield, CA 93306	:			

9801 Highland Knolls Dr, Bakersfield, CA 93306



ARCHITECT C-36742

**NENT** TK OM

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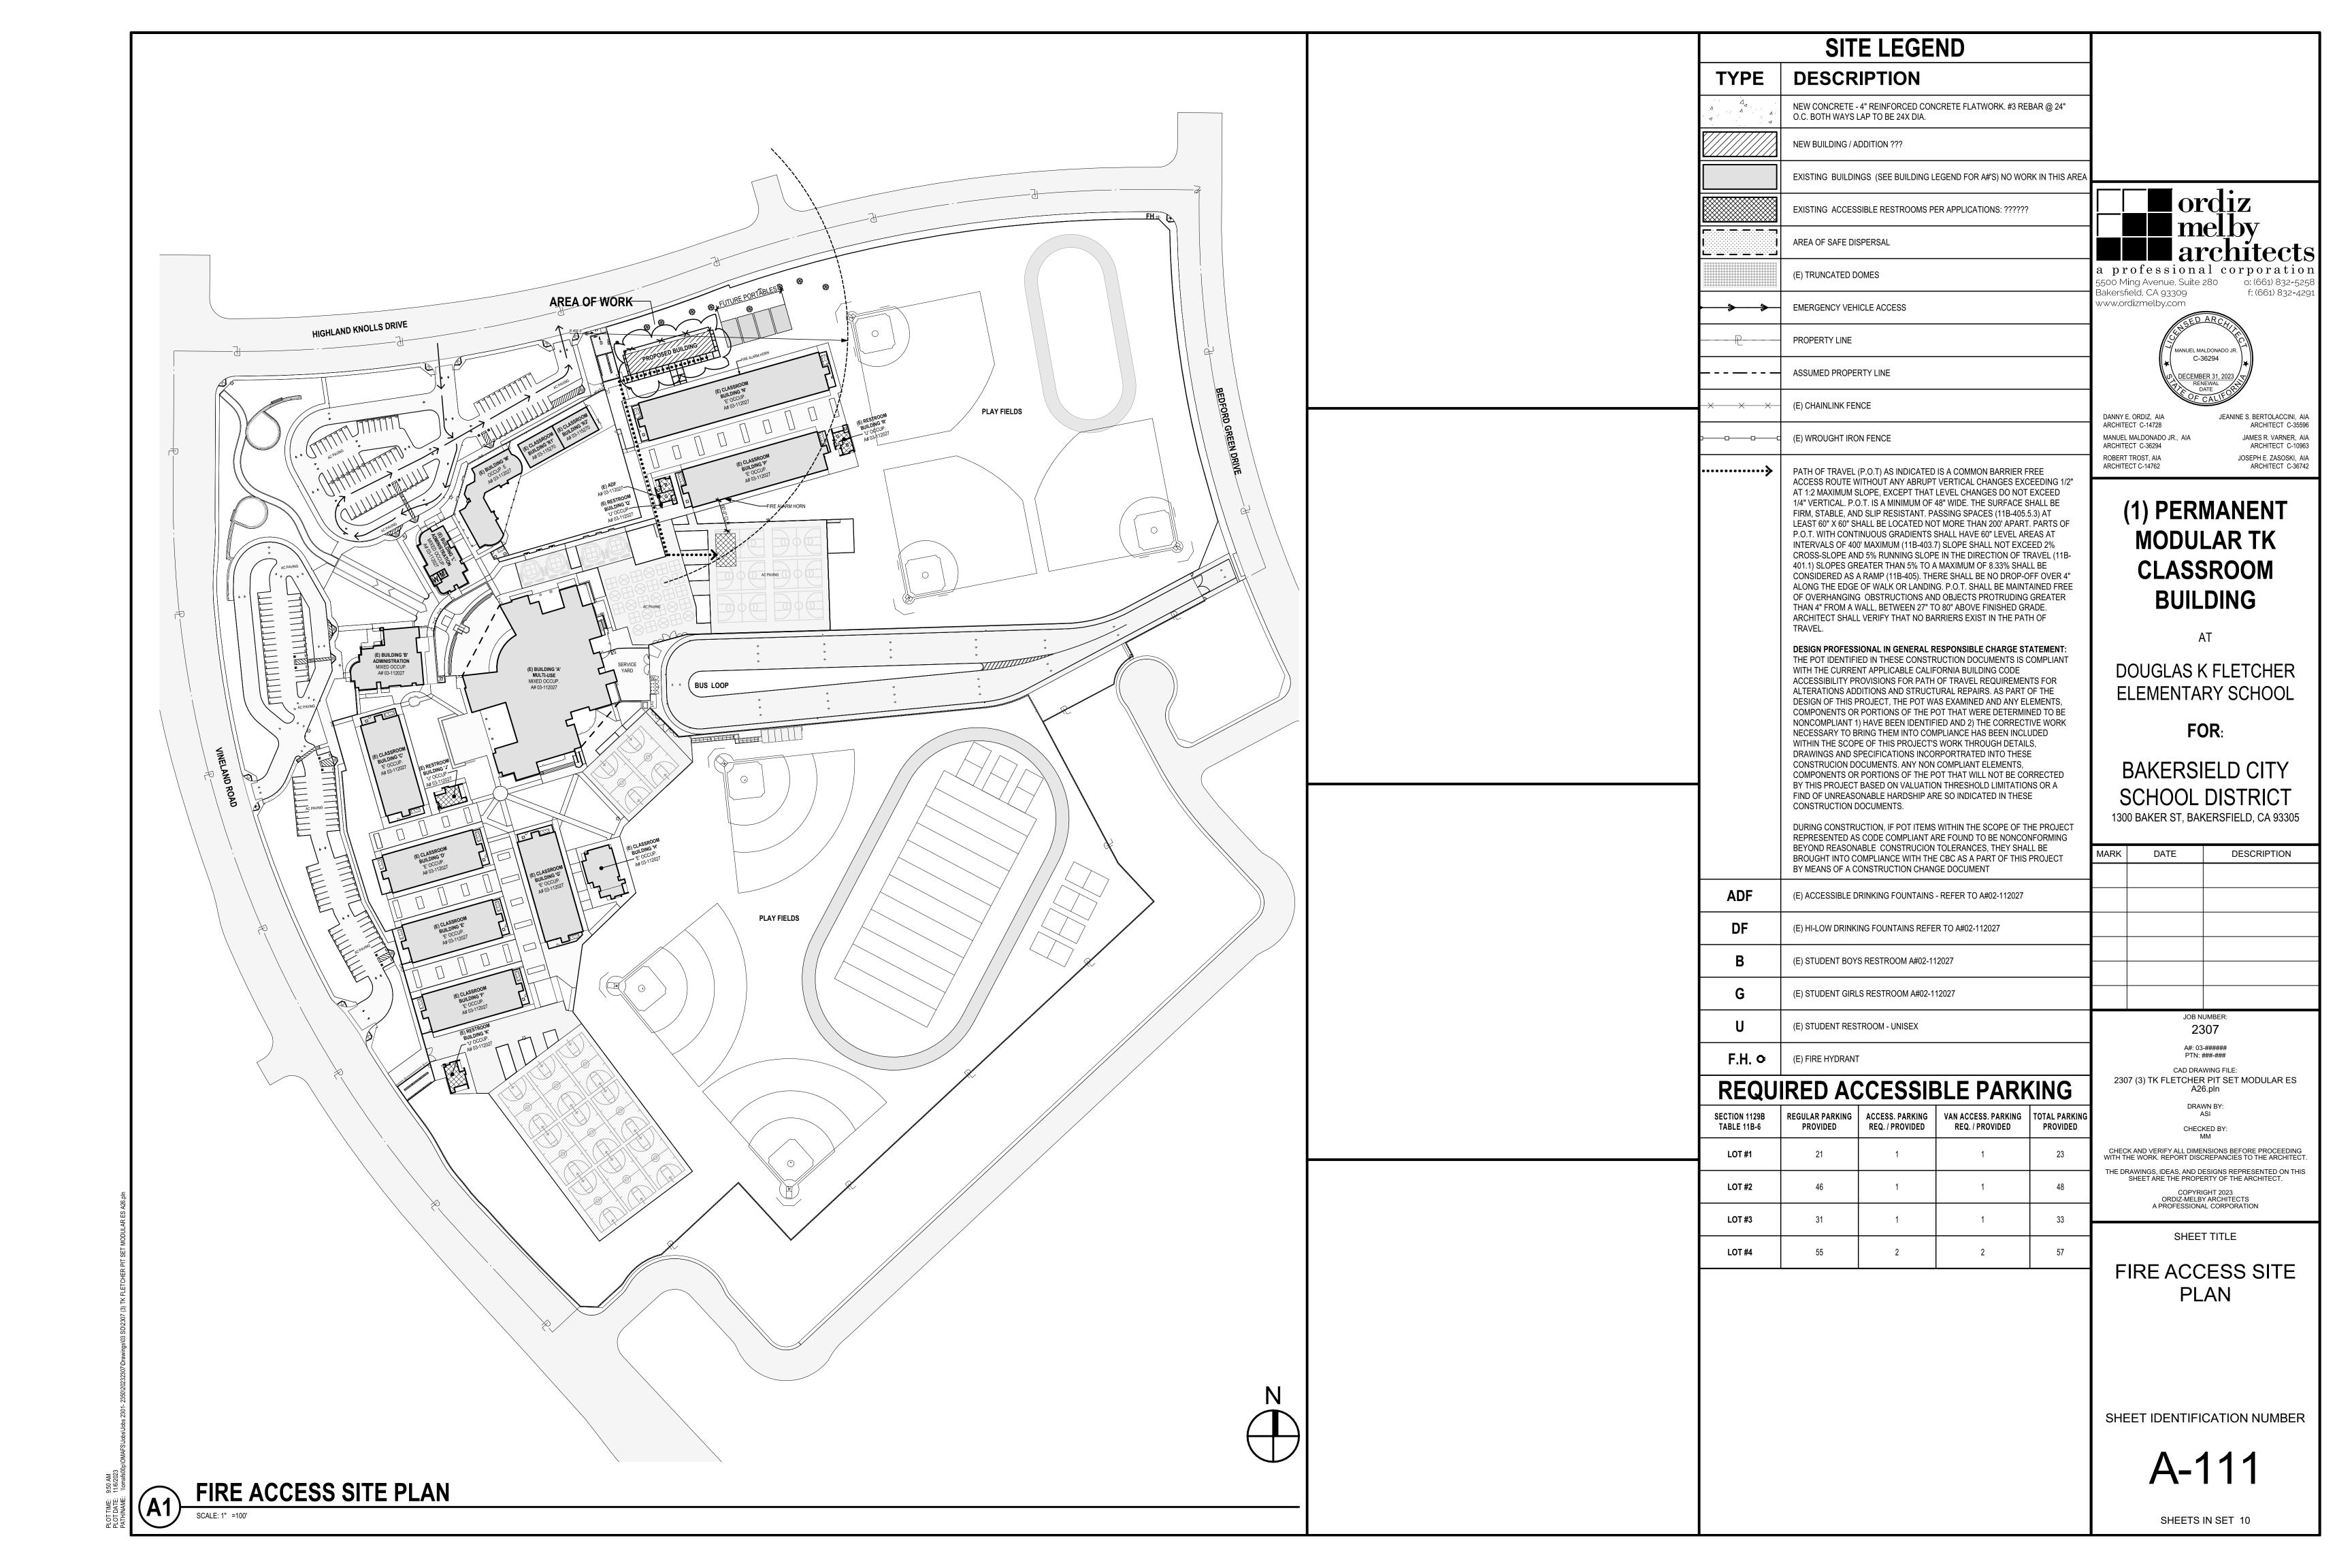
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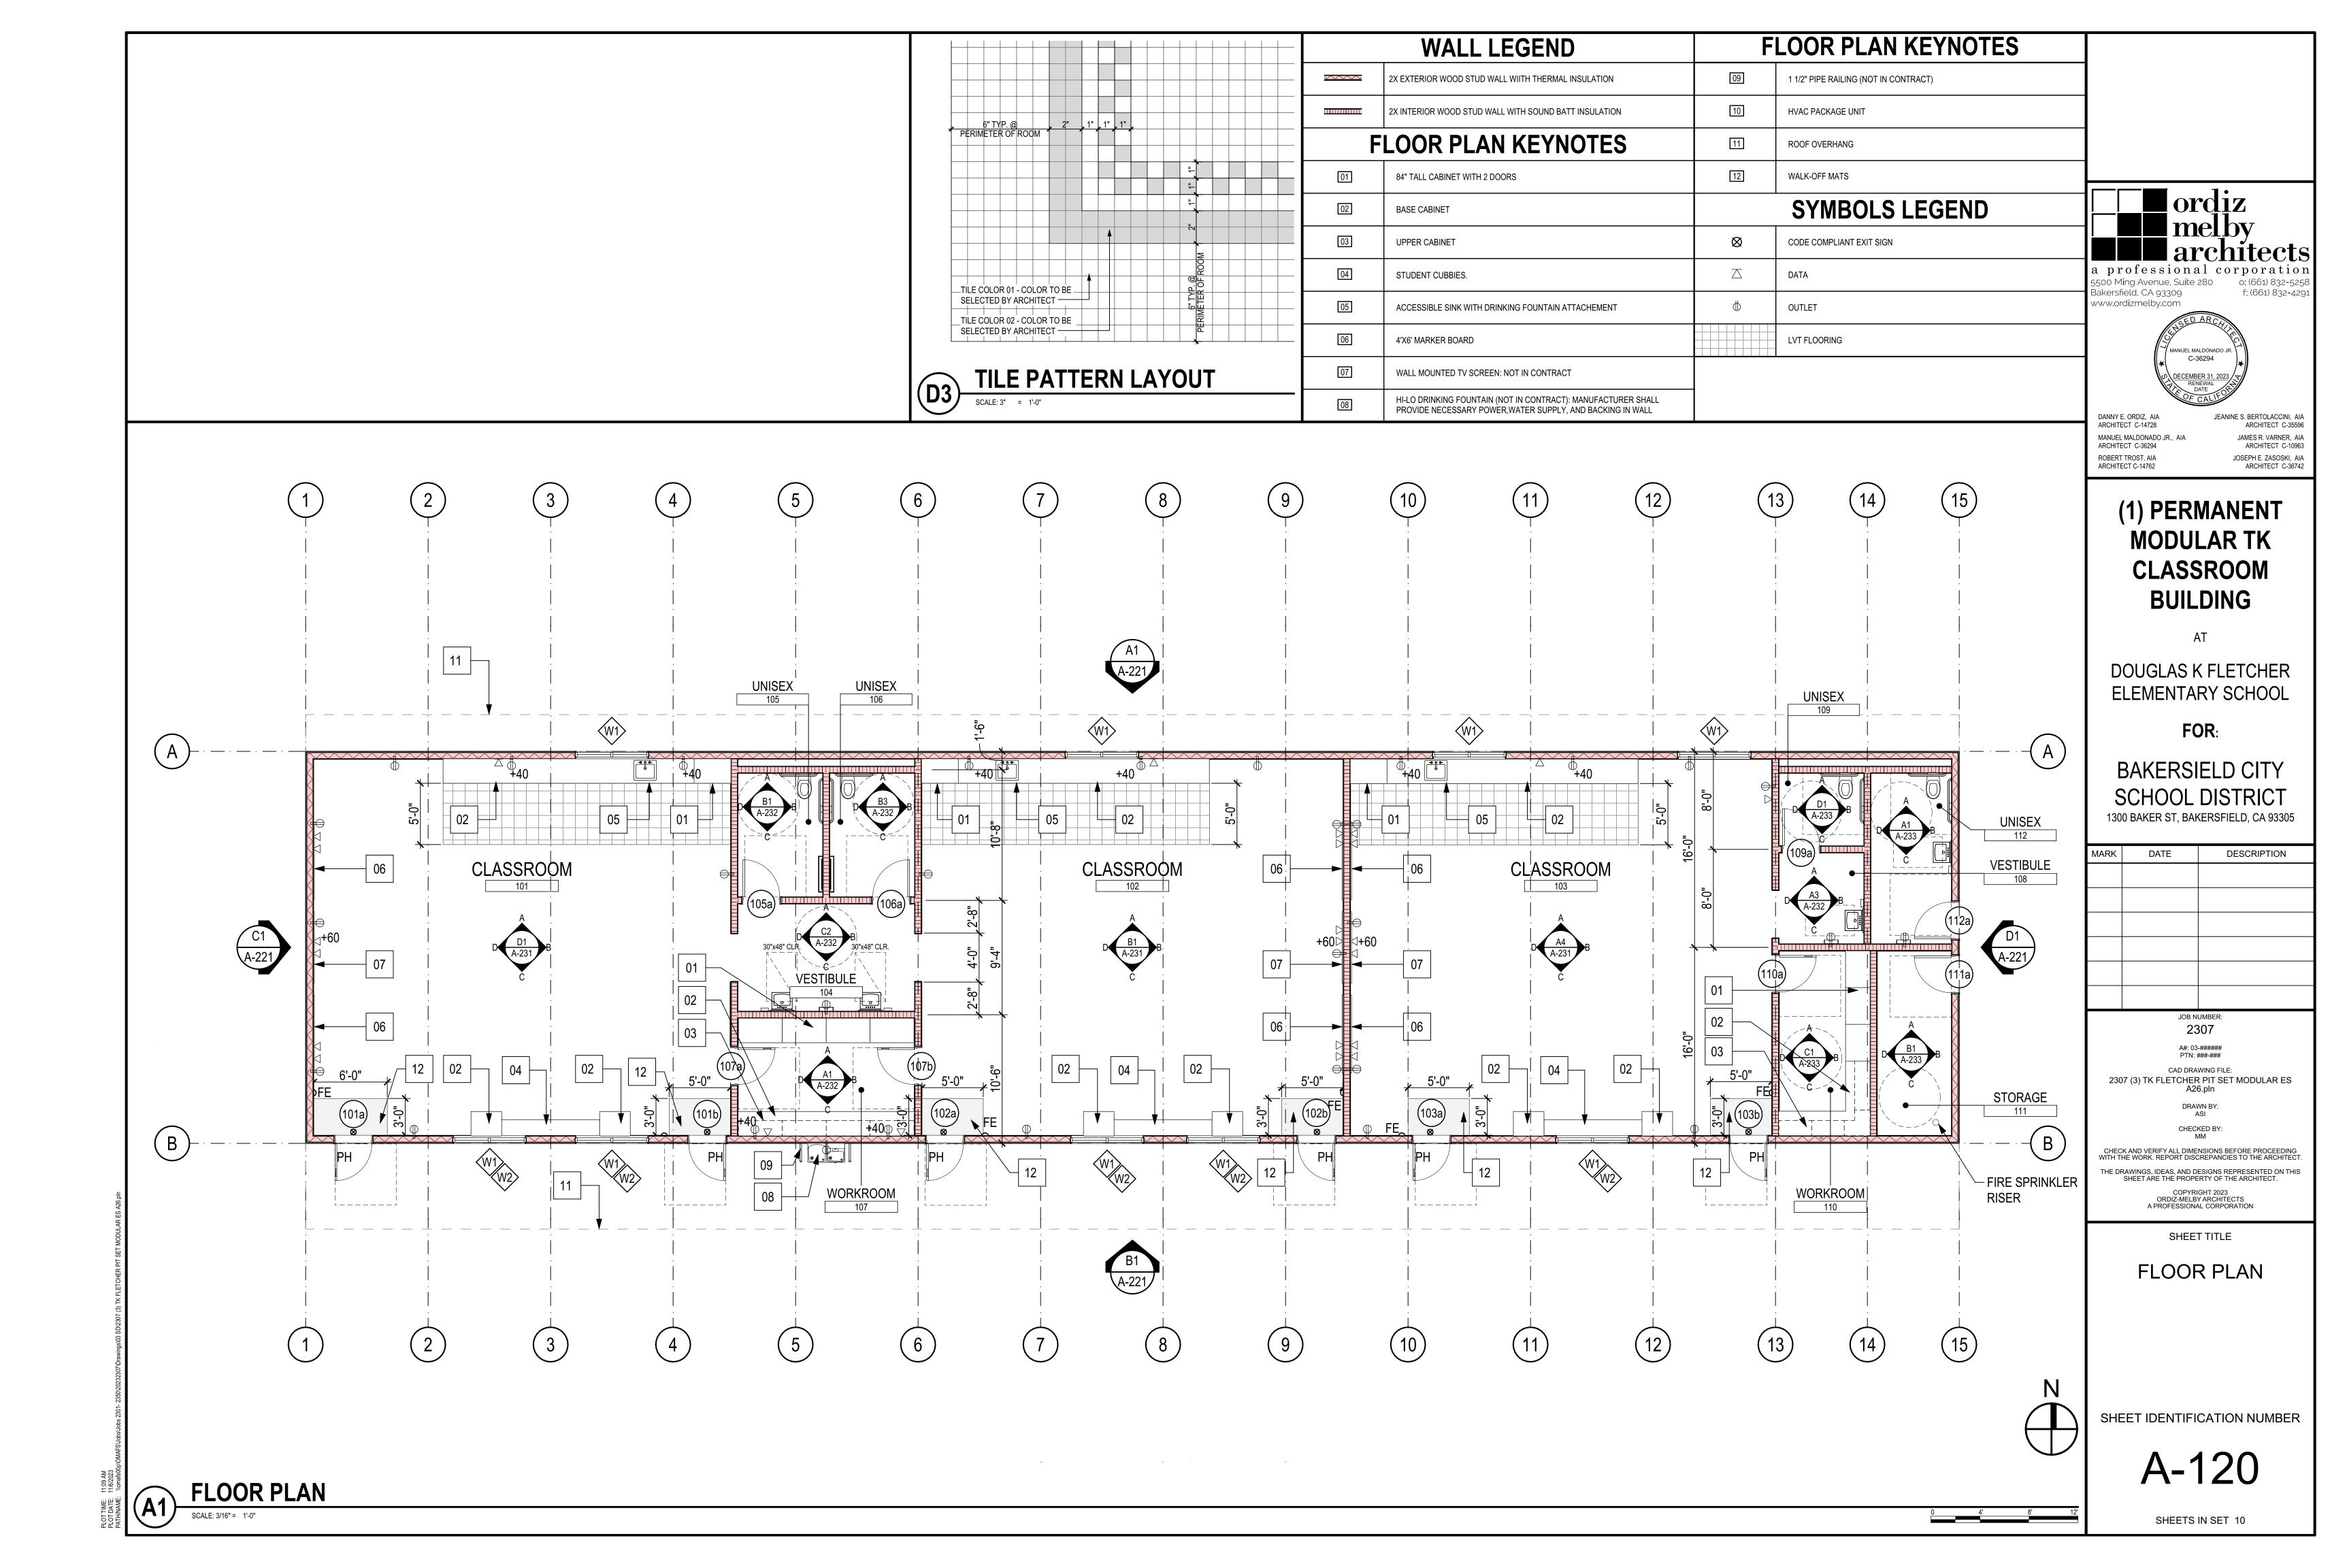
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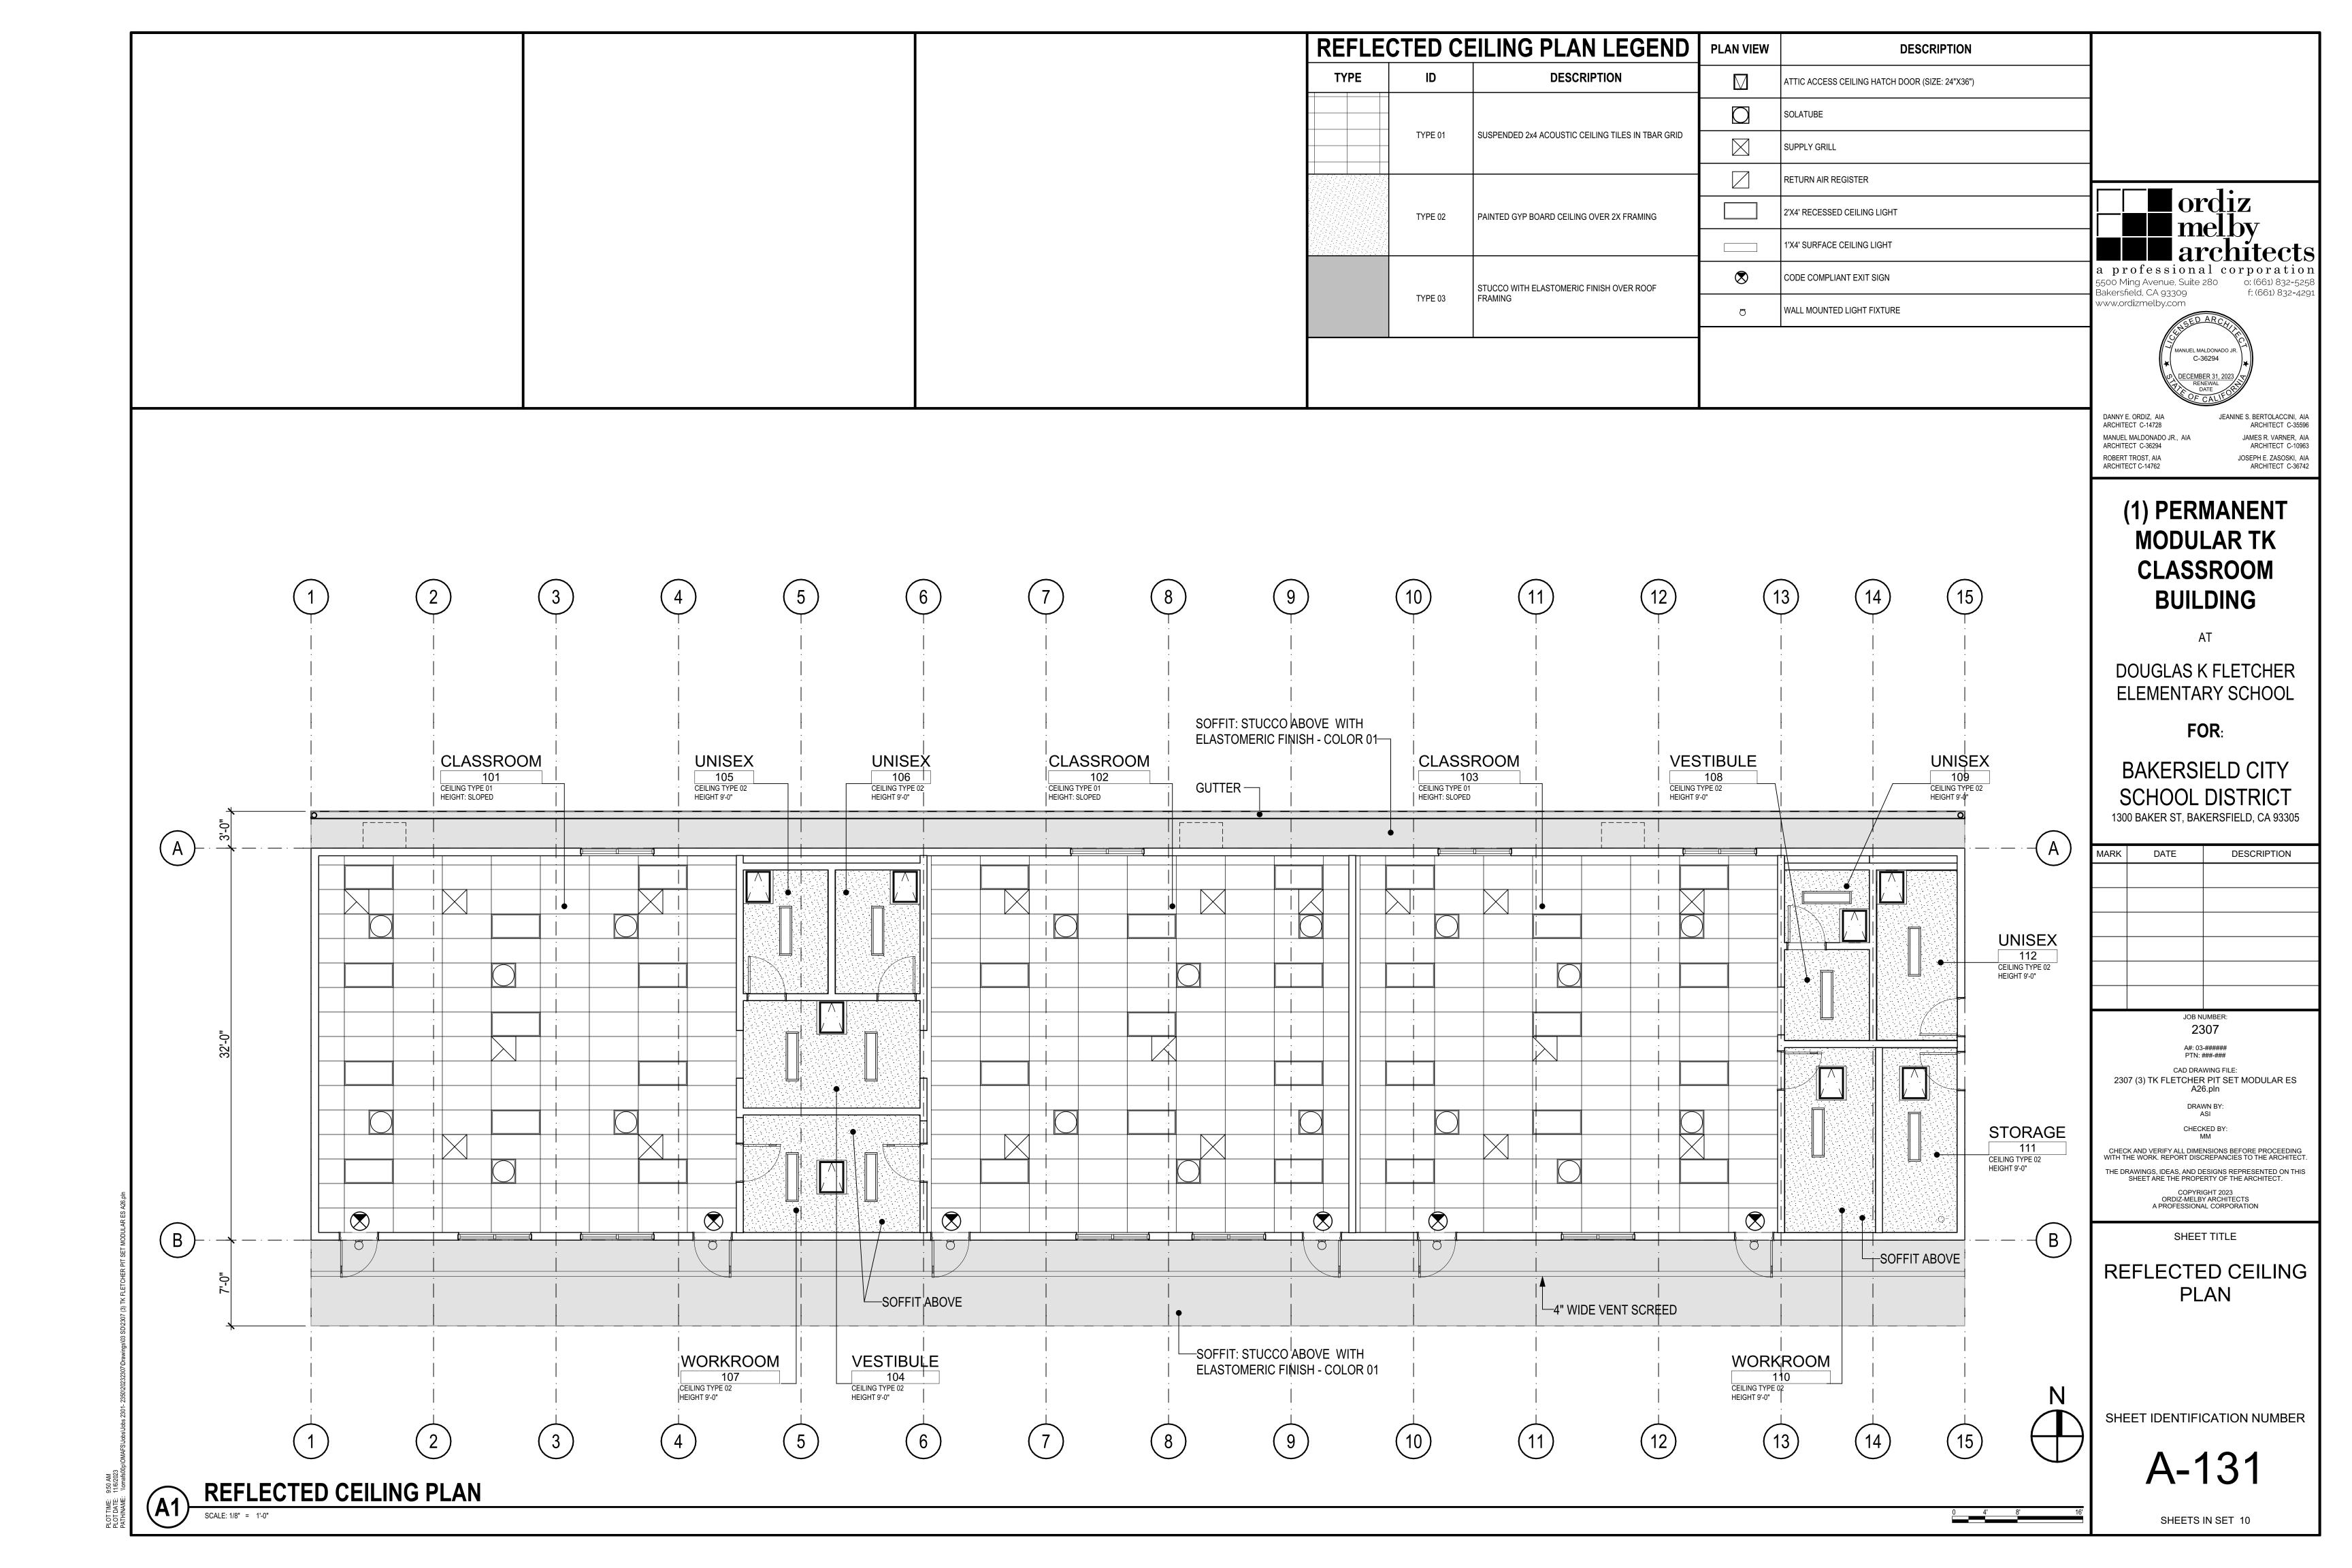
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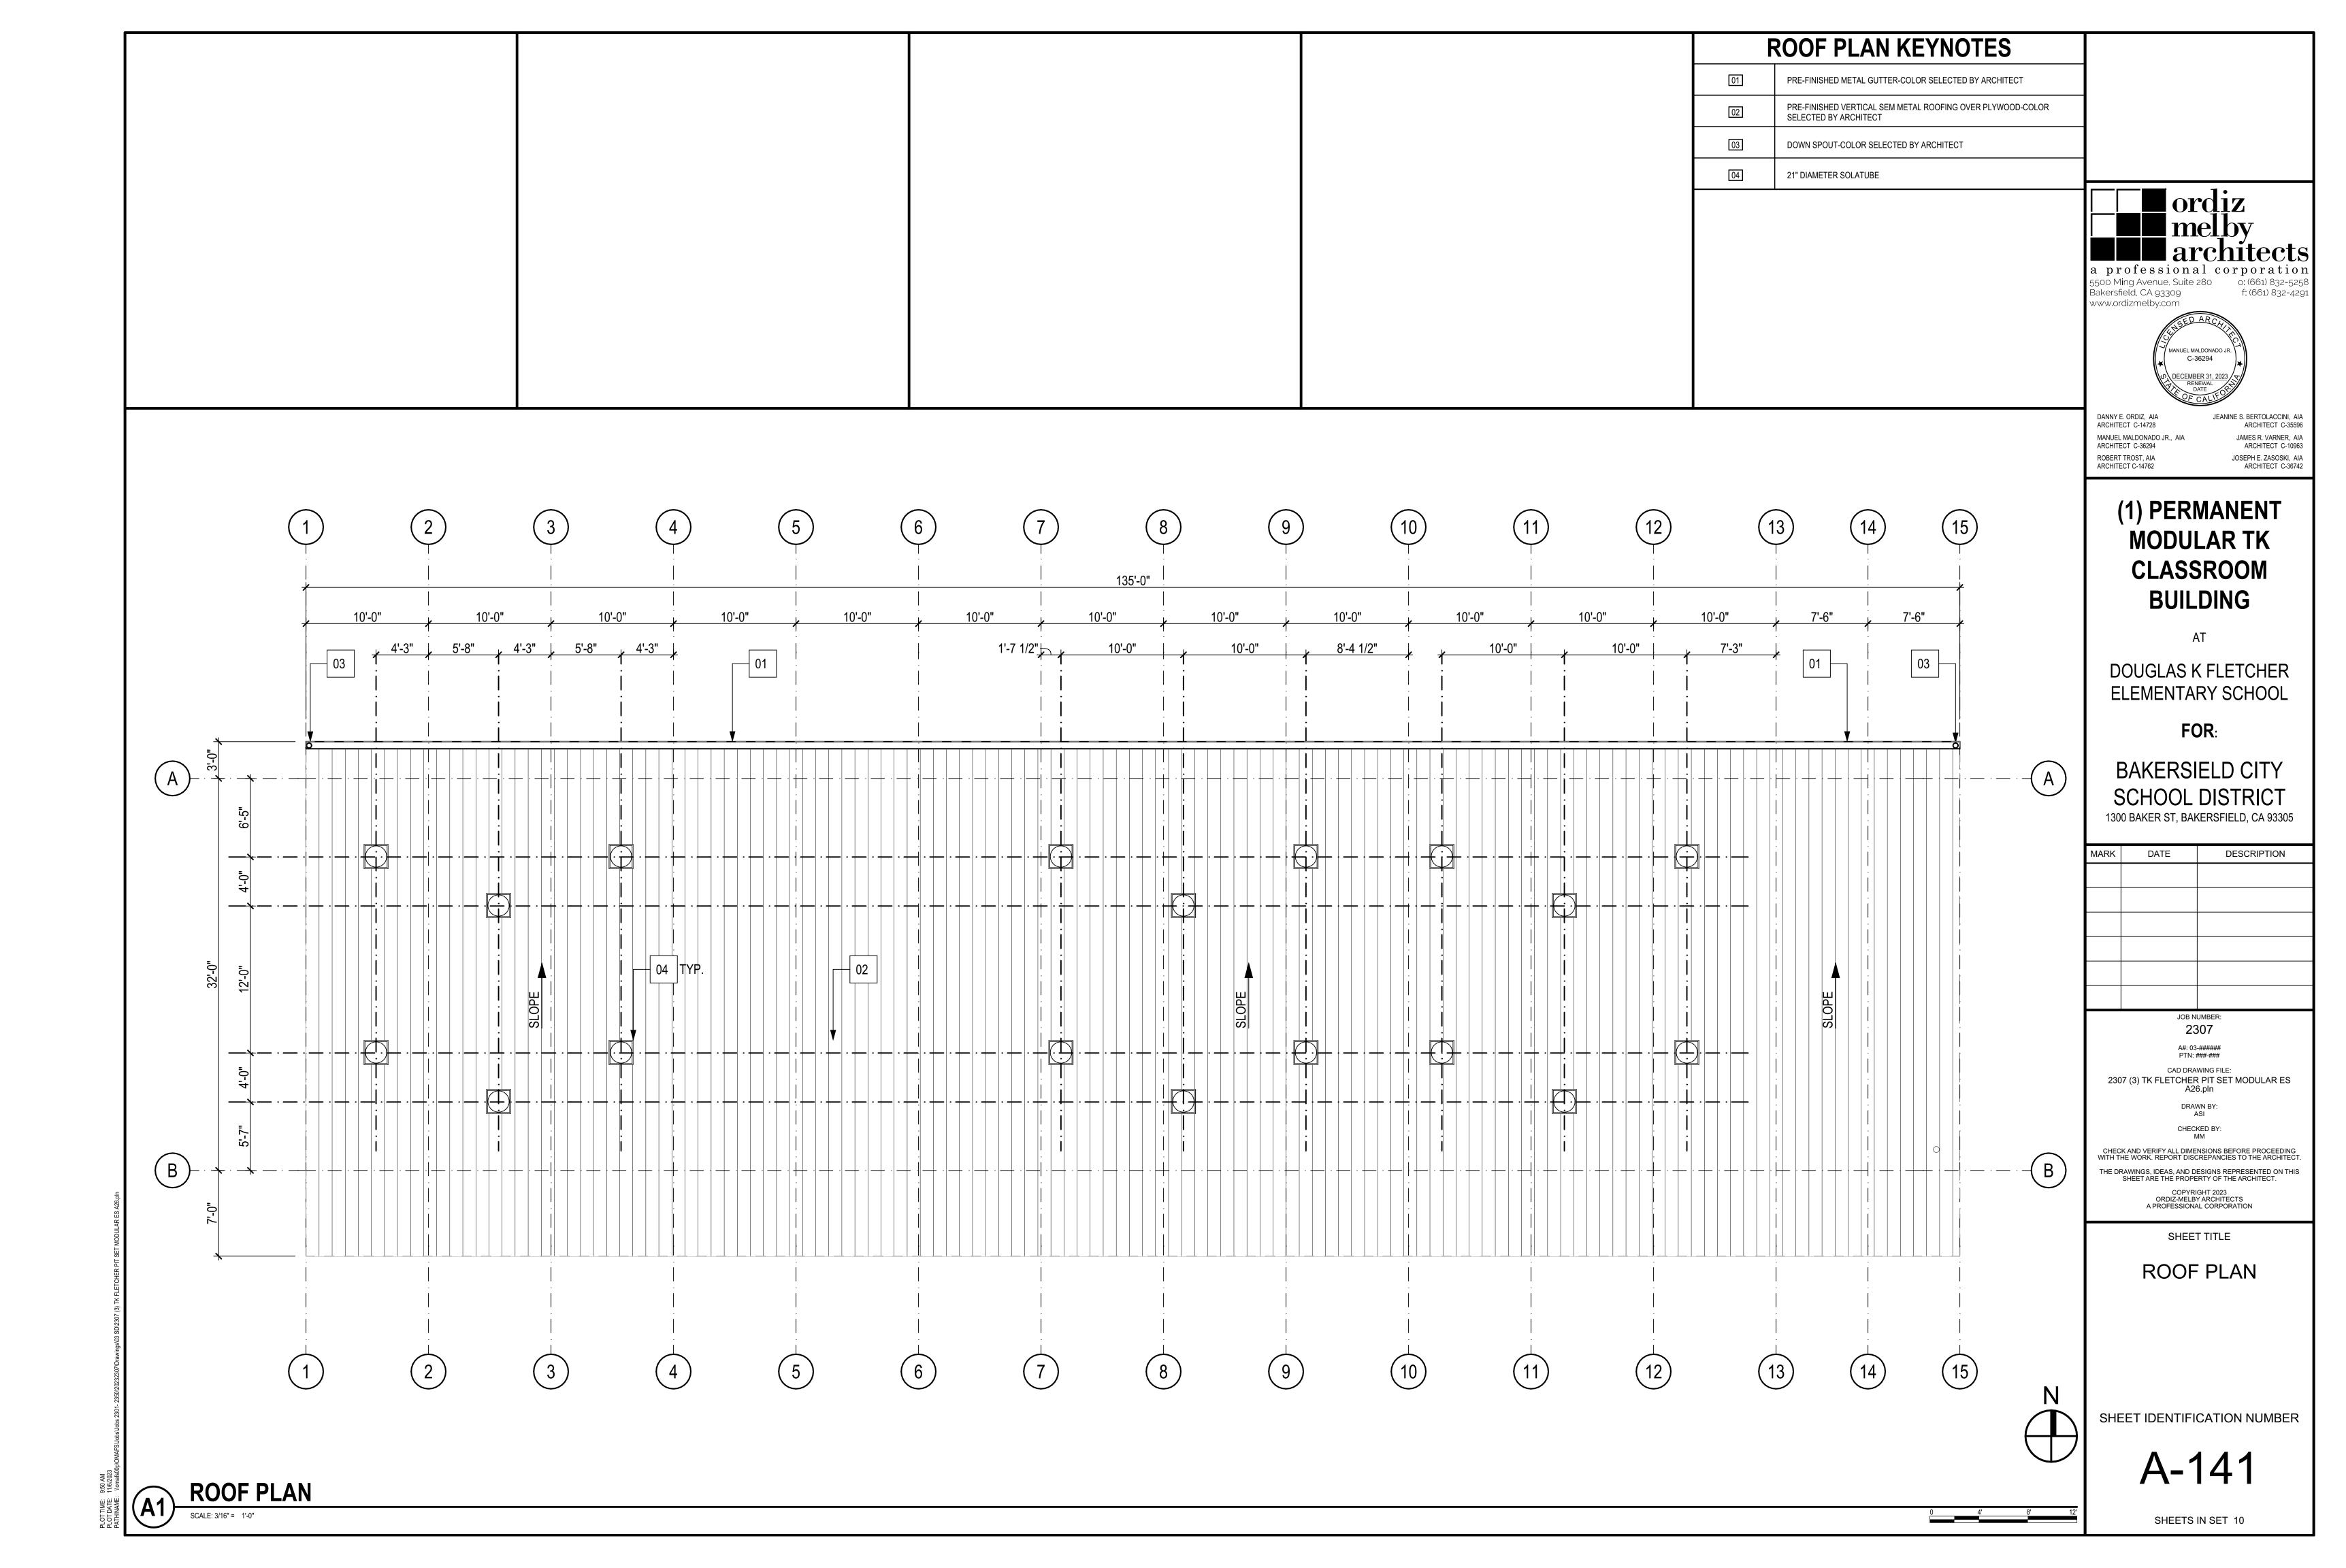
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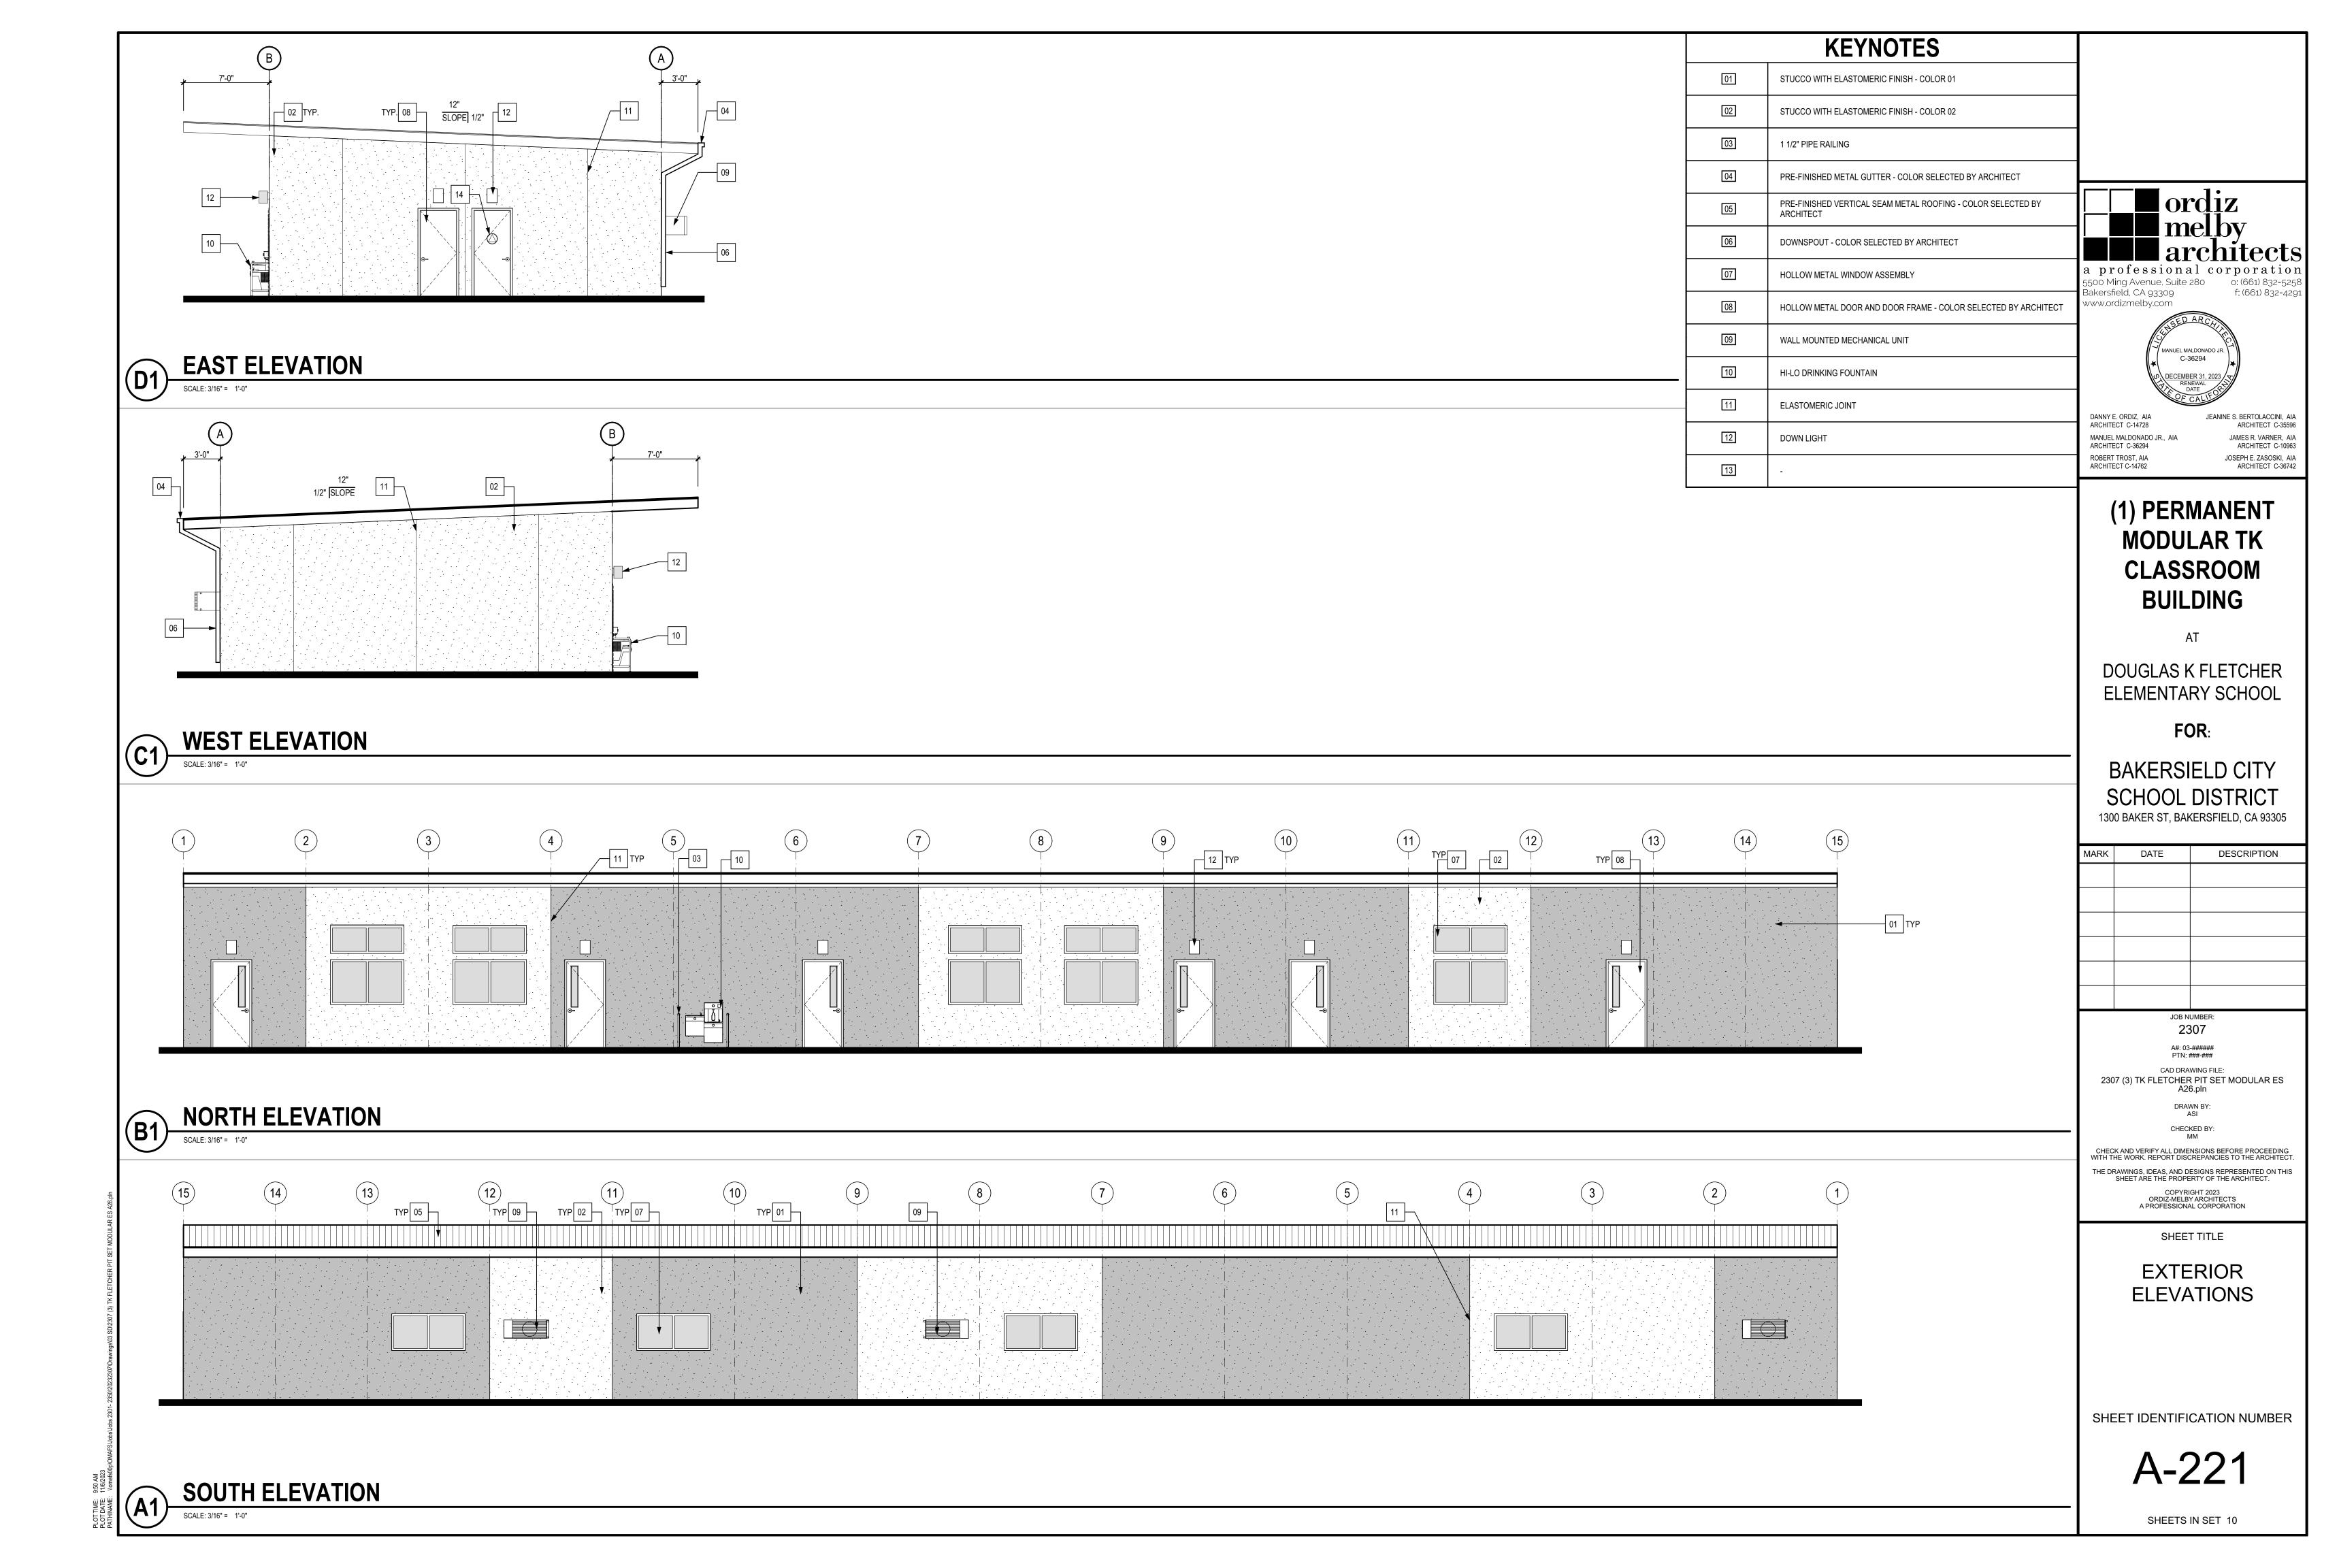
SHEETS IN SET 10














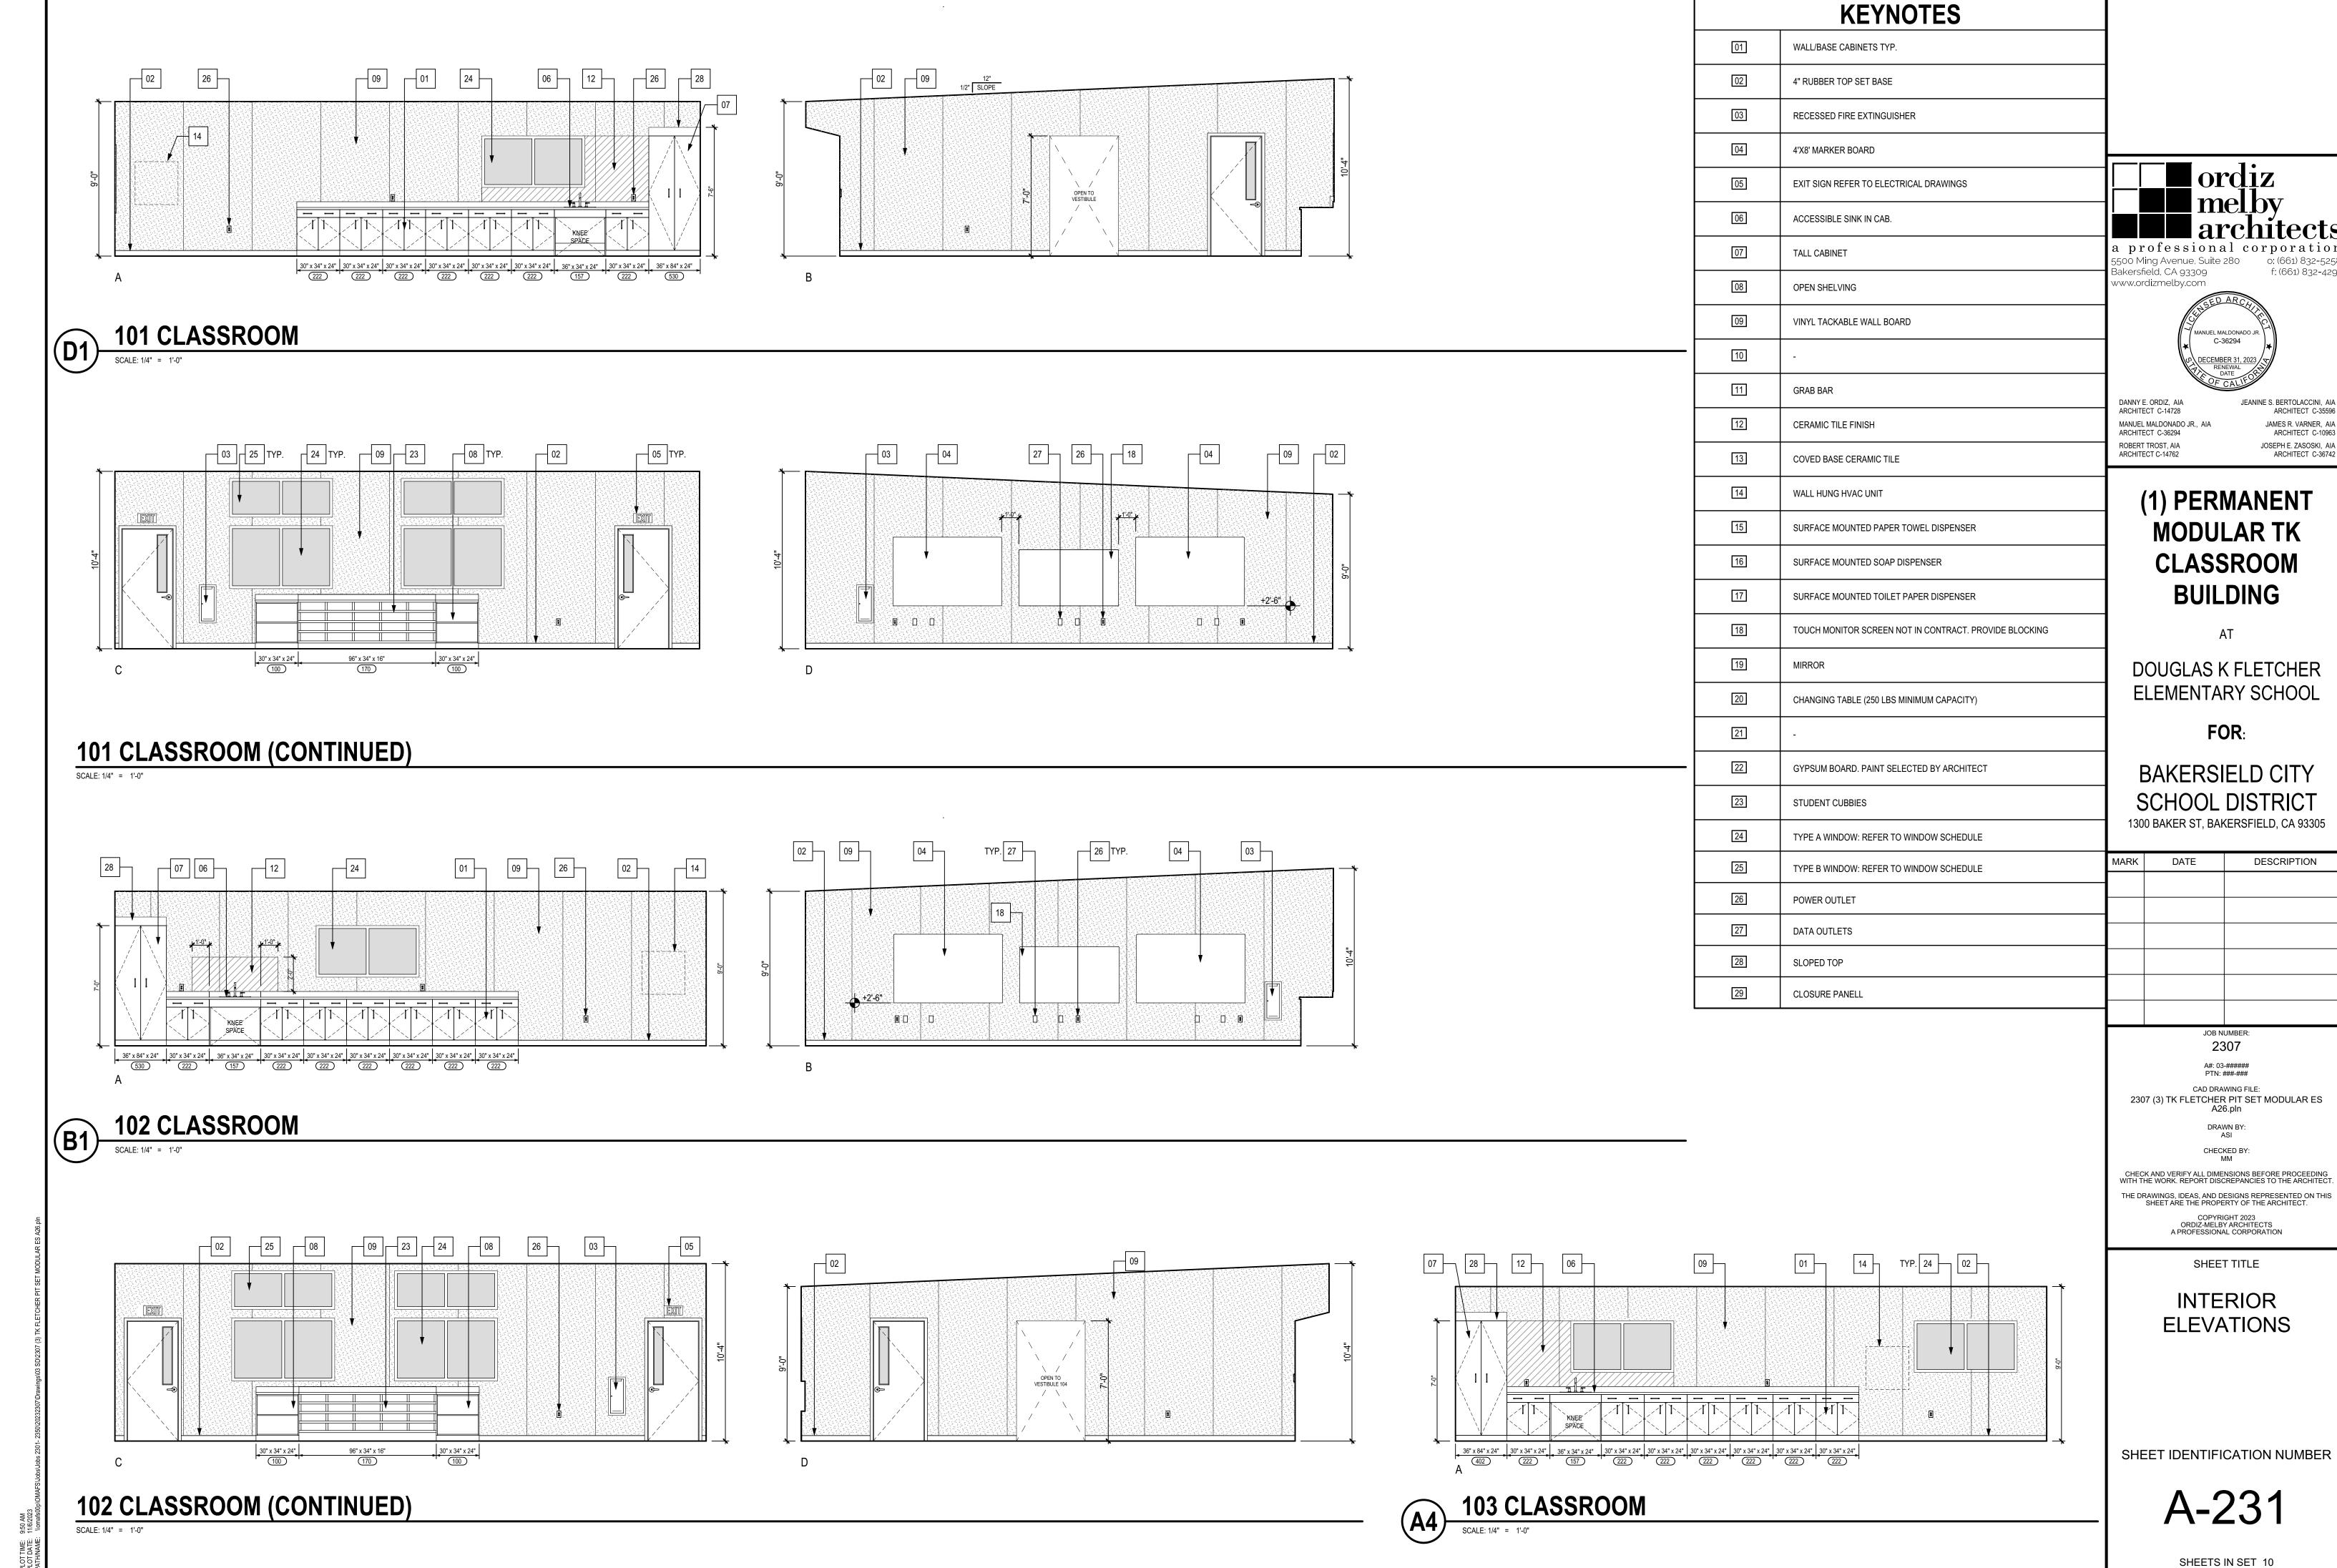


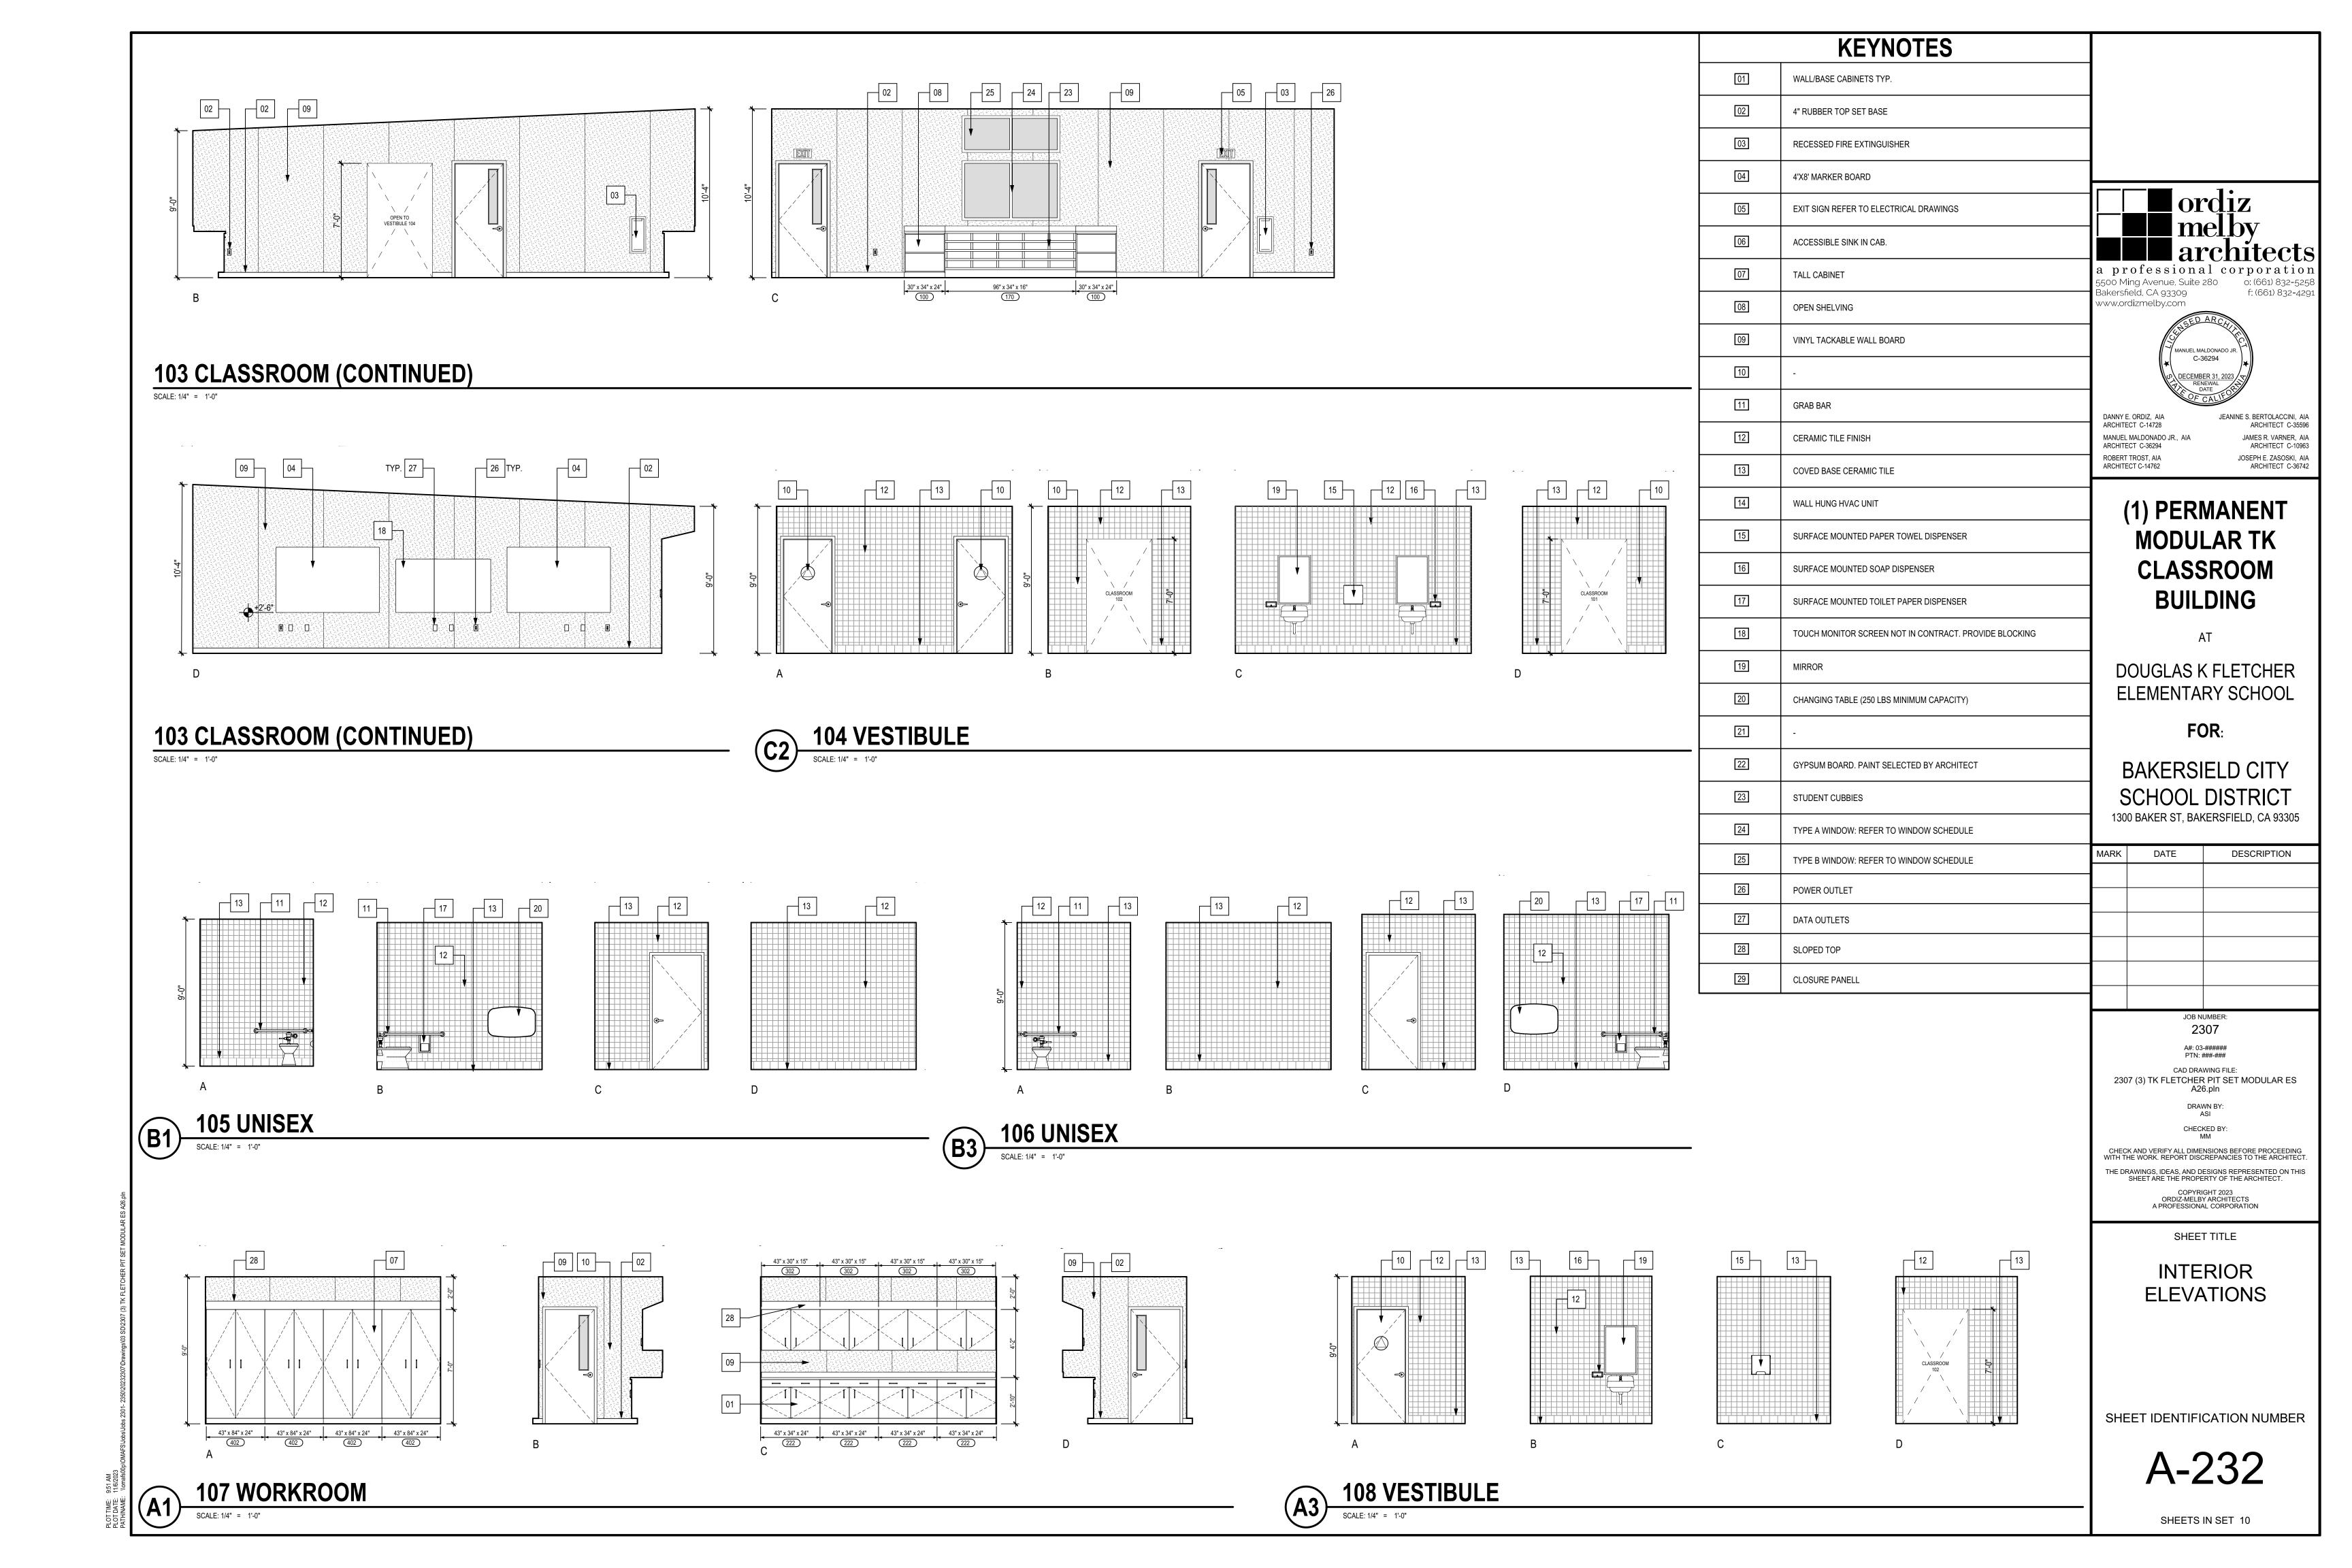

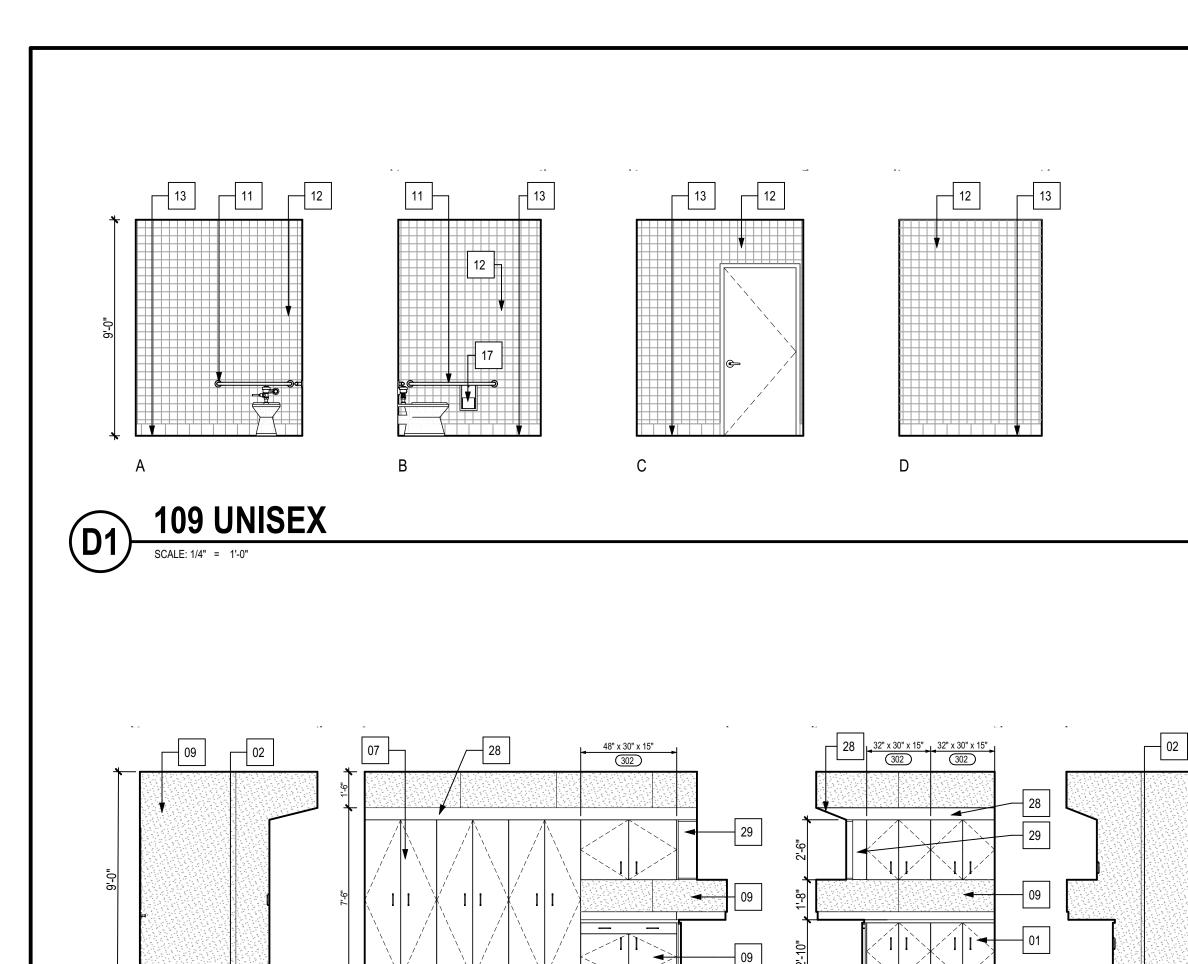


B 402 402 402 402 402 422

110 WORKROOM

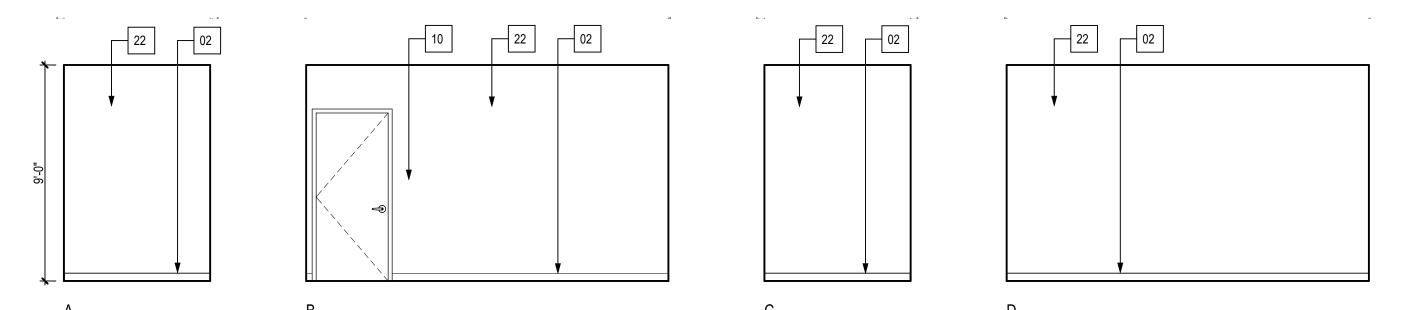

(B1) 111 STORAGE

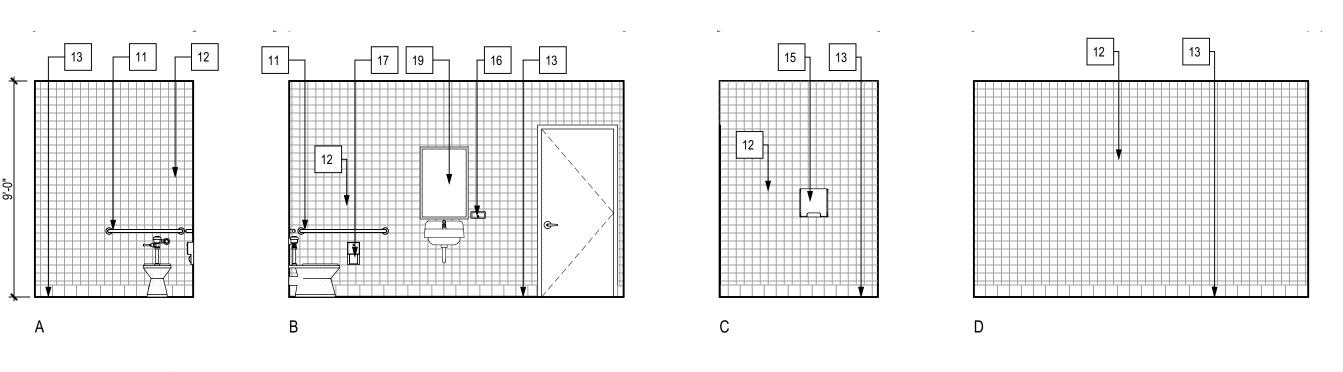

112 UNISE

**KEYNOTES** WALL/BASE CABINETS TYP. 4" RUBBER TOP SET BASE RECESSED FIRE EXTINGUISHER 04 4'X8' MARKER BOARD EXIT SIGN REFER TO ELECTRICAL DRAWINGS ACCESSIBLE SINK IN CAB. 07 TALL CABINET 5500 Ming Avenue, Suite 280 Bakersfield, CA 93309 f: (661) 832**-**429: 08 www.ordizmelby.com OPEN SHELVING 09 VINYL TACKABLE WALL BOARD MANUEL MALDONADO JR. C-36294 10 GRAB BAR JEANINE S. BERTOLACCINI, AIA ARCHITECT C-14728 ARCHITECT C-35596 MANUEL MALDONADO JR., AIA JAMES R. VARNER, AIA CERAMIC TILE FINISH ARCHITECT C-36294 ARCHITECT C-10963 JOSEPH E. ZASOSKI, AIA ARCHITECT C-36742 COVED BASE CERAMIC TILE 14 (1) PERMANENT WALL HUNG HVAC UNIT **MODULAR TK** SURFACE MOUNTED PAPER TOWEL DISPENSER CLASSROOM SURFACE MOUNTED SOAP DISPENSER **BUILDING** SURFACE MOUNTED TOILET PAPER DISPENSER TOUCH MONITOR SCREEN NOT IN CONTRACT. PROVIDE BLOCKING 19 DOUGLAS K FLETCHER **ELEMENTARY SCHOOL** CHANGING TABLE (250 LBS MINIMUM CAPACITY) FOR: BAKERSIELD CITY GYPSUM BOARD. PAINT SELECTED BY ARCHITECT SCHOOL DISTRICT STUDENT CUBBIES 1300 BAKER ST, BAKERSFIELD, CA 93305 TYPE A WINDOW: REFER TO WINDOW SCHEDULE DATE DESCRIPTION TYPE B WINDOW: REFER TO WINDOW SCHEDULE POWER OUTLET DATA OUTLETS SLOPED TOP CLOSURE PANELL 2307 PTN: ###-### CAD DRAWING FILE: 2307 (3) TK FLETCHER PIT SET MODULAR ES A26.pln

> DRAWN BY: ASI CHECKED BY:

CHECK AND VERIFY ALL DIMENSIONS BEFORE PROCEEDING WITH THE WORK. REPORT DISCREPANCIES TO THE ARCHITECT.

THE DRAWINGS, IDEAS, AND DESIGNS REPRESENTED ON THIS SHEET ARE THE PROPERTY OF THE ARCHITECT.

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SHEET TITLE

INTERIOR ELEVATIONS


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A-233


SHEETS IN SET 10

						INTER	RIOR FIN	ISH SCHI	EDULE								
DOOM #	DOOM NAME	FLOOR		BASE		WAINSCOT		WALL A		WALL B		WALL C		WALL D			CEILING
ROOM#	ROOM NAME	MATERIAL	FINISH	MATERIAL	FINISH	MATERIAL	FINISH	MATERIAL	FINISH	MATERIAL	FINISH	MATERIAL	FINISH	MATERIAL	FINISH	MATERIAL	FINISH
101	CLASSROOM	CPT; LVT	FF	RTSB	FF	-	-	VTP	FF	VTP	FF	VTP	FF	VTP	FF	ACT	P1
102	CLASSROOM	CPT; LVT	FF	RTSB	FF	-	-	VTP	FF	VTP	FF	VTP	FF	VTP	FF	ACT	P1
103	CLASSROOM	CPT; LVT	FF	RTSB	FF	-	-	VTP	FF	VTP	FF	VTP	FF	VTP	FF	ACT	P1
104	VESTIBULE	СТ	FF	СТ	FF	-	-	VPT	FF	VPT	FF	VPT	FF	VPT	FF	GYP	P2
105	UNISEX	СТ	FF	СТ	FF	-	-	СТ	FF	СТ	FF	СТ	FF	СТ	FF	GYP	P2
106	UNISEX	СТ	FF	СТ	FF	-	-	СТ	FF	СТ	FF	СТ	FF	СТ	FF	GYP	P2
107	WORKROOM	СРТ	FF	RTSB	FF	-	-	VTP	FF	VTP	FF	VTP	FF	VTP	FF	ACT	P1
108	VESTIBULE	СТ	FF	СТ	FF	-	-	VTP	FF	VTP	FF	VTP	FF	VTP	FF	GYP	P2
109	UNISEX	СТ	FF	СТ	FF	-	-	FRP	FF	FRP	FF	FRP	FF	FRP	FF	GYP	P2
110	WORKROOM	СРТ	FF	RTSB	FF	-	-	VTP	FF	VTP	FF	VTP	FF	VTP	FF	GYP	FF
111	STORAGE	CONC	S	RTSB	FF	-	-	GYP	P1	GYP	FF	GYP	FF	GYP	FF	GYP	P1
112	UNISEX	СТ	FF	СТ	FF	-	-	СТ	FF	СТ	FF	СТ	FF	СТ	FF	GYP	P2

								DOOR	AND FRA	ME SCH	EDULE				
				DOOR	<u> </u>						POOR HARDWARE				
DOOR	TYPE		SIZE		MATERIAL	EINIIGH	MATERIAL	EINIGH		DETAIL		DOOR	SET NO	PANIC	REMARKS
		W	HT	THK	MATERIAL	FINISH	MATERIAL	FINISH	HEAD	JAMB	SILL		NG SET NO.	PANIC	
101a	В	3'-0"	7'-0"	1 3/4"	НМ	P2	НМ	P2	-	-	-	-	SET NO. 01	YES	REFER TO DESIGN NARRATIVE FOR HARDWARE SET SPECIFICATIONS: SET NO. 01
101b	В	3'-0"	7'-0"	1 3/4"	НМ	P2	НМ	P2	-	-	-	-	SET NO. 01	YES	REFER TO DESIGN NARRATIVE FOR HARDWARE SET SPECIFICATIONS: SET NO. 01
102a	В	3'-0"	7'-0"	1 3/4"	НМ	P2	НМ	P2	-	-	-	-	SET NO. 01	YES	REFER TO DESIGN NARRATIVE FOR HARDWARE SET SPECIFICATIONS: SET NO. 01
102b	В	3'-0"	7'-0"	1 3/4"	НМ	P2	НМ	P2	-	-	-	-	SET NO. 01	YES	REFER TO DESIGN NARRATIVE FOR HARDWARE SET SPECIFICATIONS: SET NO. 01
103a	В	3'-0"	7'-0"	1 3/4"	НМ	P2	НМ	P2	-	-	-	-	SET NO. 01	YES	REFER TO DESIGN NARRATIVE FOR HARDWARE SET SPECIFICATIONS: SET NO. 01
103b	В	3'-0"	7'-0"	1 3/4"	НМ	P2	НМ	P2	-	-	-	-	SET NO. 01	YES	REFER TO DESIGN NARRATIVE FOR HARDWARE SET SPECIFICATIONS: SET NO. 01
105a	А	3'-0"	7'-0"	1 3/4"	SC WD	FF	НМ	P2	-	-	-	-	SET NO. 02	-	REFER TO DESIGN NARRATIVE FOR HARDWARE SET SPECIFICATIONS: SET NO. 02
106a	А	3'-0"	7'-0"	1 3/4"	SC WD	FF	НМ	P2	-	-	-	-	SET NO. 02	-	REFER TO DESIGN NARRATIVE FOR HARDWARE SET SPECIFICATIONS: SET NO. 02
107a	В	3'-0"	7'-0"	1 3/4"	SC WD	FF	НМ	P2	-	-	-	-	SET NO. 03	-	REFER TO DESIGN NARRATIVE FOR HARDWARE SET SPECIFICATIONS: SET NO. 03
107b	В	3'-0"	7'-0"	1 3/4"	SC WD	FF	НМ	P2	-	-	-	-	SET NO. 03	-	REFER TO DESIGN NARRATIVE FOR HARDWARE SET SPECIFICATIONS: SET NO. 03
109a	А	3'-0"	7'-0"	1 3/4"	SC WD	FF	НМ	P2	-	-	-	-	SET NO. 02	-	REFER TO DESIGN NARRATIVE FOR HARDWARE SET SPECIFICATIONS: SET NO. 02
110a	В	3'-0"	7'-0"	1 3/4"	SC WD	FF	НМ	P2	-	-	-	-	SET NO. 03	-	REFER TO DESIGN NARRATIVE FOR HARDWARE SET SPECIFICATIONS: SET NO. 03
111a	А	3'-0"	7'-0"	1 3/4"	НМ	P2	НМ	P2	-	-	-	-	SET NO. 04	-	REFER TO DESIGN NARRATIVE FOR HARDWARE SET SPECIFICATIONS: SET NO. 04
112a	А	3'-0"	7'-0"	1 3/4"	НМ	P2	НМ	P2	-	-	-	-	SET NO. 05	-	REFER TO DESIGN NARRATIVE FOR HARDWARE SET SPECIFICATIONS: SET NO. 05

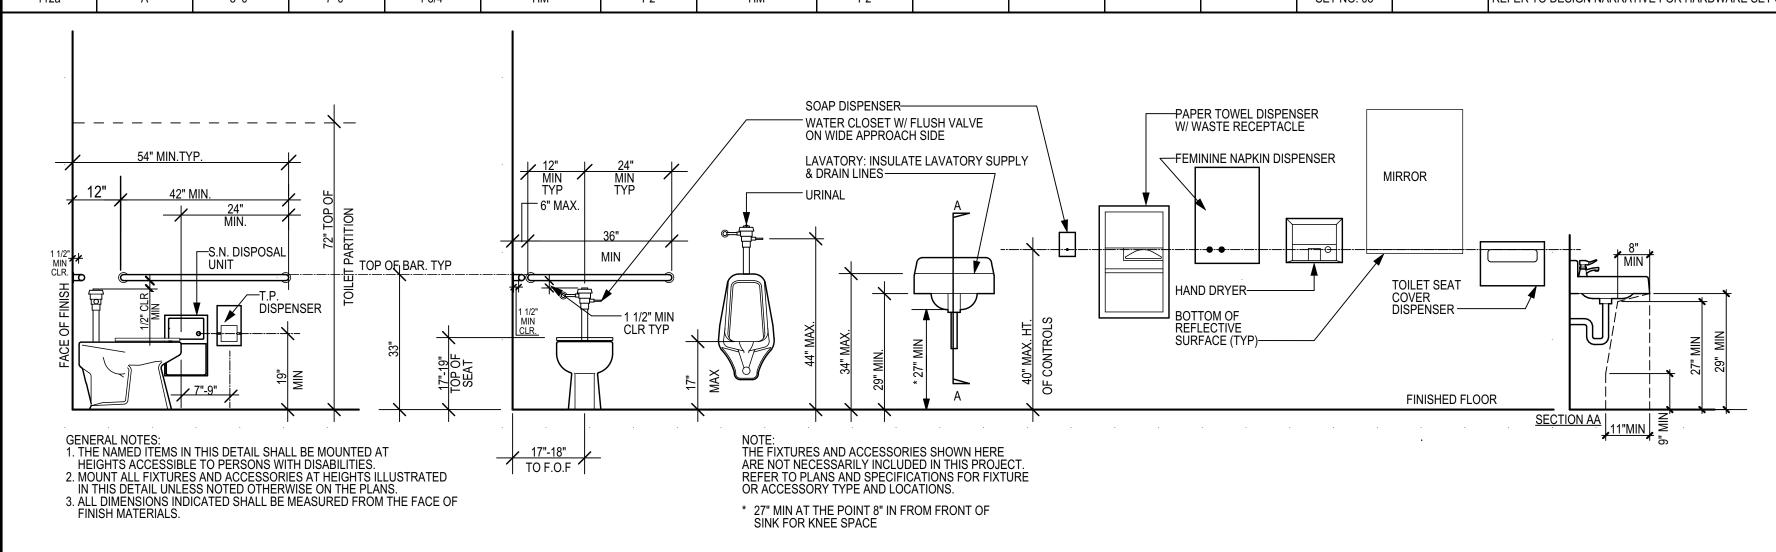

#### ACCESSORY MOUNTING HEIGHT (ADULT)

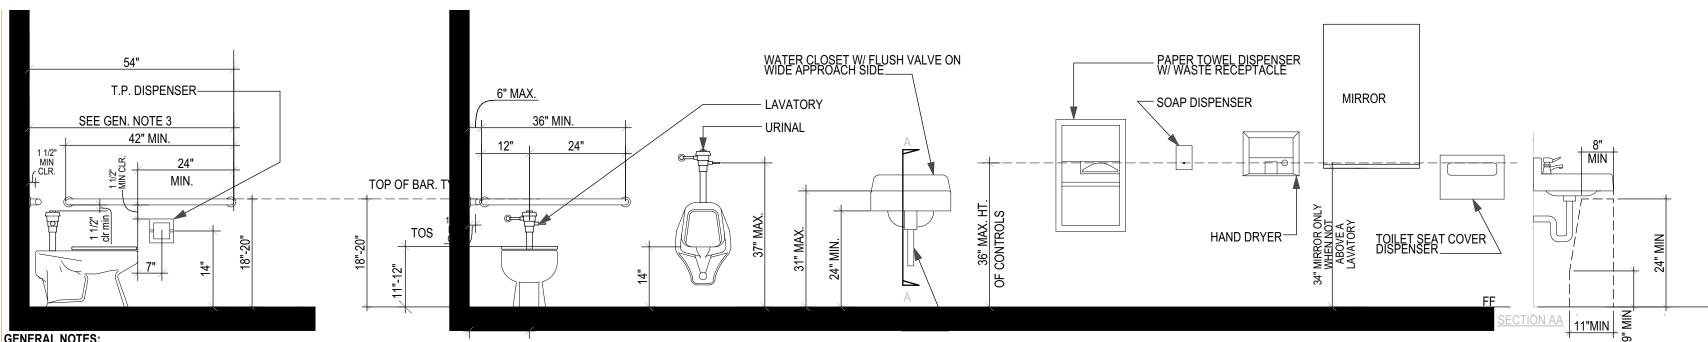

GENERAL NOTES:

1. THE NAMED ITEMS IN THIS DETAIL SHALL BE MOUNTED AT HEIGHTS ACCESSIBLE TO PERSONS WITH DISABILITIES.
2. MOUNT ALL FIXTURES AND ACCESSORIES AT HEIGHTS ILLUSTRATED IN THIS DETAIL UNLESS NOTED OTHERWISE ON THE PLANS.
3. ALL DIMENSIONS INDICATED SHALL BE MEASURED FROM THE FACE OF FINISH MATERIALS.
4. THE FIXTURES AND ACCESSORIES SHOWN HEREIN ARE NOT NECESSARILY INCLUDED IN THIS PROJECT. REFER TO PLANS AND SPECIFICATIONS FOR FIXTURE OR ACCESSORY TYPE AND LOCATIONS.

SCALE: 1/2" = 1'-0"

ACCESSORY MOUNTING HEIGHT (AGE 3-4)


FIBERGLASS REINFORCED PLASTIC RTSB RUBBER TOP SET BASE CT CERAMIC TILE GYP GYPSUM BOARD VTP VINYL TACKBOARD PANELS ACT ACOUSTIC CEILING TILE FACTORY FINISH PAINT-EGGSHELL FINISH PAINT-SEMI GLOSS HM **HOLLOW METAL** SOLID CORE WD WOOD DOOR CONC CONCRETE SEALED **GLAZING TYPES** GLASS TYPE 'A' (EXTERIOR)
DOUBLE PANE GLAZING (1" INSULATED GLAZING LOW E UNIT). GLASS TYPE 'B' (INTERIOR) 1/4" INCH CLEAR FLOAT GLASS.

**MATERIAL KEY** 

CARPET TILE SQUARES

CPT

WINDOW	TYPE LEGE	ND	
ID	W1	W2	
VIEW	6-0° 6-0° F.F.	60"  -60"  -60"	MA
MATERIAL	HOLLOW METAL	HOLLOW METAL	
FINISH	PAINTED	PAINTED	
COLOR	SELECTED BY ARCHITECT	SELECTED BY ARCHITECT	$\vdash$
GLASS TYPE	TYPE A	TYPE A	

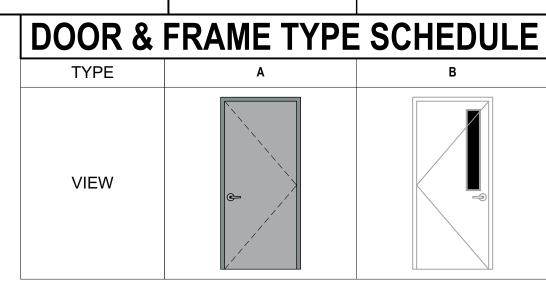

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# (1) PERMANENT MODULAR TK CLASSROOM BUILDING

ΑT

DOUGLAS K FLETCHER ELEMENTARY SCHOOL

FOR:

## BAKERSIELD CITY SCHOOL DISTRICT

1300 BAKER ST, BAKERSFIELD, CA 93305

	MARK	DATE	DESCRIPTION							
CT			UMBER:							
	2307									
	V#- U3 ######									

A#: 03-#####
PTN: ###-##

CAD DRAWING FILE:

2307 (3) TK FLETCHER PIT SET MODULAR ES
A26.pln

DRAWN BY:
ASI

CHECKED BY:

CHECK AND VERIFY ALL DIMENSIONS BEFORE PROCEEDING WITH THE WORK. REPORT DISCREPANCIES TO THE ARCHITECT.

THE DRAWINGS, IDEAS, AND DESIGNS REPRESENTED ON THIS SHEET ARE THE PROPERTY OF THE ARCHITECT.

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SHEET TITLE

DOOR & WINDOW SCHEDULES

SHEET IDENTIFICATION NUMBER

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SHEETS IN SET 10